



NEWBURYPORT YOUTH SERVICES

59 LOW STREET NEWBURYPORT, MA 01950

DESIGN DEVELOPMENT SUBMISSION 09-07-2023

OWNER:

CITY OF NEWBURYPORT 60 PLEASANT ST NEWBURYPORT, MA 01950 (978) 465-4413

MEP ENGINEER:

BLW ENGINEERS, INC. 311 GREAT ROAD PO BOX 1551 LITTLETON, MA 01460 (978) 486-4301

ARCHITECT:

EGA ARCHITECTS, P.C. 12 AUBURN STREET NEWBURYPORT, MA 01950 (978) 462-5515

ACOUSTICAL ENGINEER:

CAVANAUGH TOCCI ASSOC. 327 Boston Post Rd # F, Sudbury, MA 01776 (978) 443-7871

STRUCTURAL ENGINEER:

SHELLEY ENGINEERING PO BOX 1030, GRAY, ME 04039 (207) 657-8031

INTERIOR DESIGNER:

WELLESLEY DESIGN CONSULTANTS 200 MERRIMACK ST, 4TH FLOOR HAVERHILL, MA 01830 (978) 965-8185



STRUCTURAL ENGINEER:
Shelley Engineering
MEP ENGINEER:
BLW Engineers
INTERIOR DESIGNER:


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Cover
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A-000.0



DRAWING LIST


	_Architectural Drawing List			_Structural Drawing List				_Mechanical Drawing List			_Plumbing Dra	wing List	
Sheet		Sheet	Sheet		Sheet Issue	Sheet	Sheet		Sheet	Sheet		Sheet	
Number	Sheet Name	Issue Date	Number	Sheet Name	Date	Order	Number	Sheet Name	Issue Date	Number	Sheet Na	me Issue Date	
A-000.0	Cover	09/07/23	S-1.0	Foundation Plan	09/07/23	M001	H-001	Legends, Notes and Abbreviation	ns 09/07/23	P-001	Legend, Notes and Abbre		
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A-002.0	Life Safety and Code Analysis	09/07/23	S-3.0	Details	09/07/23	M003	H-003	HVAC Details Sheet 1	09/07/23	P-003	Details	09/07/23	
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A-106.0	Roof Plan	09/07/23				M007	H-202	Gymnasium Ductwork	09/07/23	P-104	Roof Plan	09/07/23	
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A-700.0	Interior Elevations	09/07/23	ID-1.0	Furniture Plan	09/07/23	E-001	Electrical L	_	09/07/23	FP001		on Legend, Notes and Abbreviations	09/07/23
			ID-2.1	Floor Finish Plan	09/07/23	E-002	Specification		09/07/23	FP002	FP-101 Fire Protection	on First Floor Plan	09/07/23
			ID-2.2	Wall Accent Finish Plan	09/07/23	E-003	Riser Diagr	rams and Schedules	09/07/23	FP003	FP-102 Fire Protection	on Gymnasium Plan	09/07/23
						E-004	Details		09/07/23	FP004	FP-103 Fire Protection	on Second Floor Plan	09/07/23
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						E-102	Gymnasiun	n Lighting	09/07/23				
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						E-202	Gymnasiun	n Power	09/07/23				
						E-203	Second Flo	oor Power	09/07/23				
						FA-001	Legend, Ri	iser and Notes	09/07/23				

First Floor Plan Gymnasium Plan

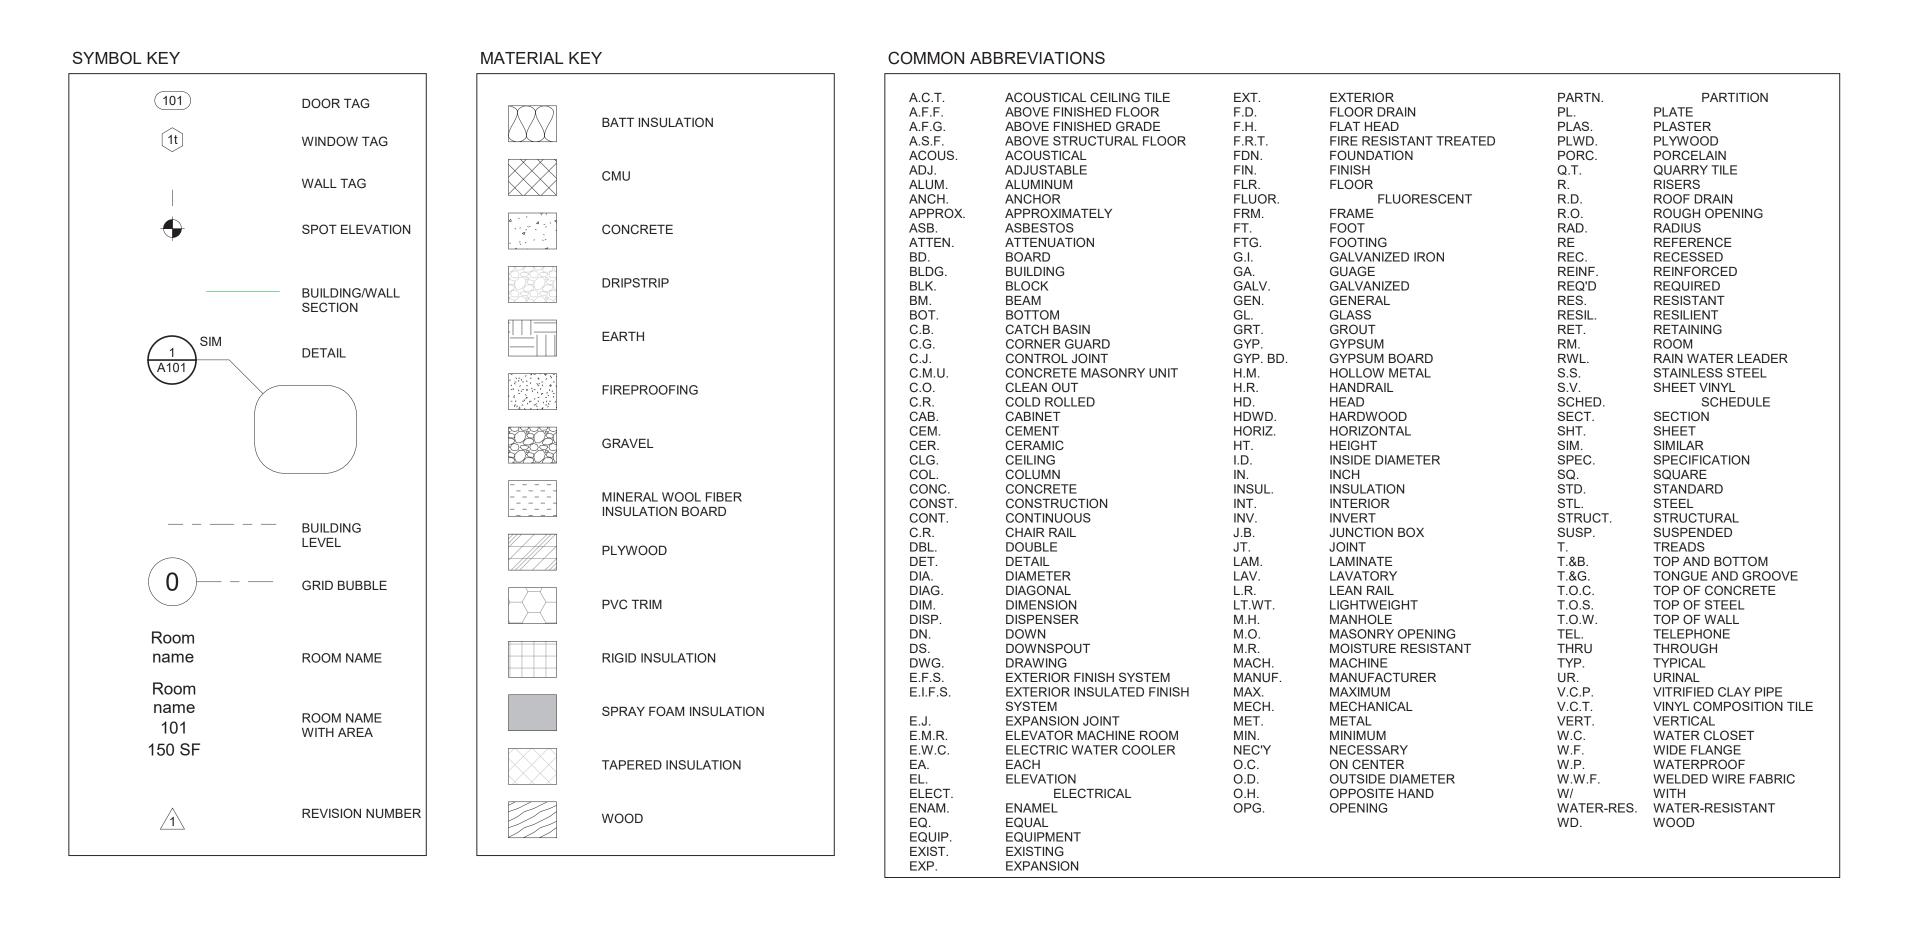Second Floor Plan

09/07/23

09/07/23 09/07/23

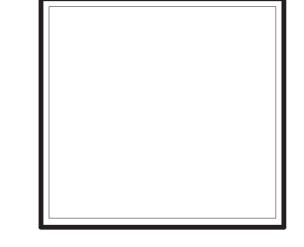



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BLW Engineers
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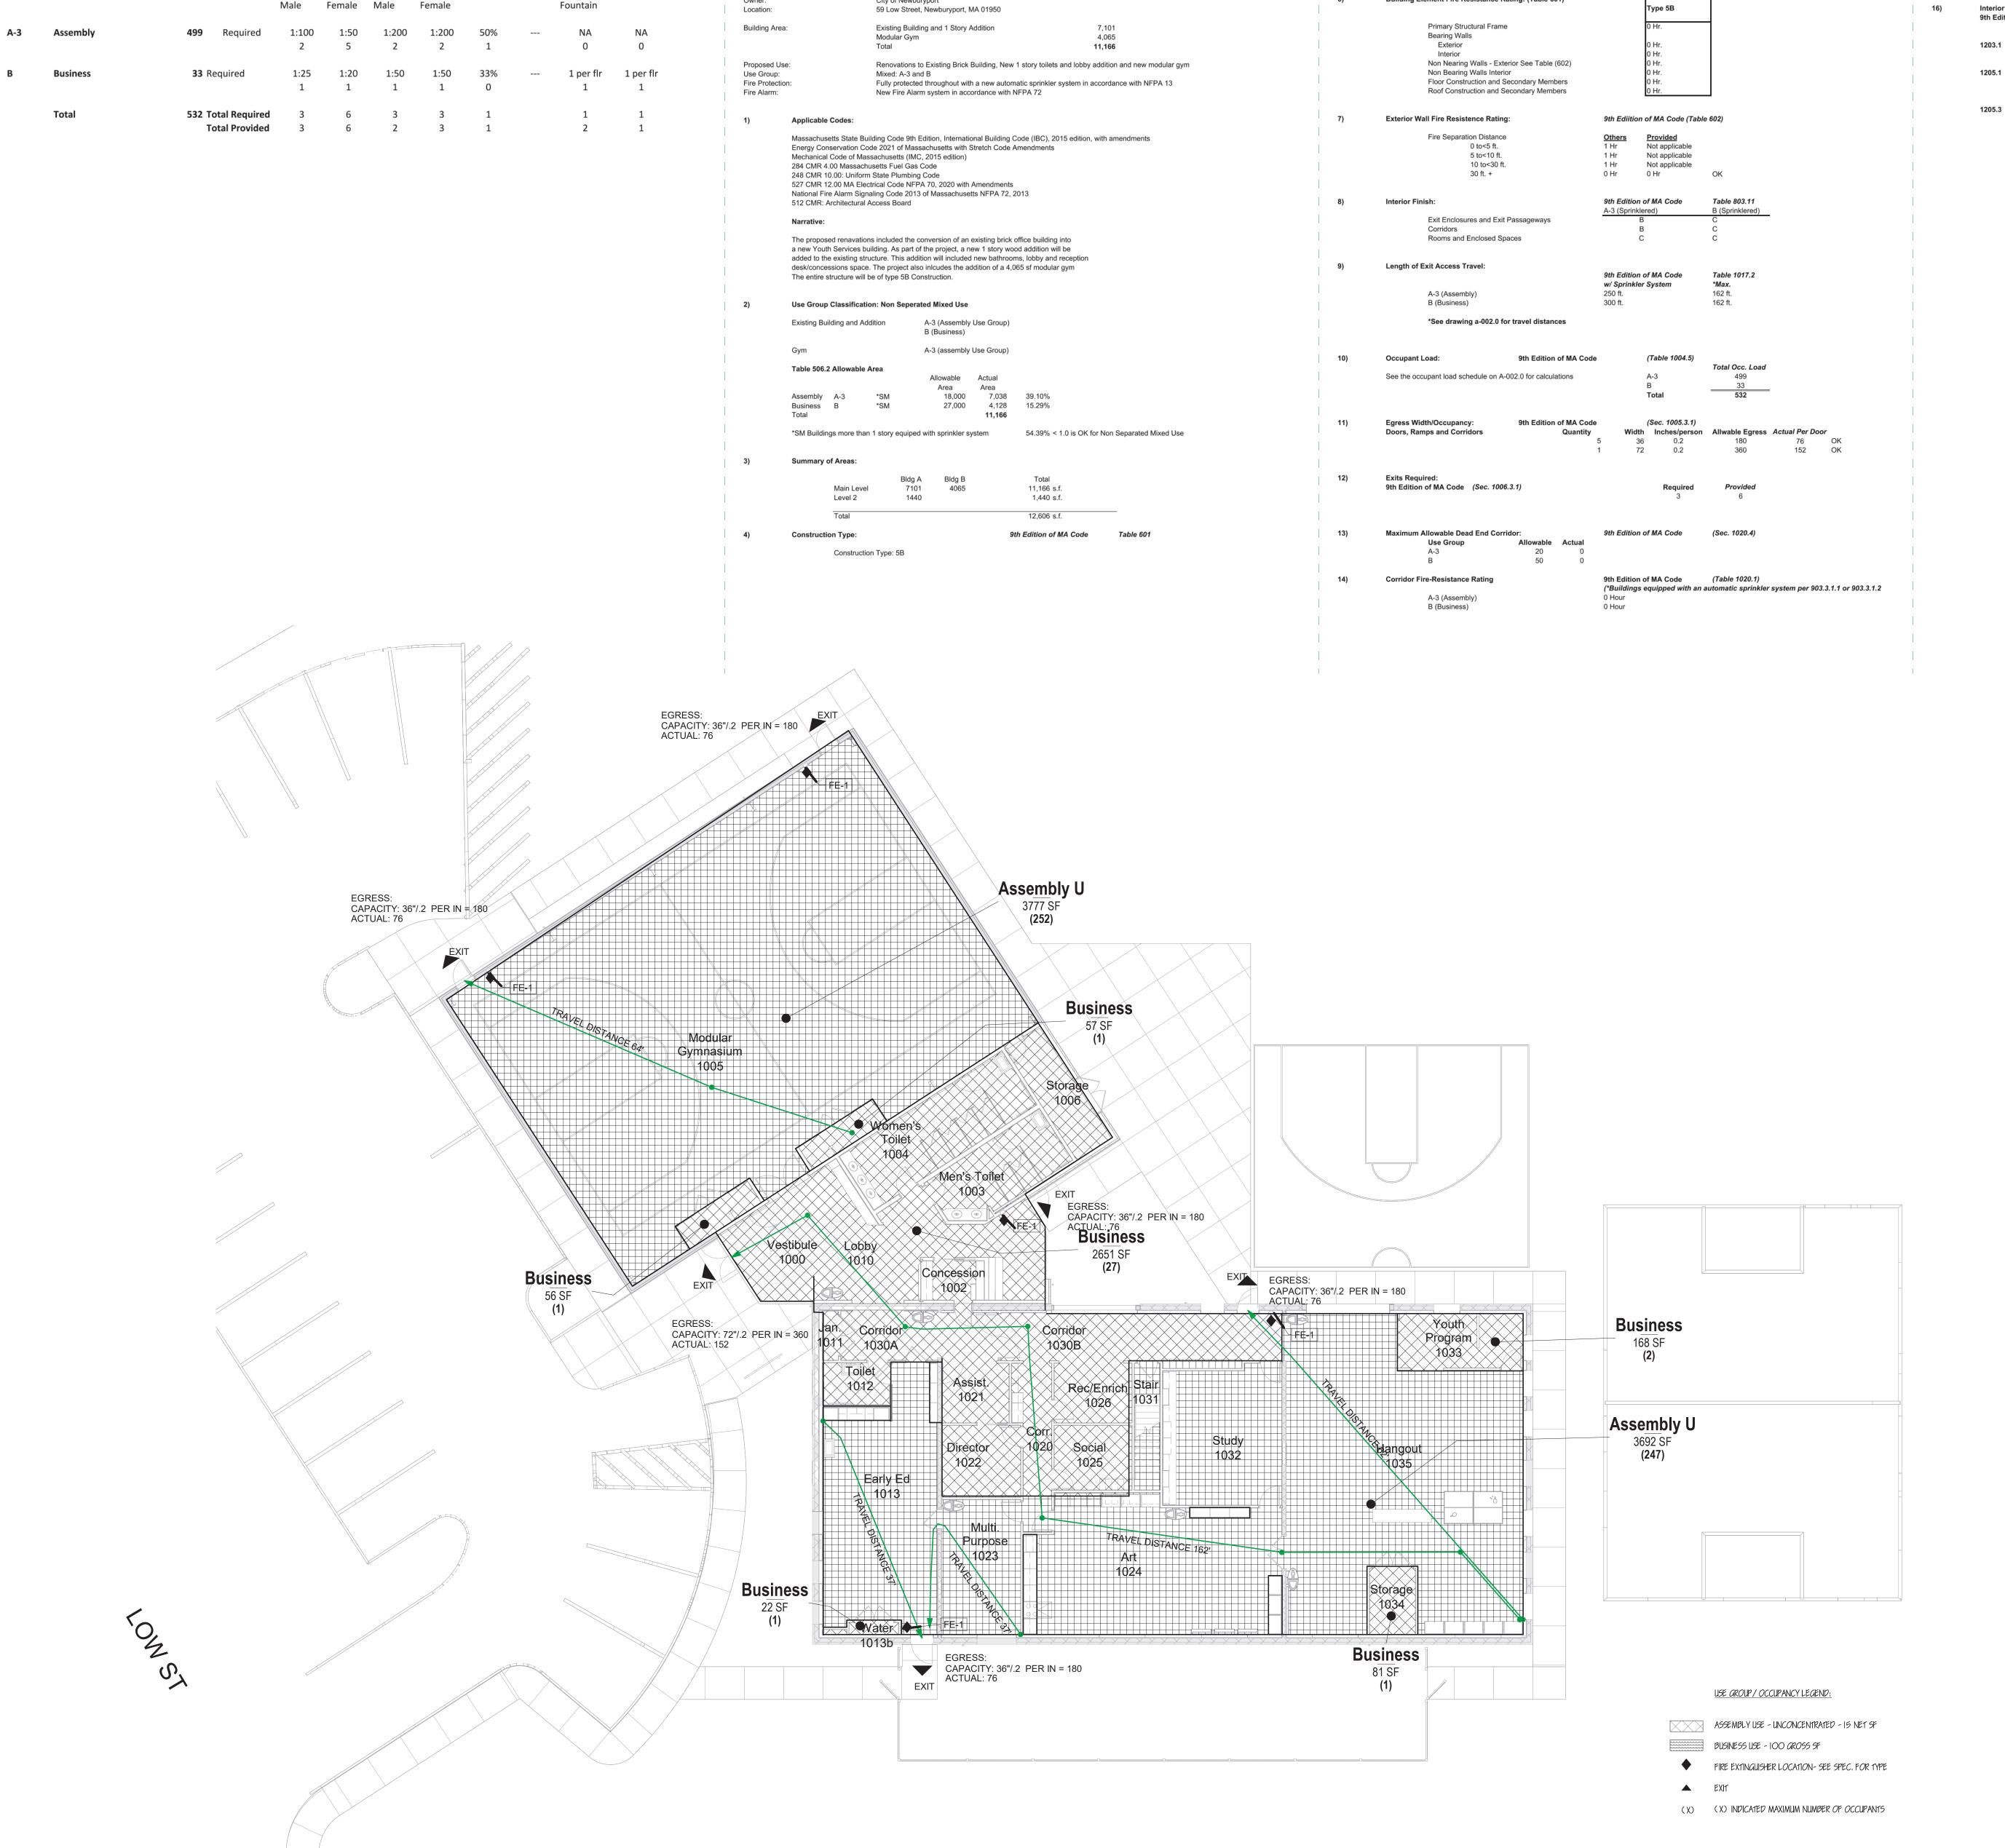
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Project Drawing List

Sheet Number:



Life Safety & Building Code Analysis

Newburyport Youth Services

Scott Hall

City of Newburyport

Prepared By:

59 LOW STREET, NEWBURYPORT, MA 01950 - PLUMBING FIXTURE ANALYSIS

Lavatories Urinals Showers Drinking Service

1 Floor 1 3/32" = 1'-0"

Water Closet

Occupants

Minimum Corridor Width: Required Min. Provided
9th Edition of MA Code (Table 1020.2) 44" 44"

9th Edition of MA Code (Sections 1203-120

A new fully automatic sprinkler system shall be installed.

Building Element Fire Resistance Rating: (Table 601)

9th Edition of MA Code

Buildings shall be provided with natural ventilation in accordance with Section 1203.5, or mechanical ventilation in accordance with the International Mechanical Code.

1205.1 Every space intended for human occupancy shall be provided with natural light by means of exterior glazed openings in accordance with Section 1205.2 or shall be provided with artificial light in accordance with Section 1205.3. Exterior glazed openings shall open directly onto a public way or onto a yard or court in accordance with Section 1206.

Life Safety - Occupancy Load Table

22 SF

56 SF

57 SF

81 SF

168 SF

2651 SF 27

Name

Assembly U

Assembly U

Business

Business

Business

Business

Floor 1

Grand total: 8

Area Number

532

3692 SF 247

3777 SF 252

Factor

100

100

100

Artificial light shall be provided that is adequate to provide an average illumination of 10 footcandles (107 lux) over the area of the room at a height of 30 inches (762 mm) above the floor level.

A R C H I T E C T S

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Building Key:	

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Life Safety and Code Analysis	
Sheet Number: A-002.0	

2) DEMO ALL PLUMBING AND PIPING THROUGHOUT EXISTING BUILDING CUT AND CAP WASTE LINES BELOW SLAB 3) DEMO ALL ELECTRICAL ITEMS INCLUDING SERVICE, PANELS, BRANCH WIRING, CONDUIT, WIRING DEVICES BOXES AS WELL AS ALL LIGHTING 4) DEMO ALL ACOUSTICAL TILE CEILINGS IN ALL ROOMS AS WELL AS 10" BATT INSULATION LAYING ON TOP OF CEILINGS (GARAGE AREAS HAVE NO CEILINGS) 5) DEMO GAS SERVICE AND ALL GAS DEMO EXISTING DOOR AND FRAME -SOLID SURFACE COUNTER DEMO (E) WINDOWS -INFILL CMU/BRICK DEMO (E) WINDOW AT GARAGE DOOR (E) MASONRY NEW STL LINTEL | | NEW STL LINTEL AT OPENING -AT OPENING F | = = = = | - CUT OPENING FOR DEMO ENTRY NEW CORRIDOR VESTIBULE DEMO (E) WINDOWS AND BLOCK - DEMO HALF WALL DEMO (E) GARAGE UP OPENINGS (E) MASONRY PIER — - MOVABLE PARTIONS (NIC) CITY TO PROVIDE - INFILL CMU
 AT DEMOLISHED
 DOOR F===# _____| DEMO (E) GARAGE DEMO ALL EXISTING GWB DEMO (E) DOOR AND FRAME AND BLOCK WALLS AND STUDS -UP OPENING DEMO ELECTRICAL SERVICES MOUNTED ON EXTERIOR WALL — - DEMO 8" CMU WALL DEMO 4" CONCRETE L|-----E=====4 FOLDING PARTITION (E) MASONRY PIER ———— — DEMO (E) GWB WALLS` DEMO (E) F======== WINDOWS -DEMO EXISTING WINDOW SAW CUT WALL TO ENLARGE WINDOW OPENINGS DOWN TO GROUND (6 LOCATIONS) — DEMO (E) TOILET, IN IT'S ENTIRETY - DEMO MECHANICAL UNITS AND ASSOCIATED DUCTWORK DEMO (E) WATER SERVICE — - STORAGE CABINETS STORAGE CABINETS — TO RUN DATA AND
POSER TO WALL
MOUNTED TELEVISION DEMO EXISTING SHOWER AND ASSOC PIPING

5

Floor 1 Plan CDs - Demo Plan

1/4" = 1'-0"

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NOTES:

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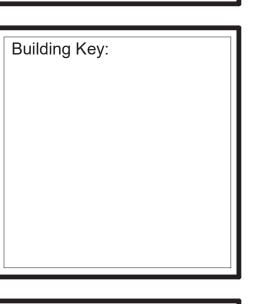
1) DEMO ENTIRE EXISTING MECHANICAL SYSTEM

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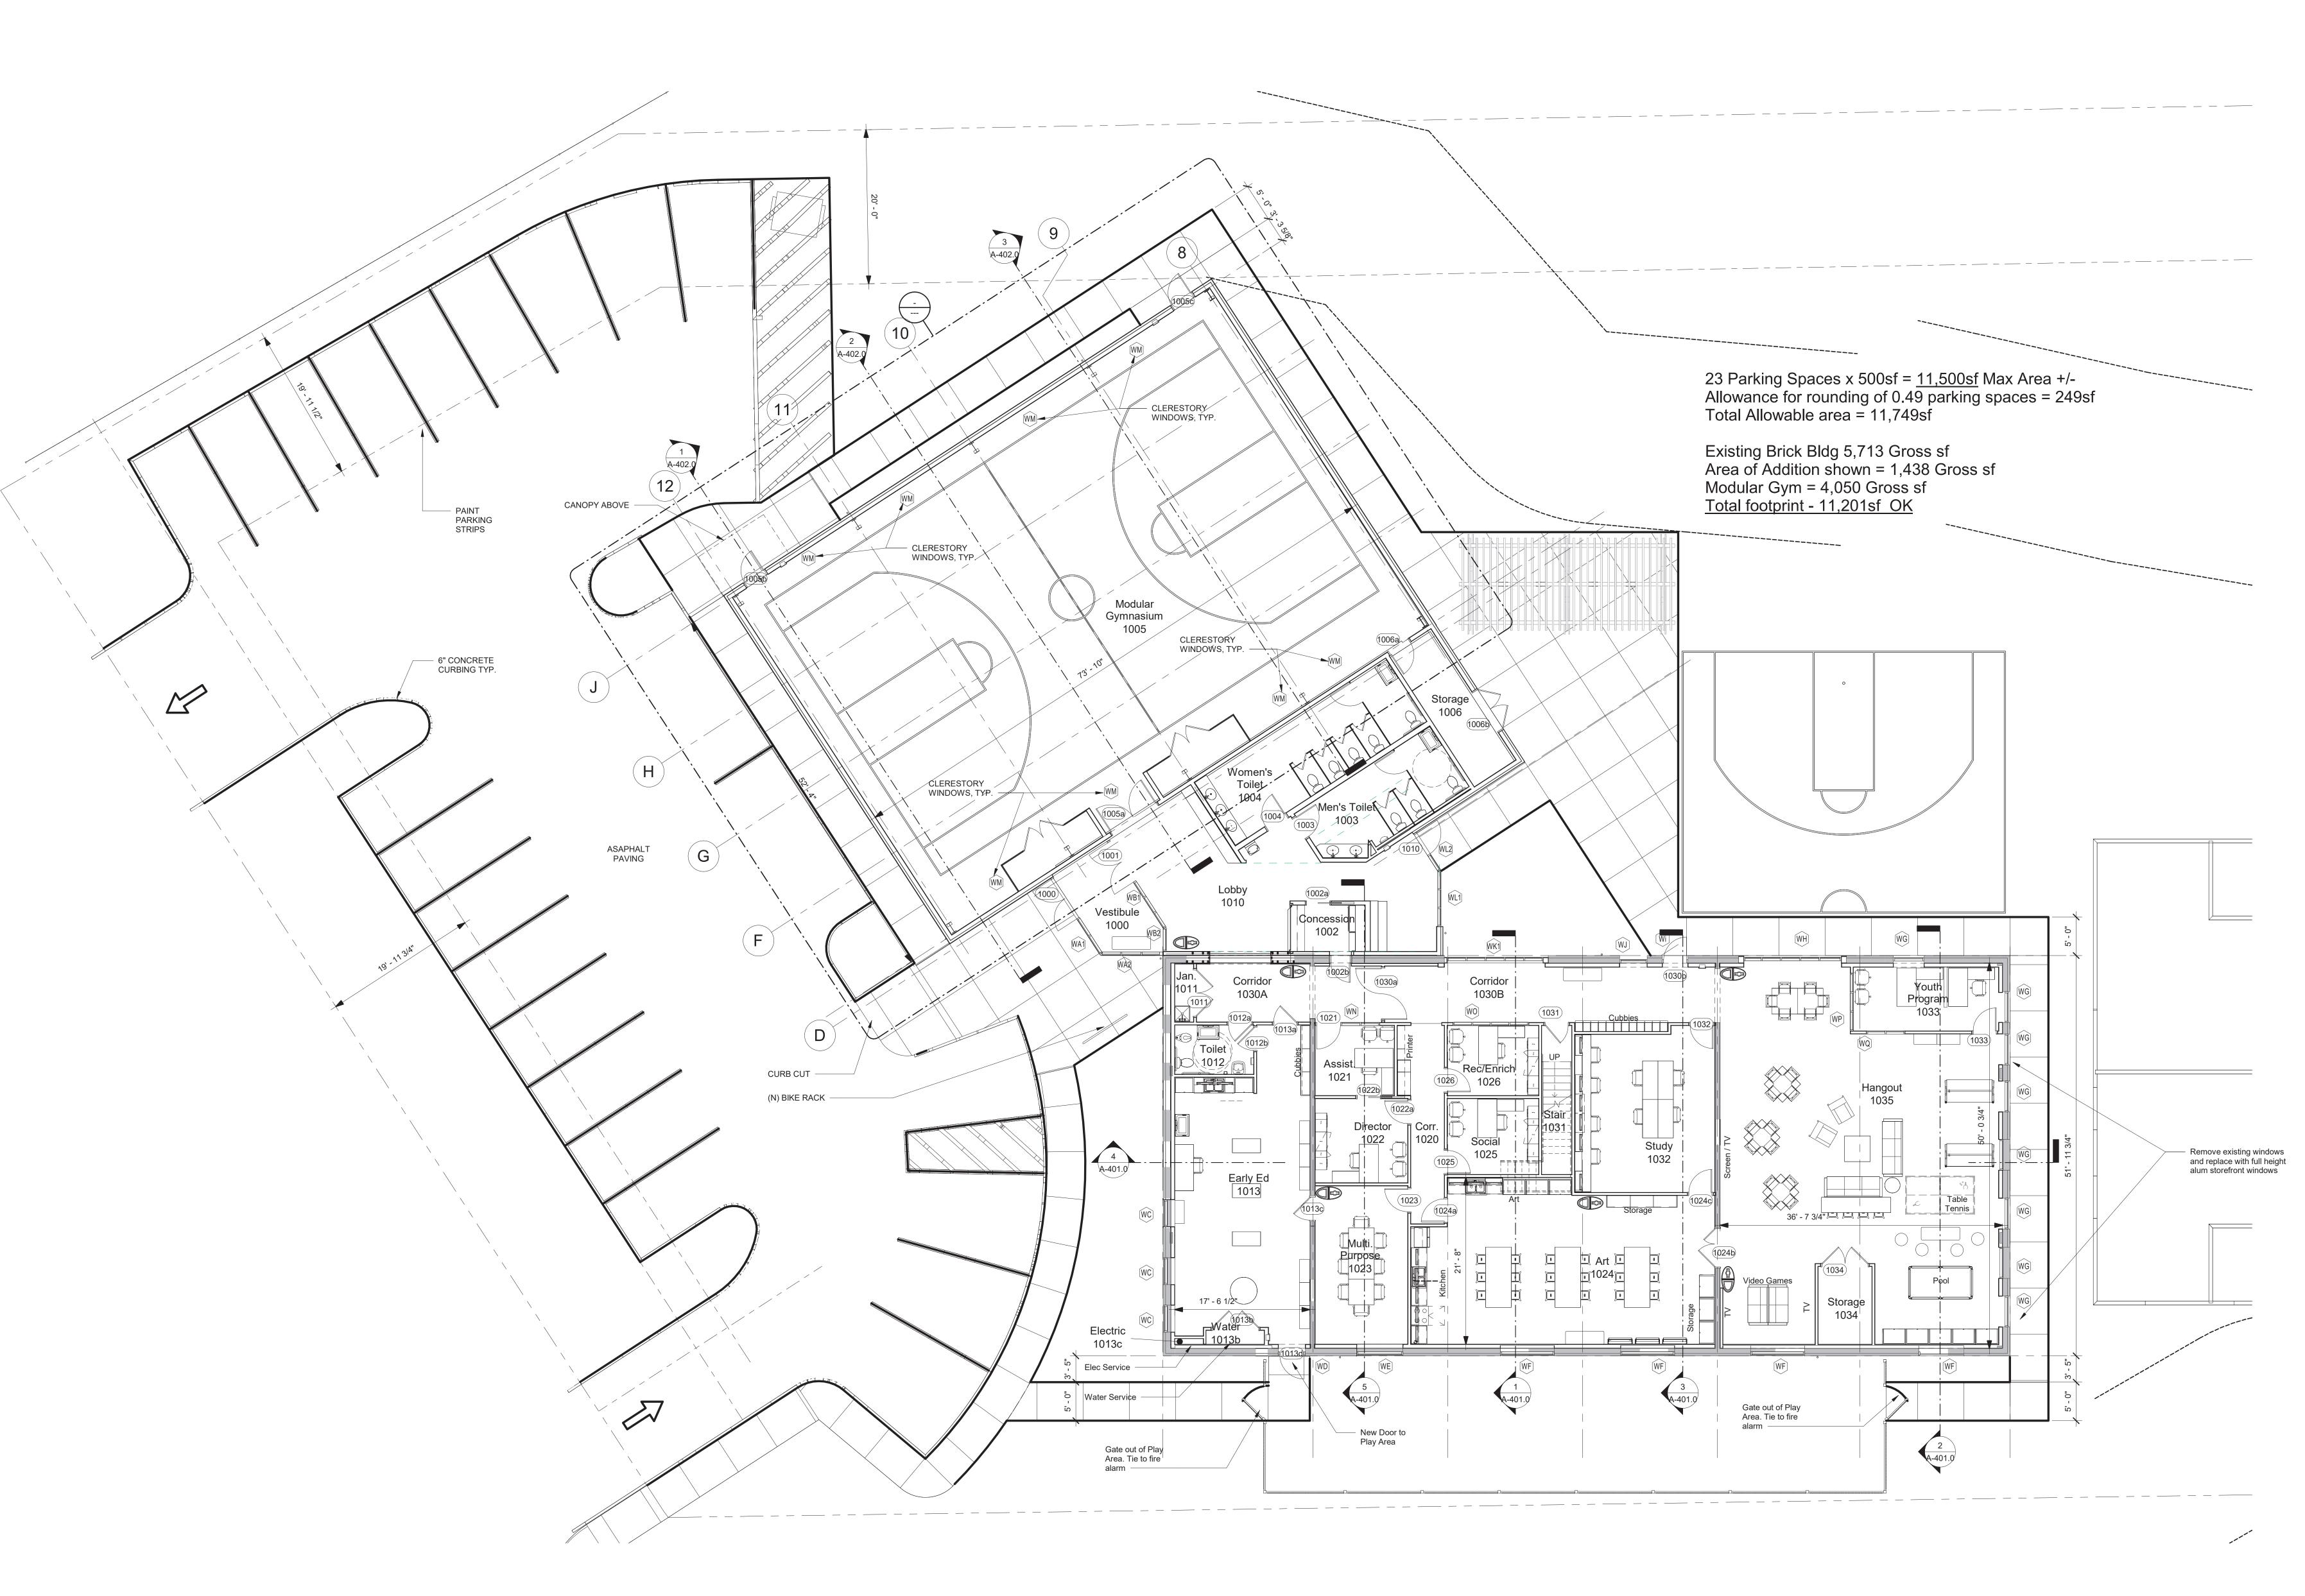
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Sheet Title:

First Floor Demolition Plan

Sheet Number: A-102.0





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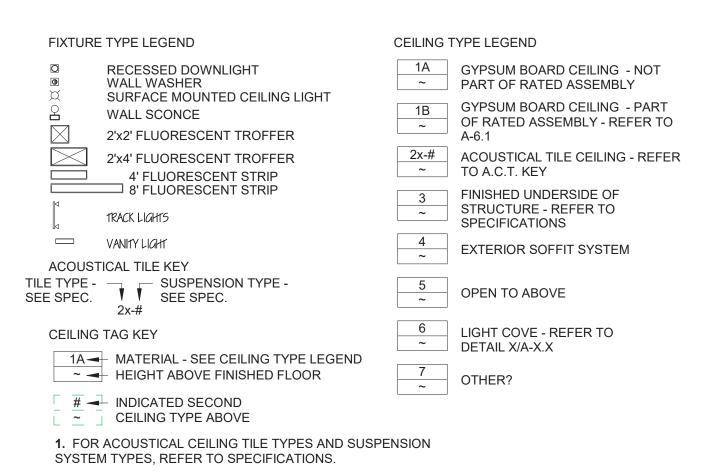
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Building Key.

Sheet Title:
First Floor Overall Plan
Sheet Number:

A-103.0



REFLECTED CEILING PLAN NOTES:


1. SPRINKLER HEADS ARE NOT SHOWN. SPRINKLER CONTRACTOR TO SUBMIT LAYOUT FOR REVIEW & COORDINATION W/ OTHER TRADES.


2. ELECTRICAL FIXTURES SHOWN ARE FOR LOCATION & COORDINATION ONLY - REFER TO ELECTRICAL DRAWINGS.

3. PROVIDE ATTIC ACCESS PANELS TO ALL CONCEALED ROOF TRUSS SMOKE COMPARTMENTS. COORDINATE LOCATIONS WITH ARCHITECT IF NOT LOCATED

4. PLACEMENT & LAYOUT OF EQUIPMENT TO BE AS FOLLOWS

4.A. SPRINKLER HEAD IN A.C.T. - CENTERED IN PANEL
4.B. SPRINKLER HEAD IN GYPSUM WALLBOARD - ALIGN WITH NEARBY LIGHT FIXTURES

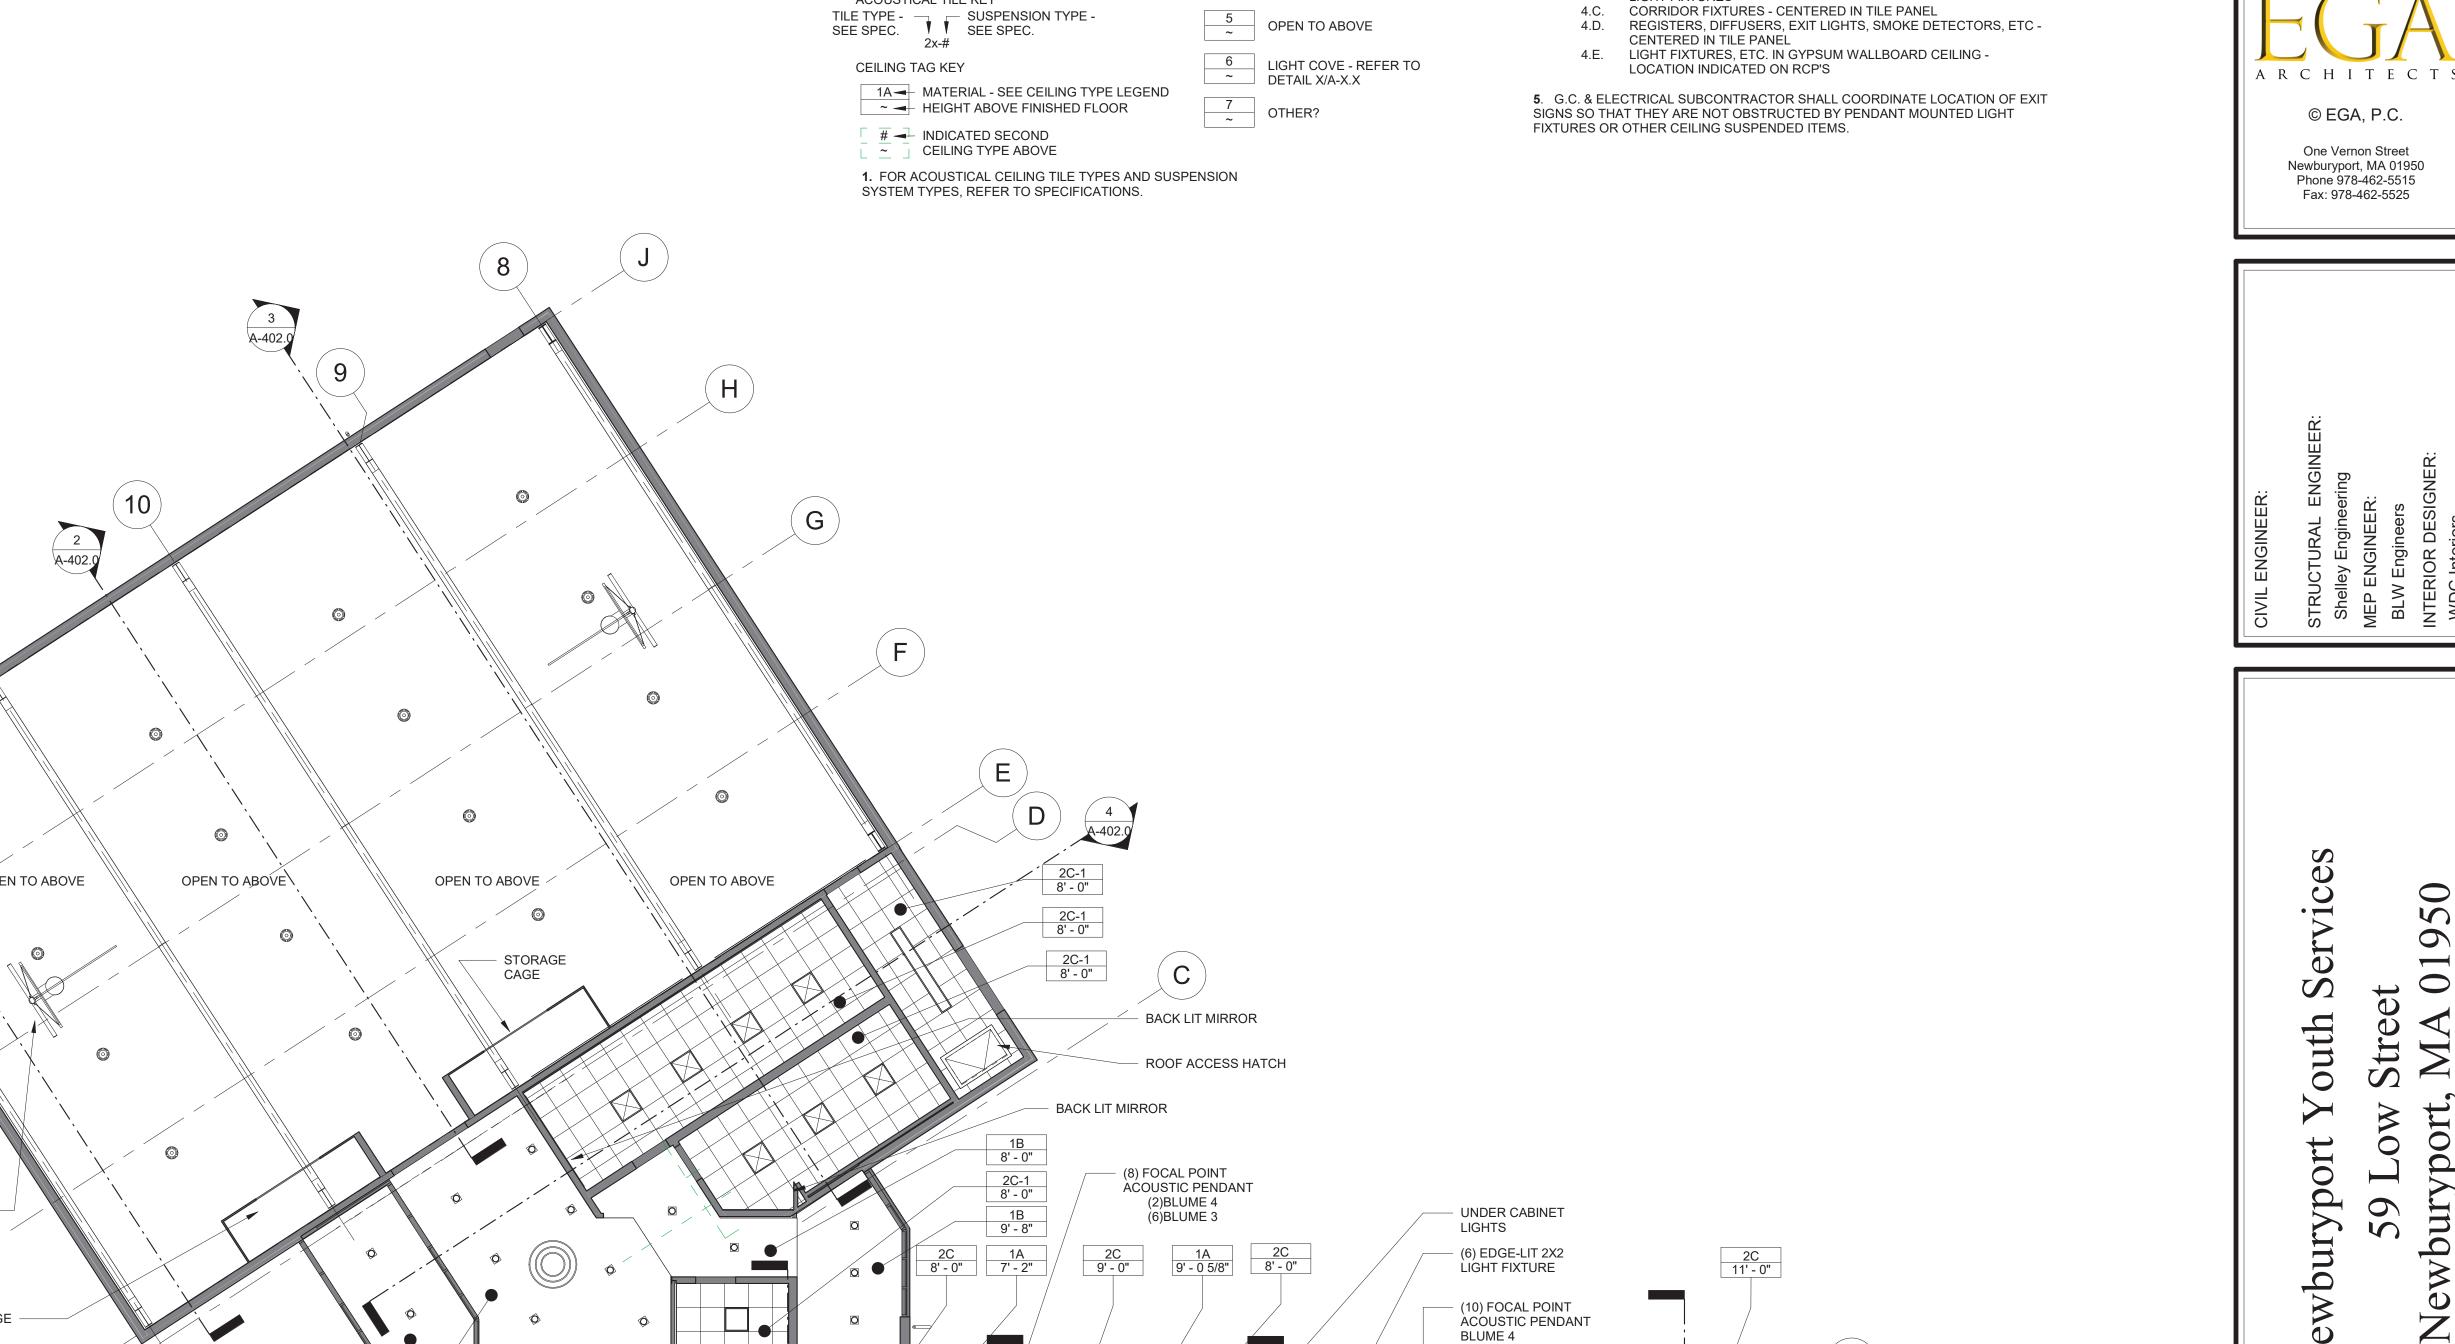

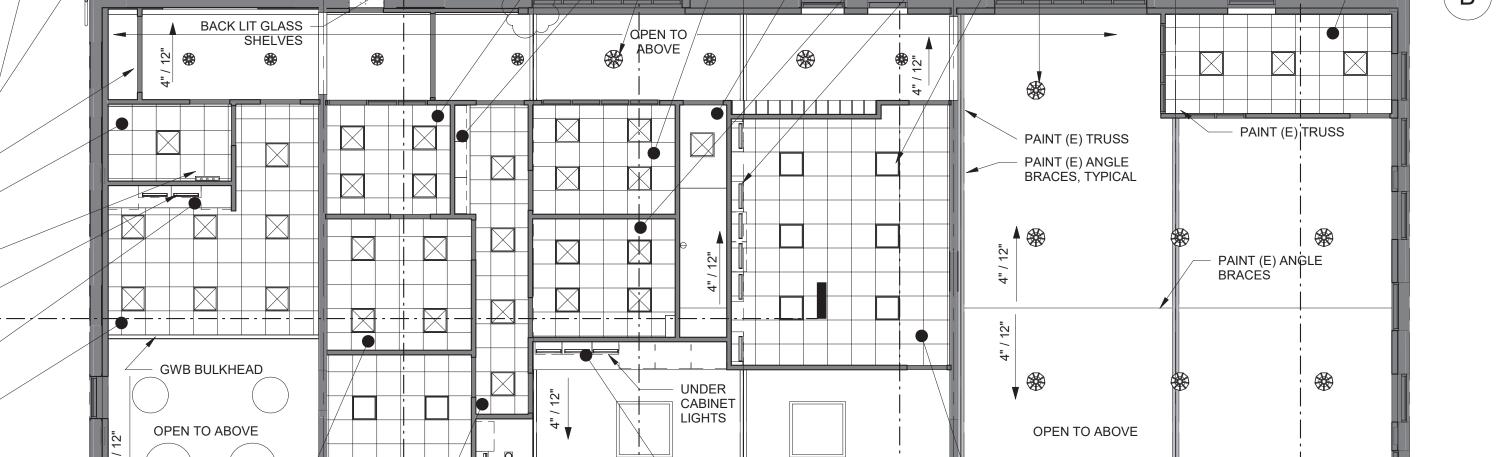

OPEN TO ABOVE

OPEN TO ABOVE

BULKHEAD

UNDER CABINET LIGHTS

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Floor 1 Reflected Ceiling Plan

A-104.0

3 Floor 1 1/8" = 1'-0"

1A <varies>

VANITY LIGHT FIXTURE -


(6) LUMENWERX RIM VERSO ACOUSTIC

UNDER CABINET LIGHTS

UTILITY SCONCE -

12

(2) CEILING MOUNTED BASKETBALL HOOP SYSTEM

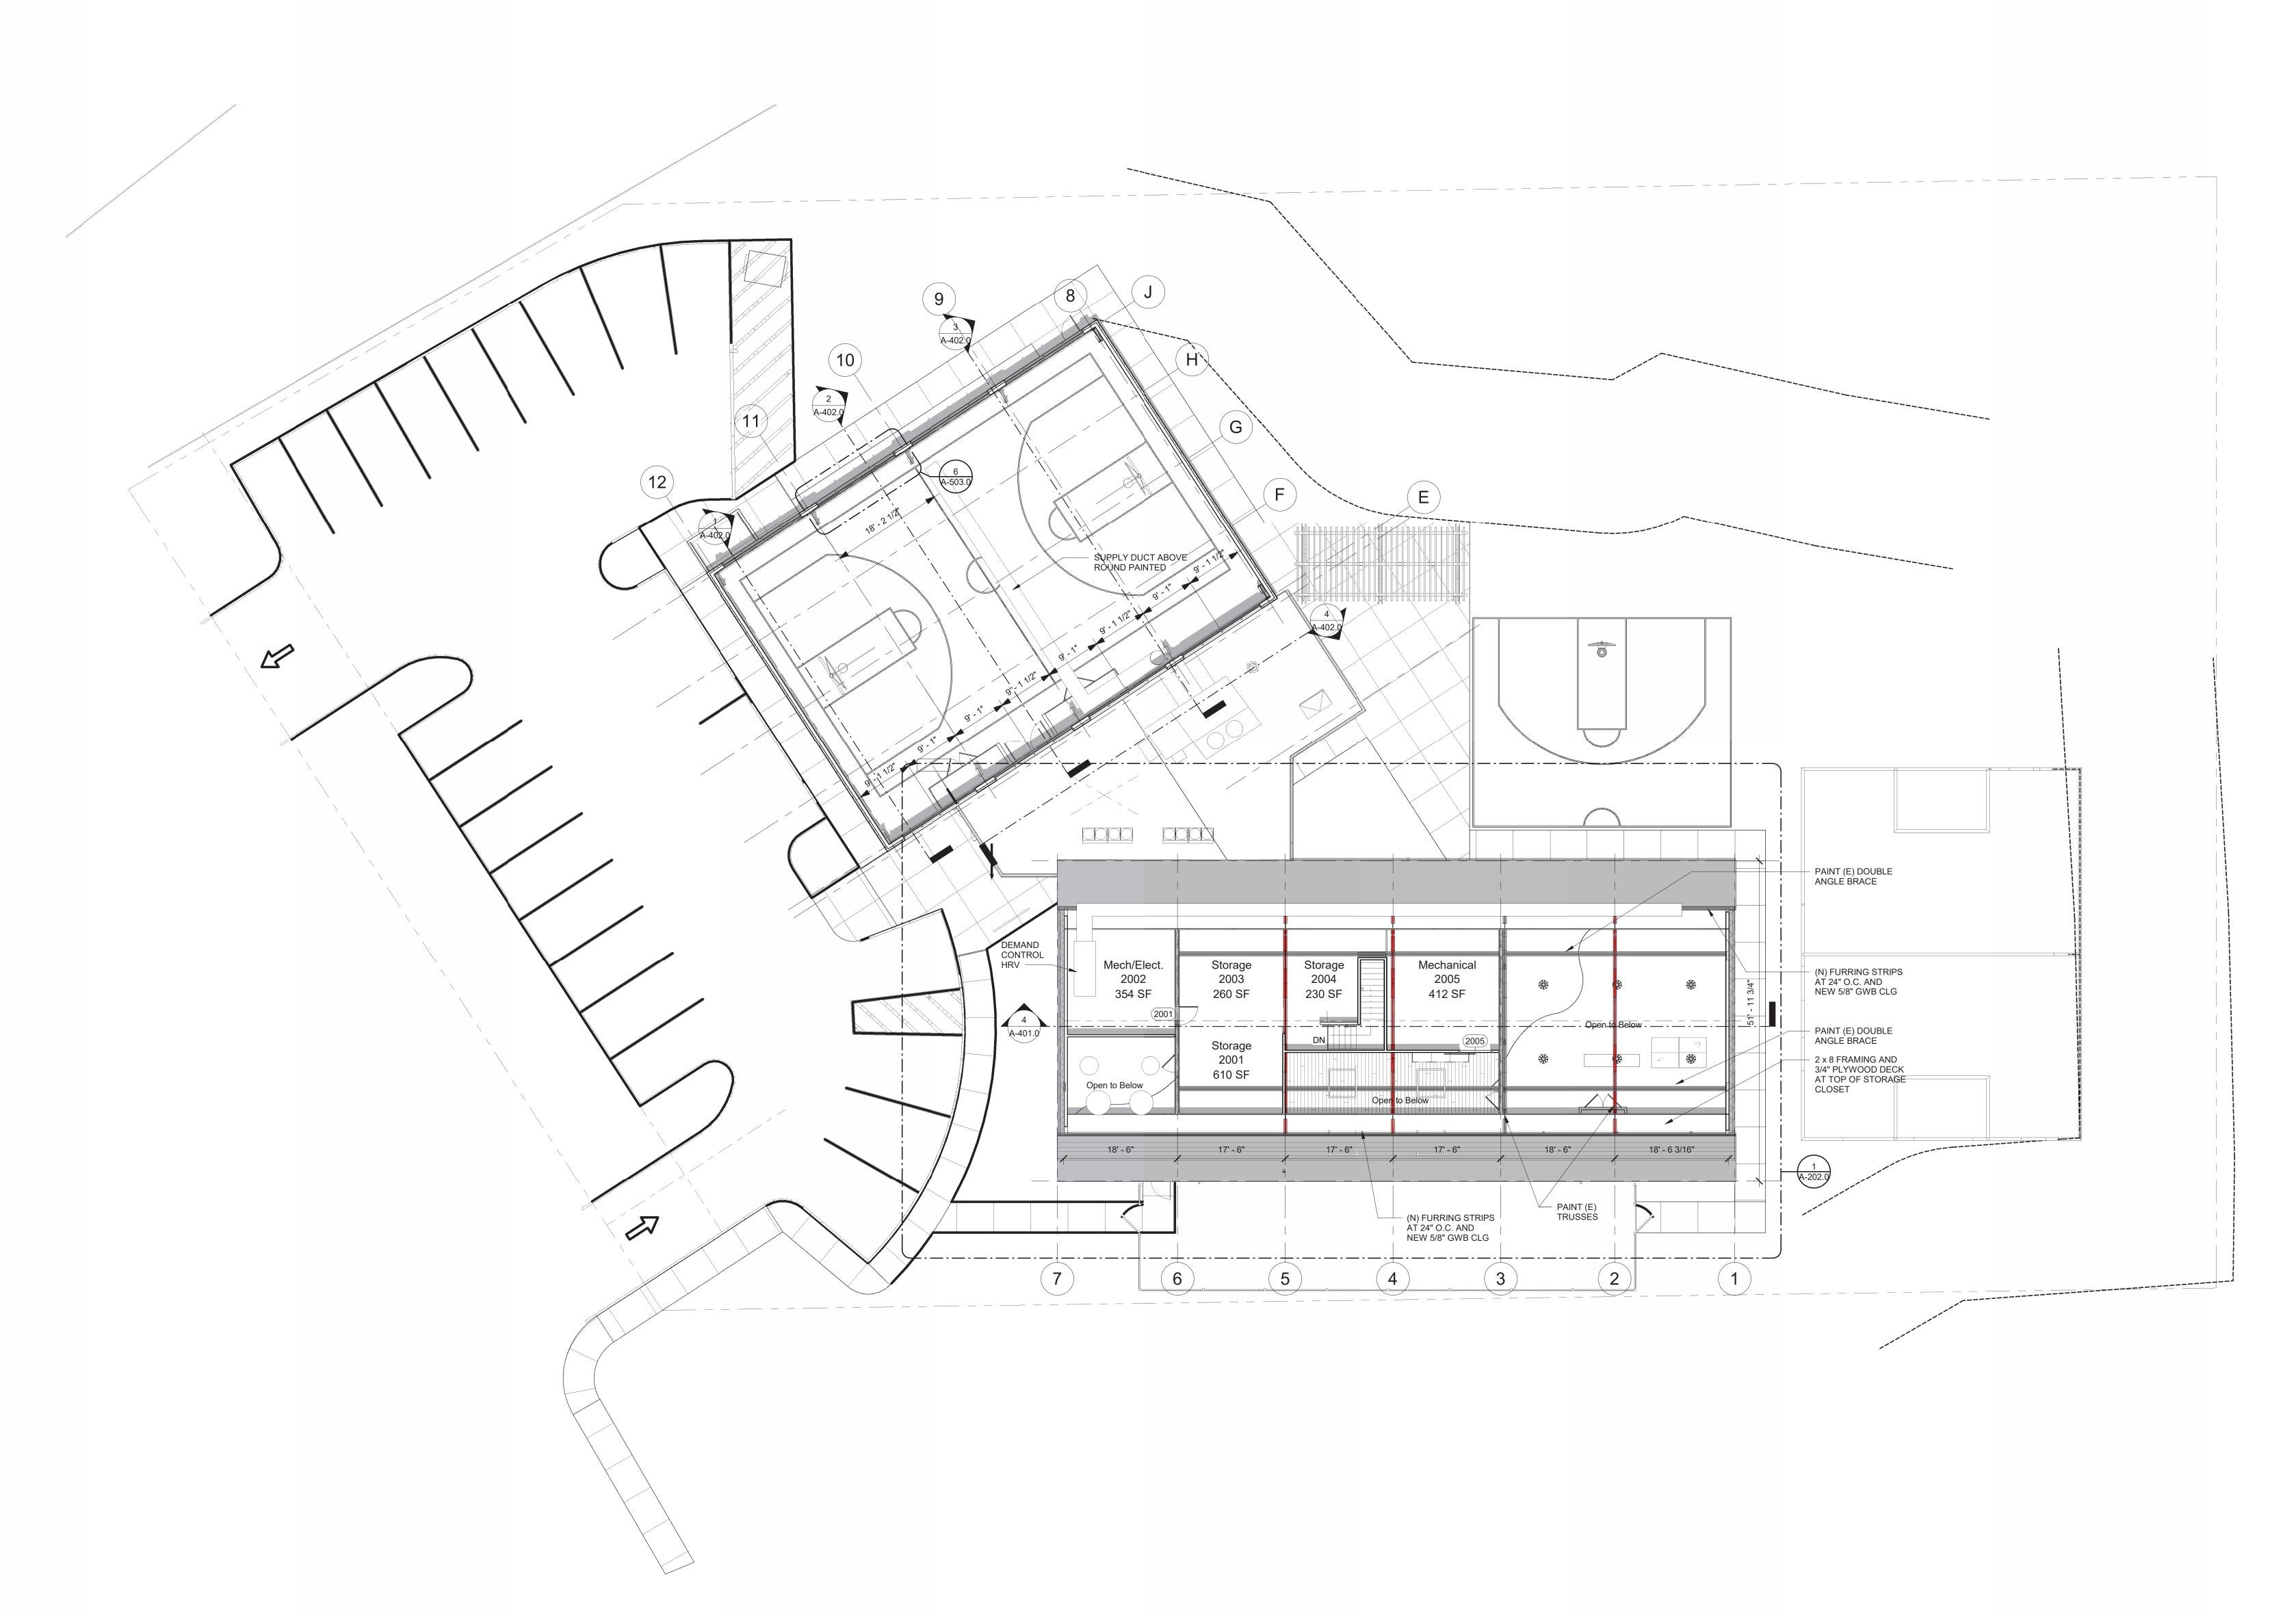



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Second Floor Overall Plan

Sheet Number: A-105.0


GENERAL ROOF PLAN NOTES:

1. R.D. REPRESENTS ROOF DRAIN. O.D. REPRESENTS OVERFLOW DRAIN. REFER TO PLUMBING DRAWINGS FOR SIZES AND COORDINATE LOCATIONS WITH TAPERED INSULATION. REFER TO DETAILS ON A-5.XX.


2. COORDINATE LOCATIONS OF ROOF TOP UNITS, DUCTS, PENETRATIONS, AND PIPING WITH MEP DRAWINGS.

3. ICE AND WATER SHIELD TO BE CONTINUOUS UNDER ALL ASPHALT ROOF SHINGLE ROOF EDGES.

4. DS = GUTTER SYSTEM DOWNSPOUT

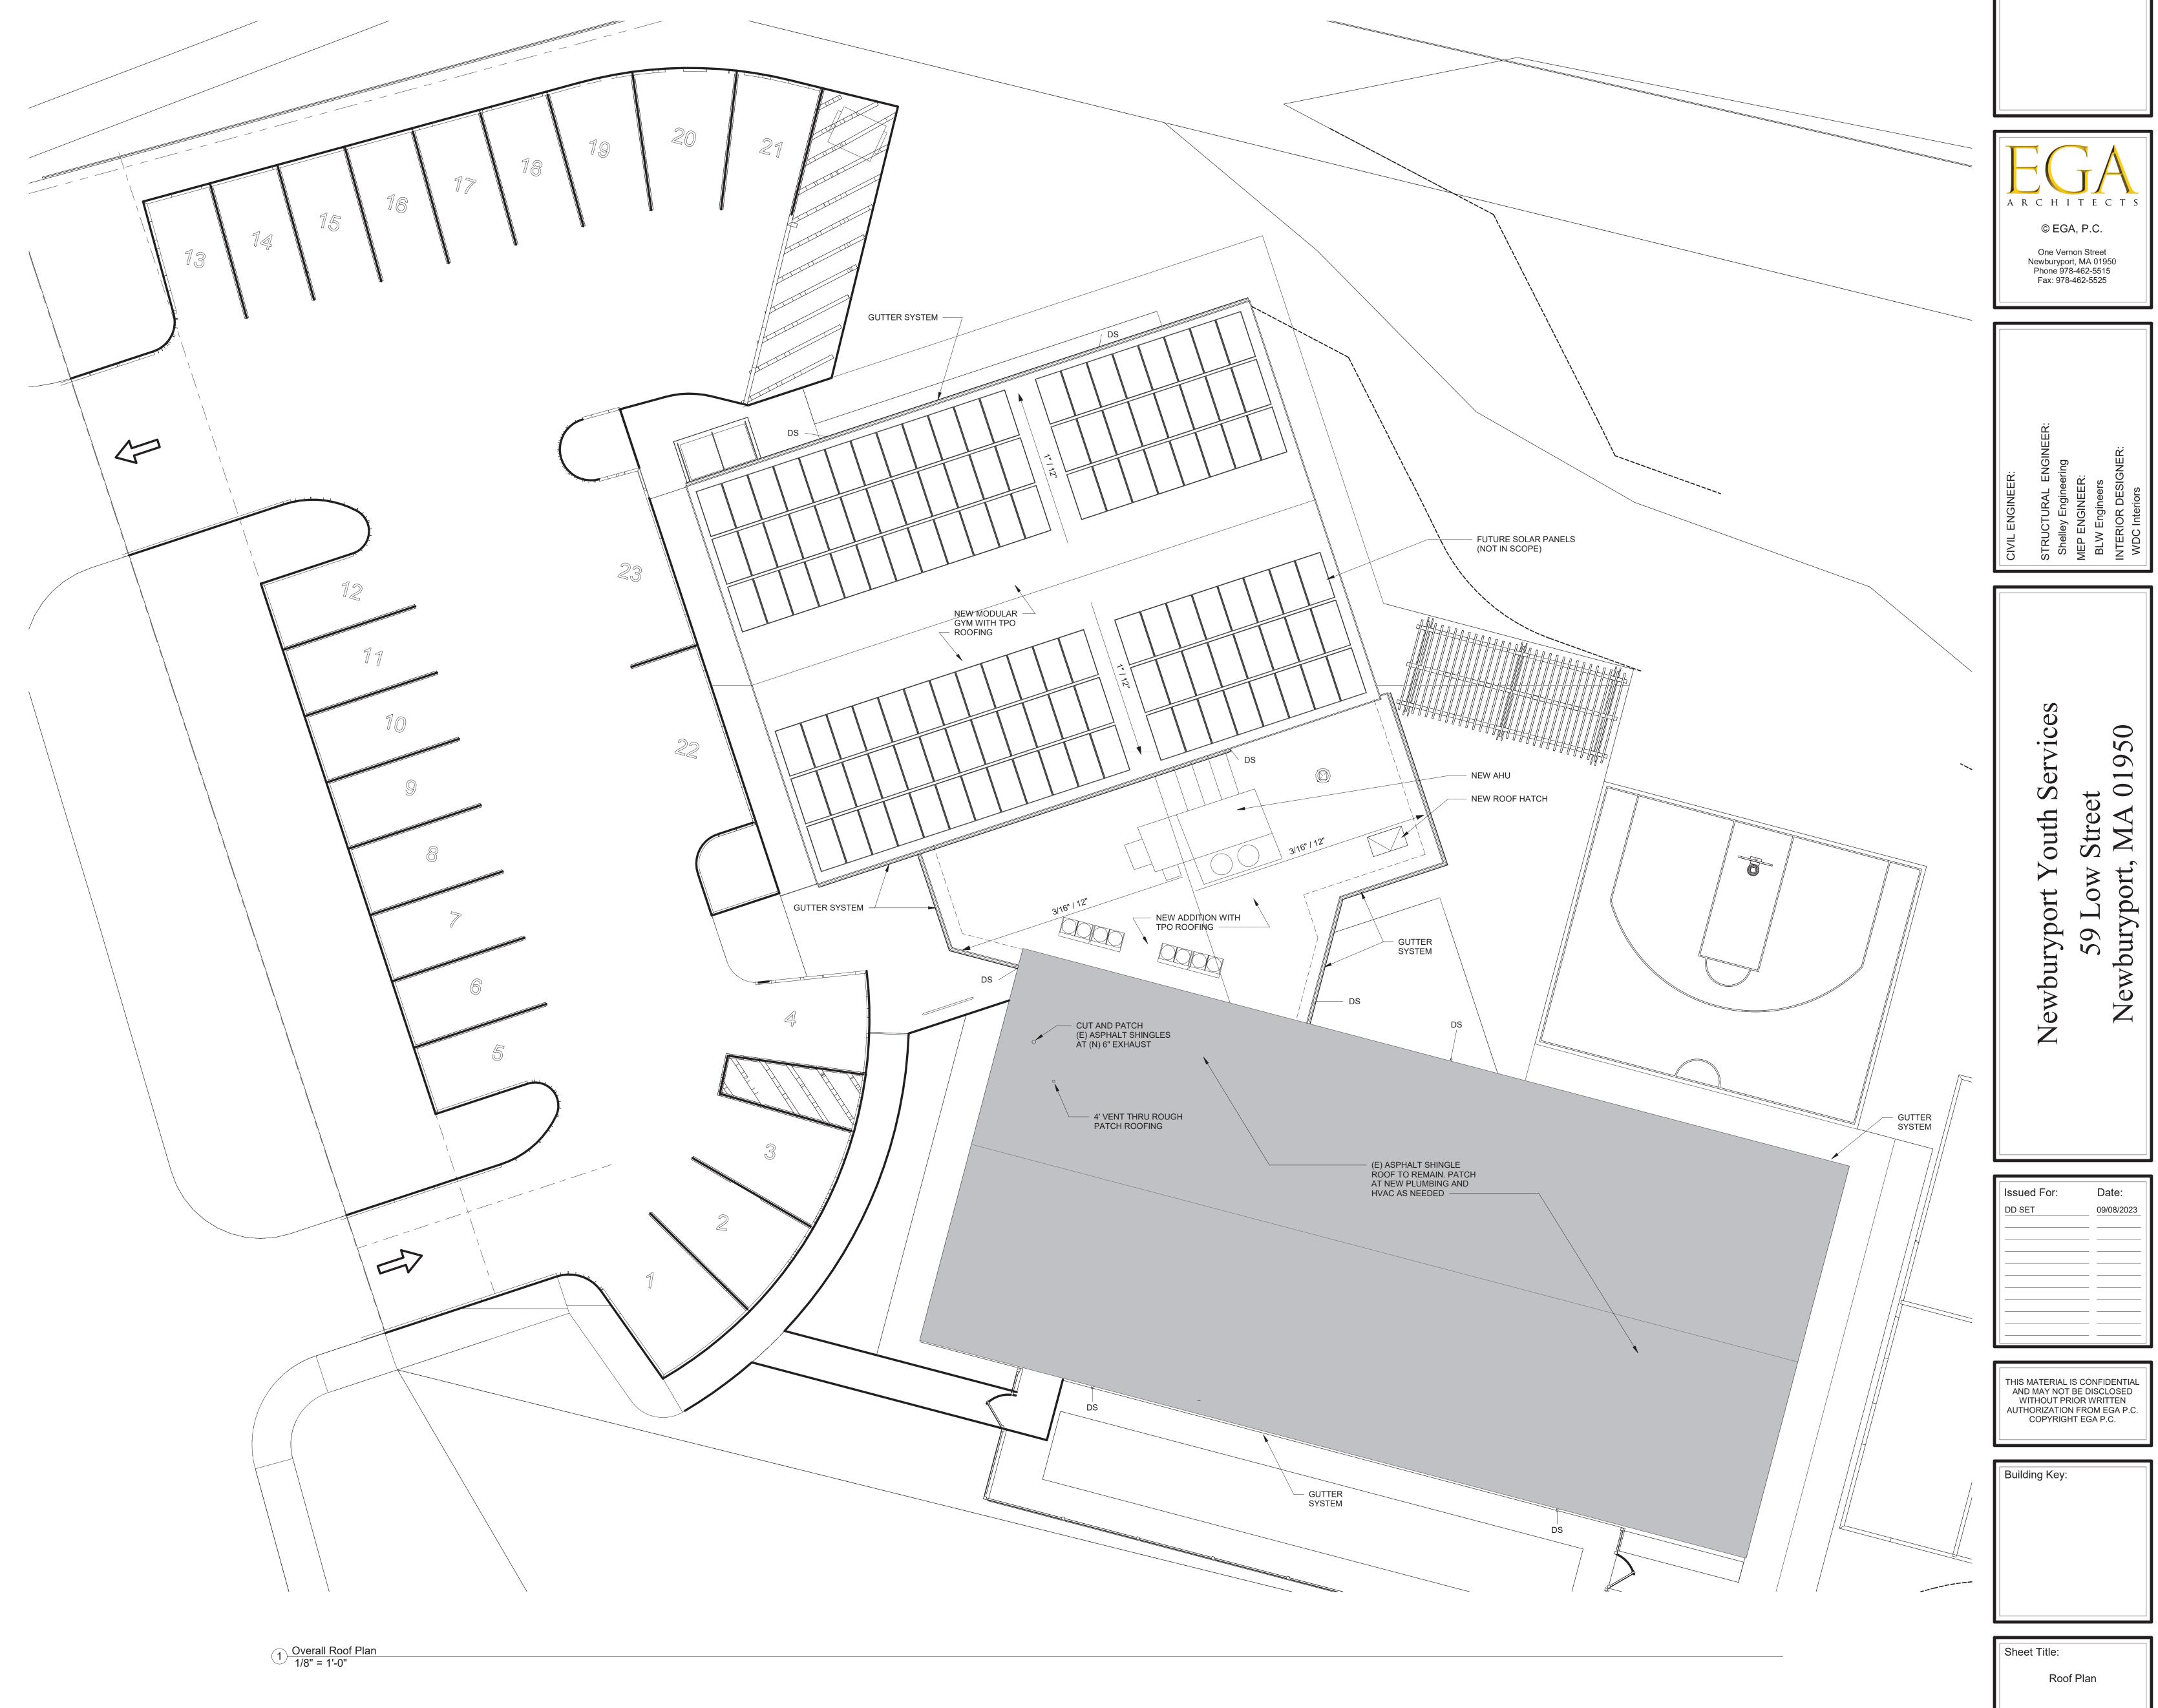

Sheet Number:

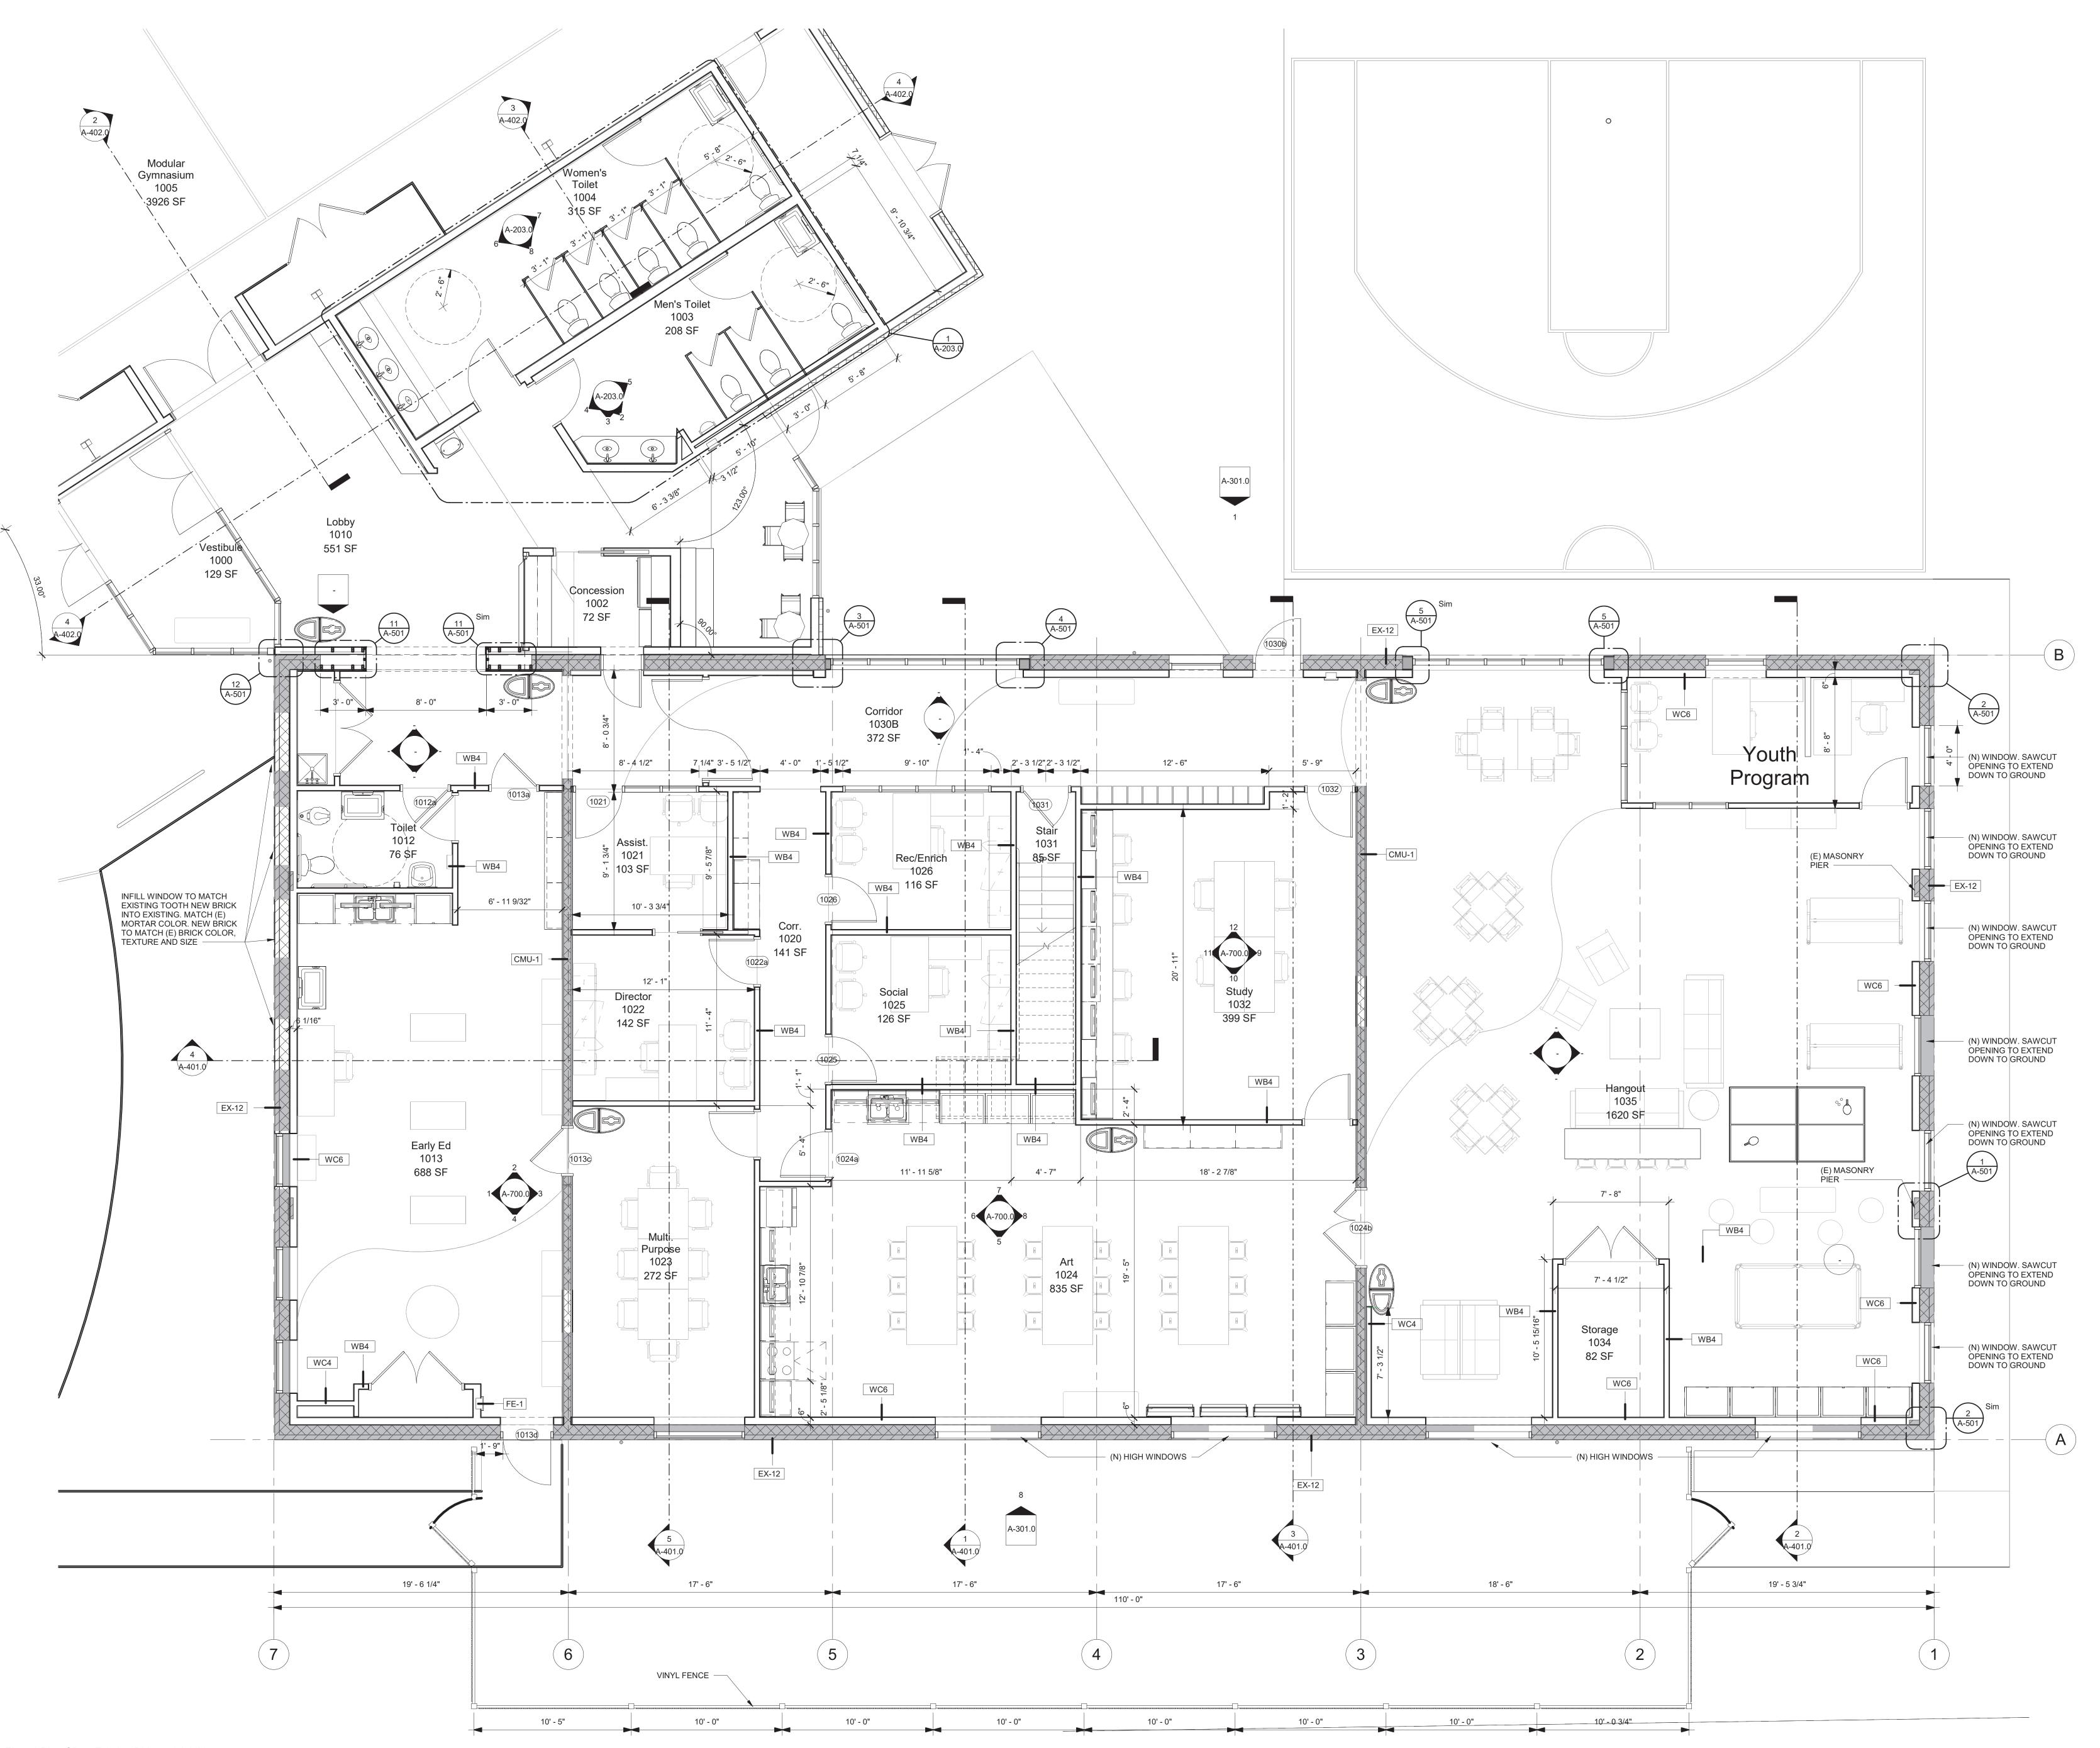




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First Floor Existing Building
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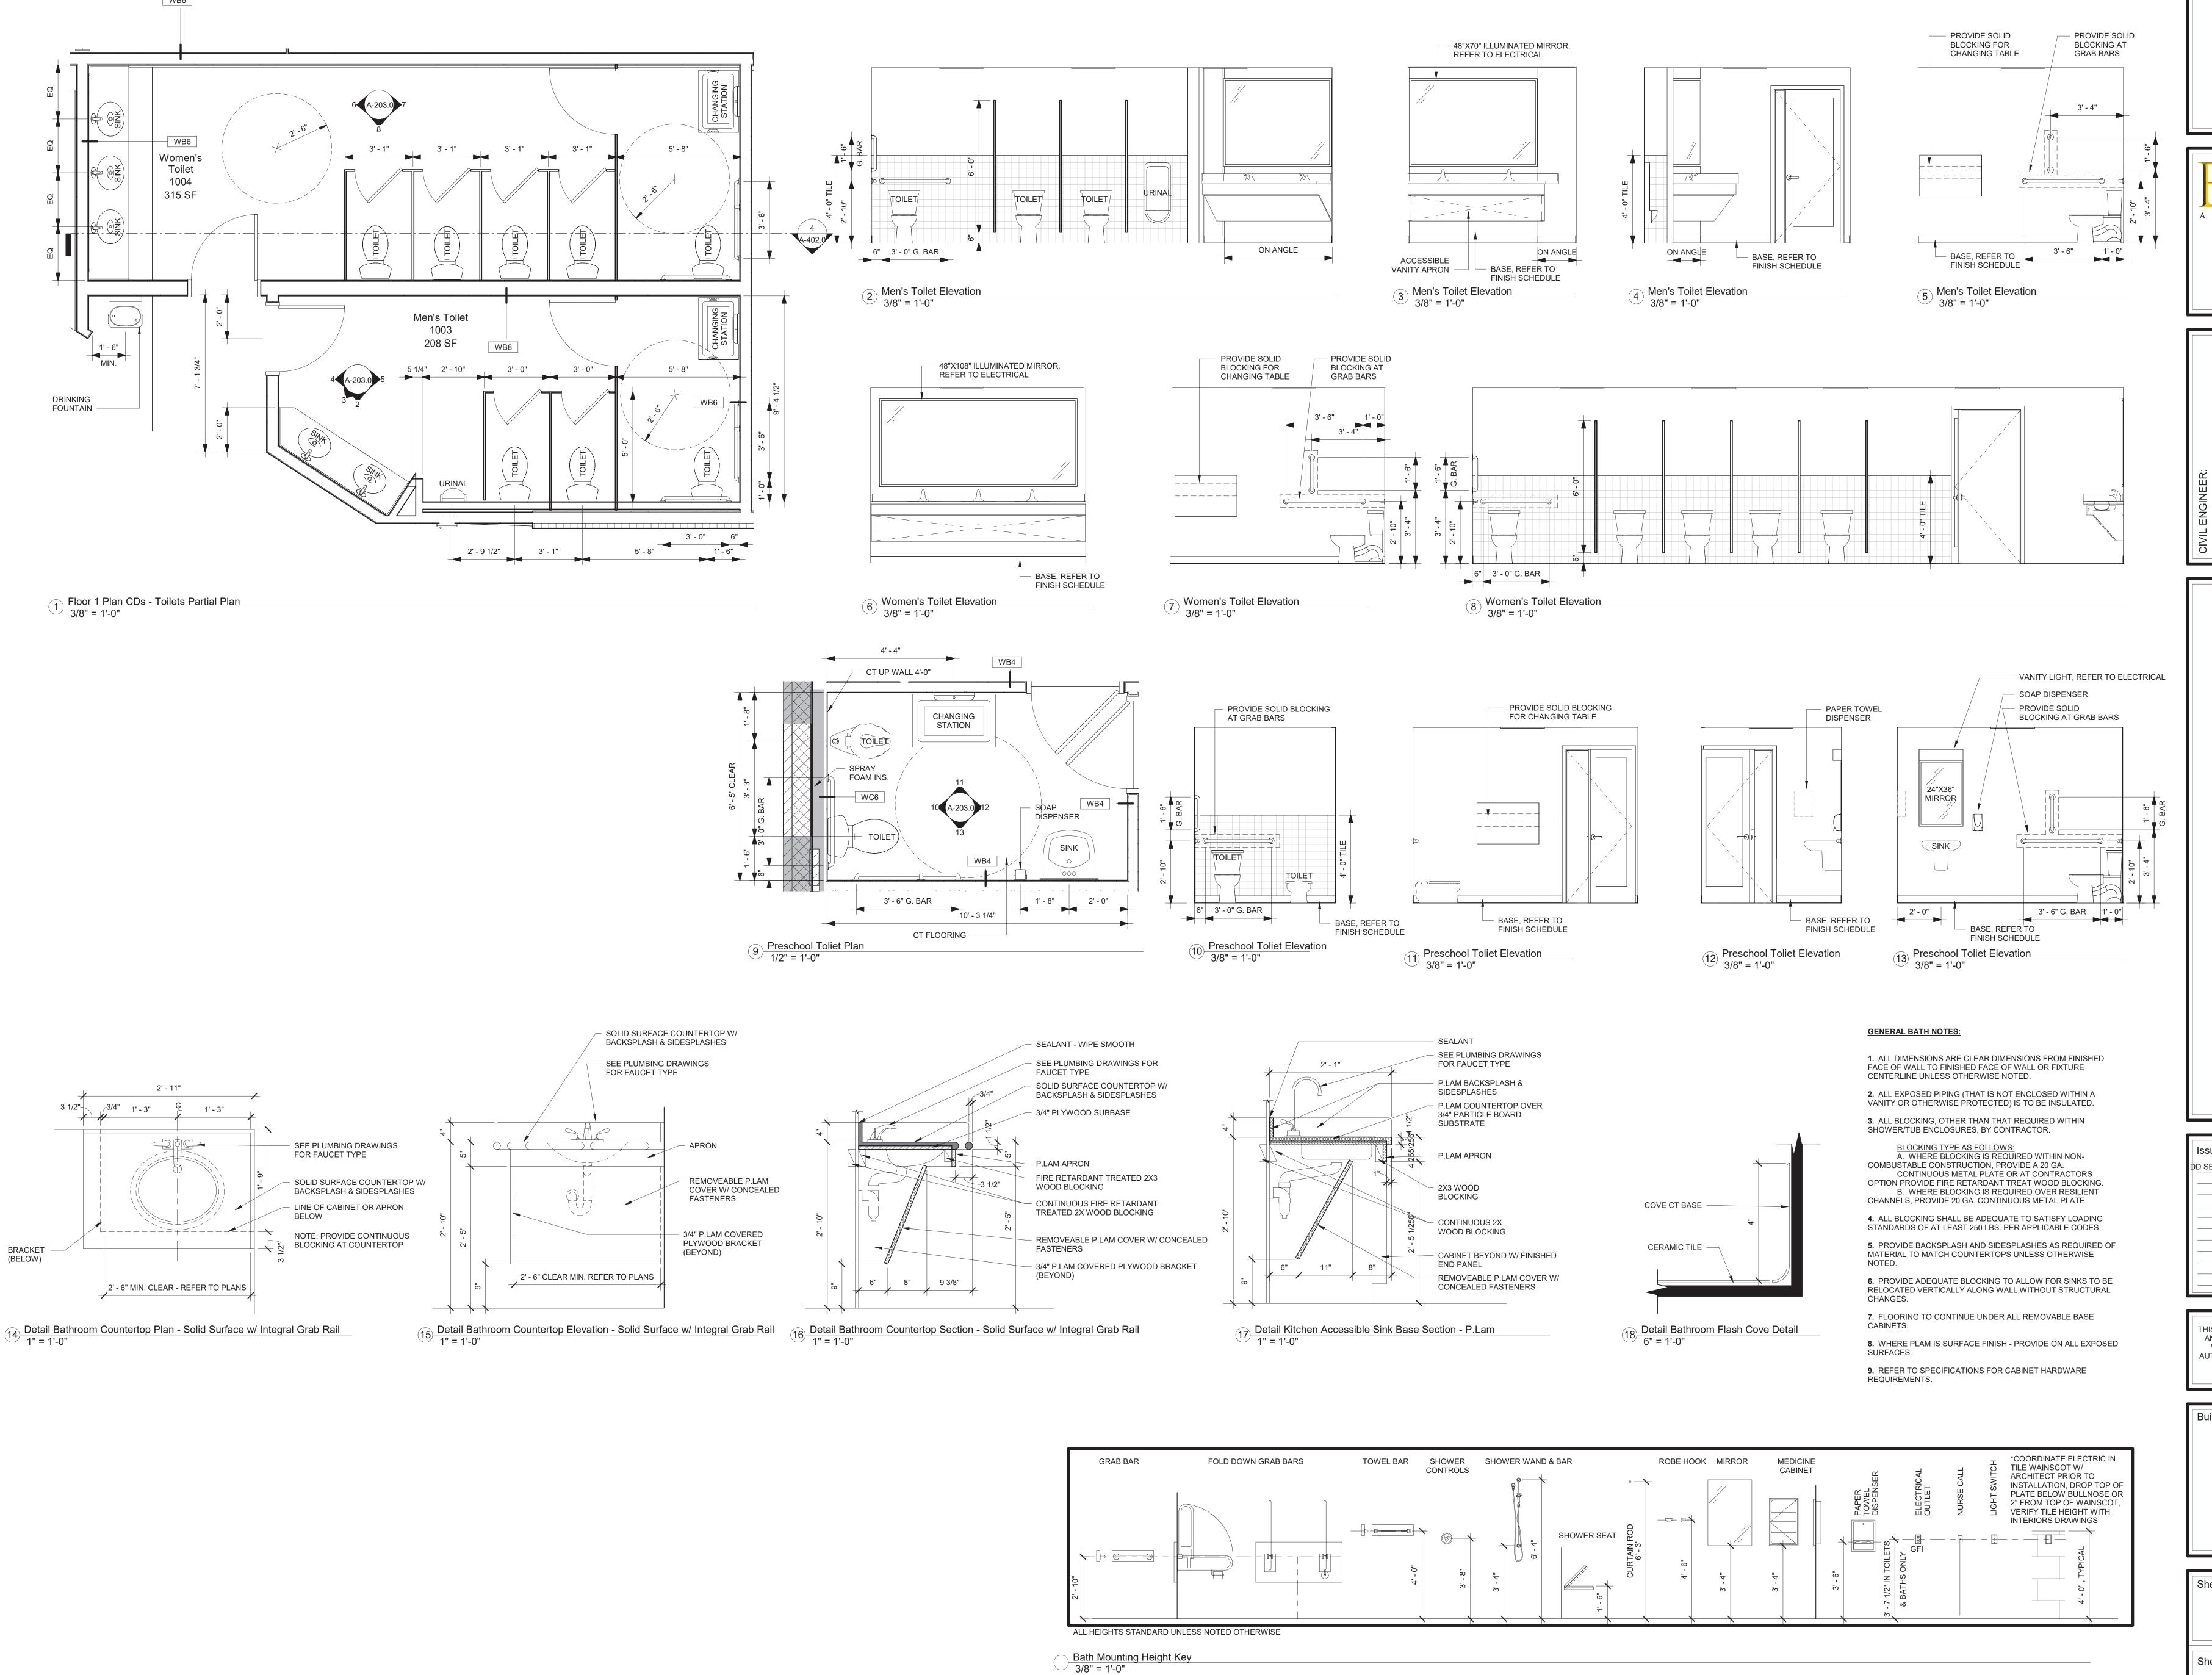
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Second Floor Existing
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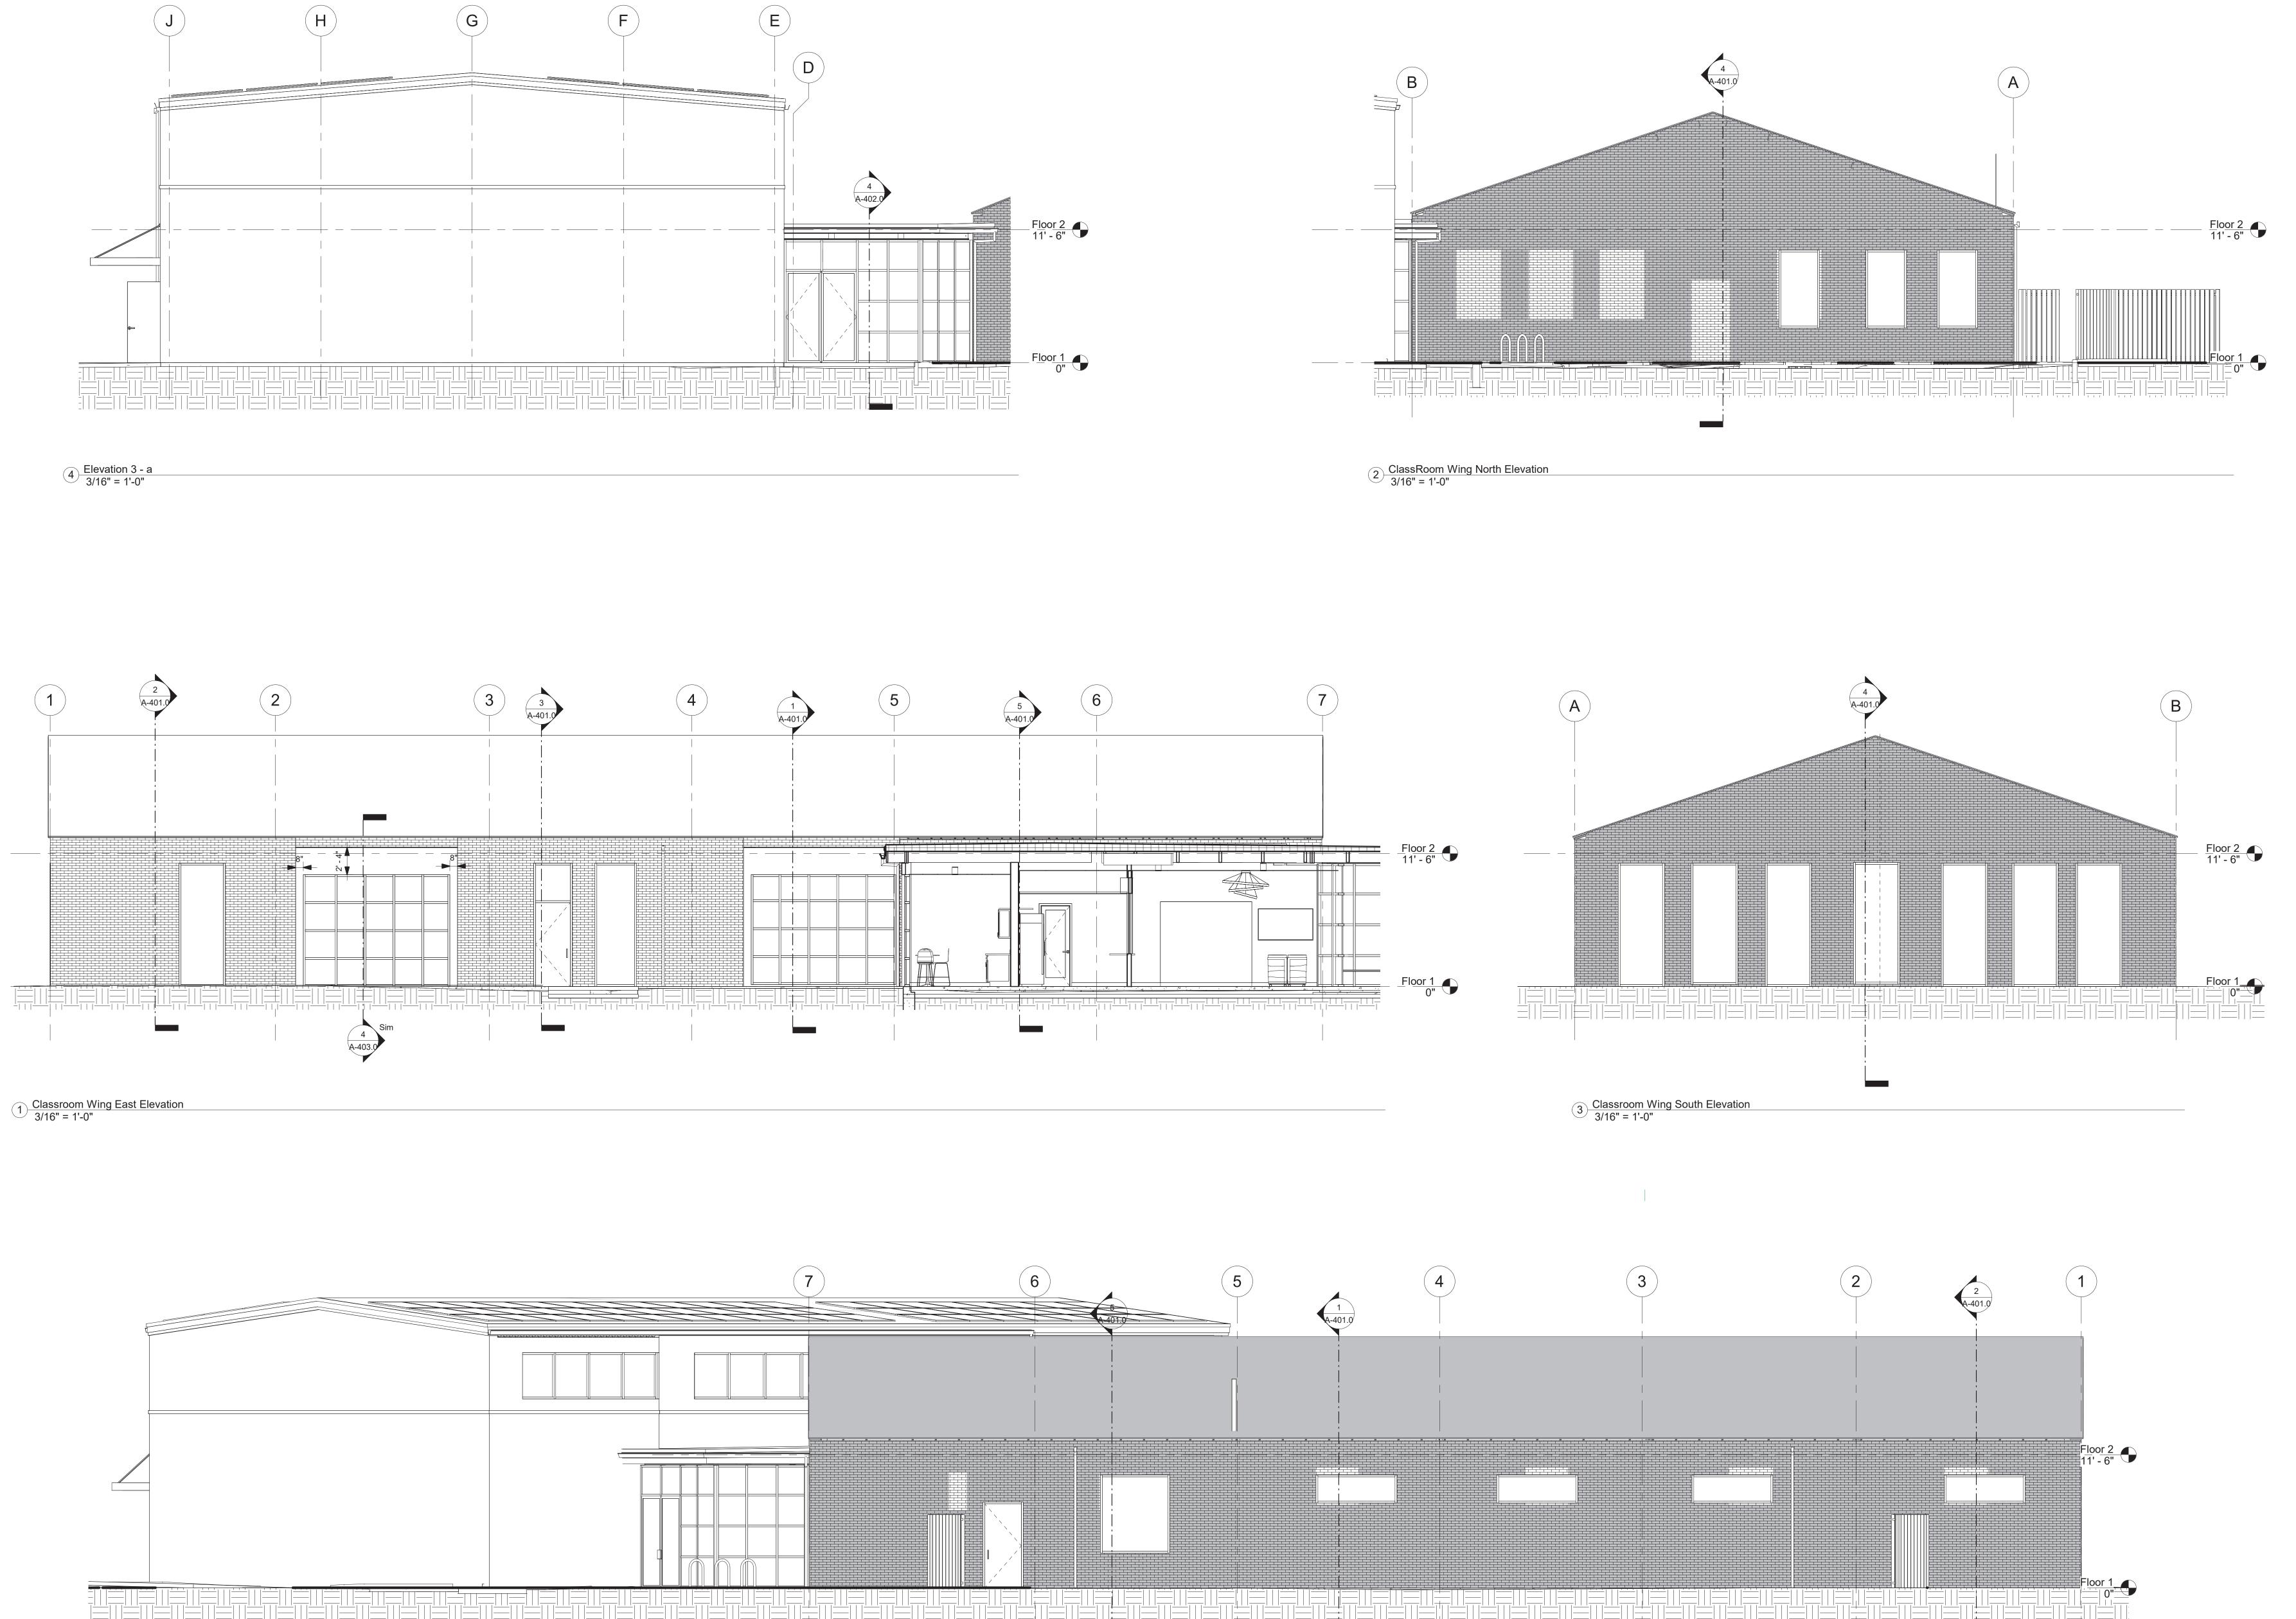
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Bath Elevations

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8 Classroom Wing West Elevation 3/16" = 1'-0"

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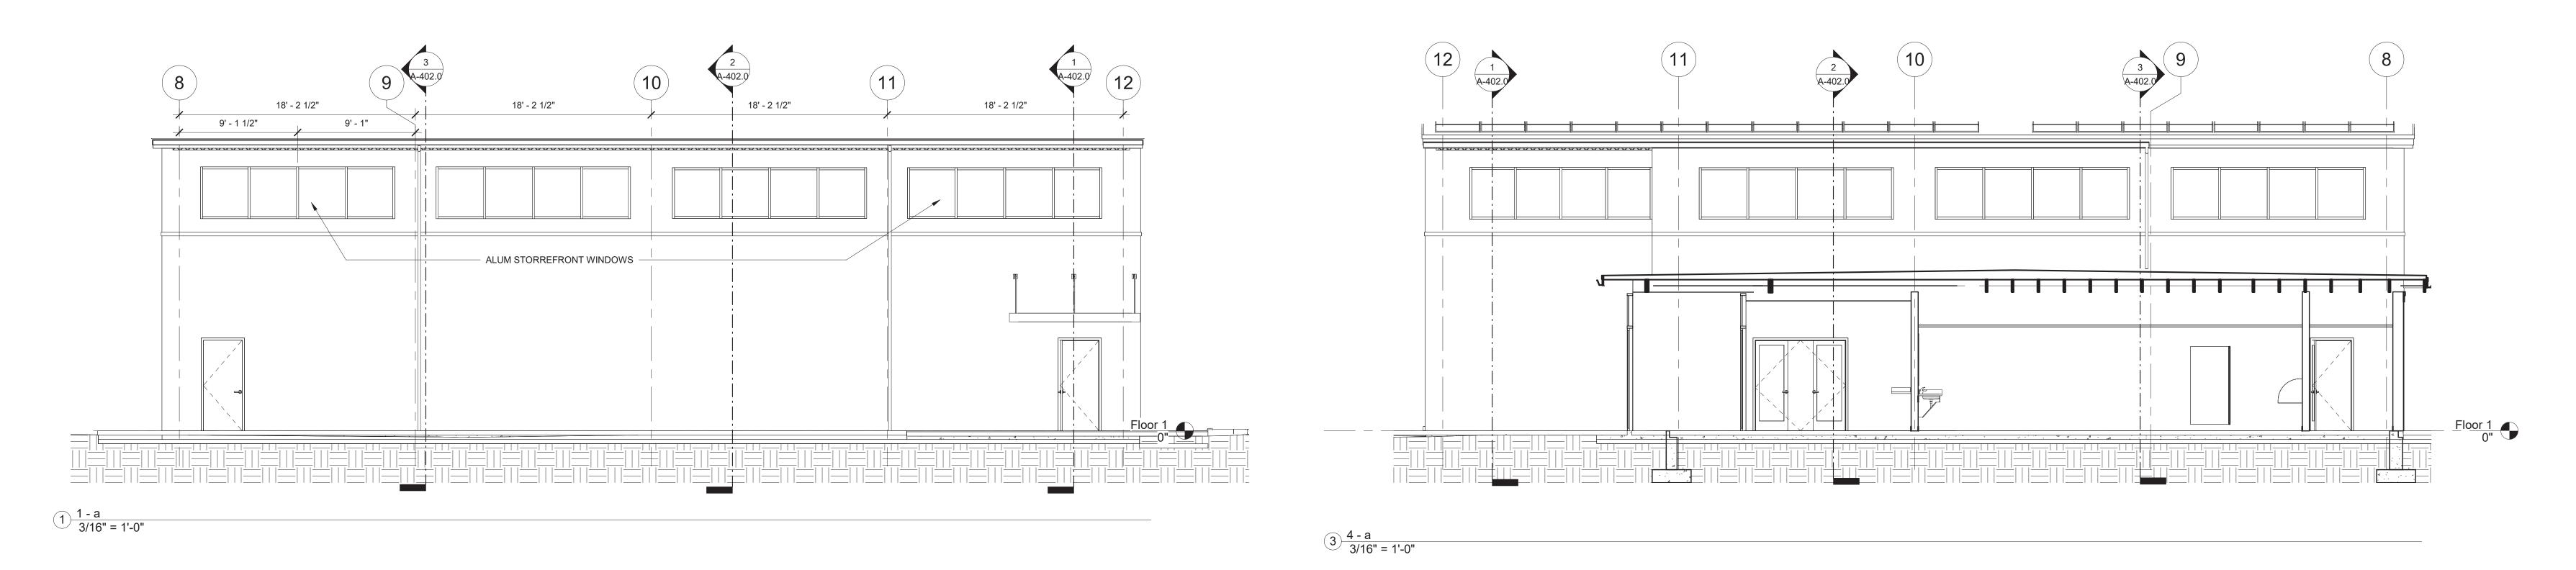
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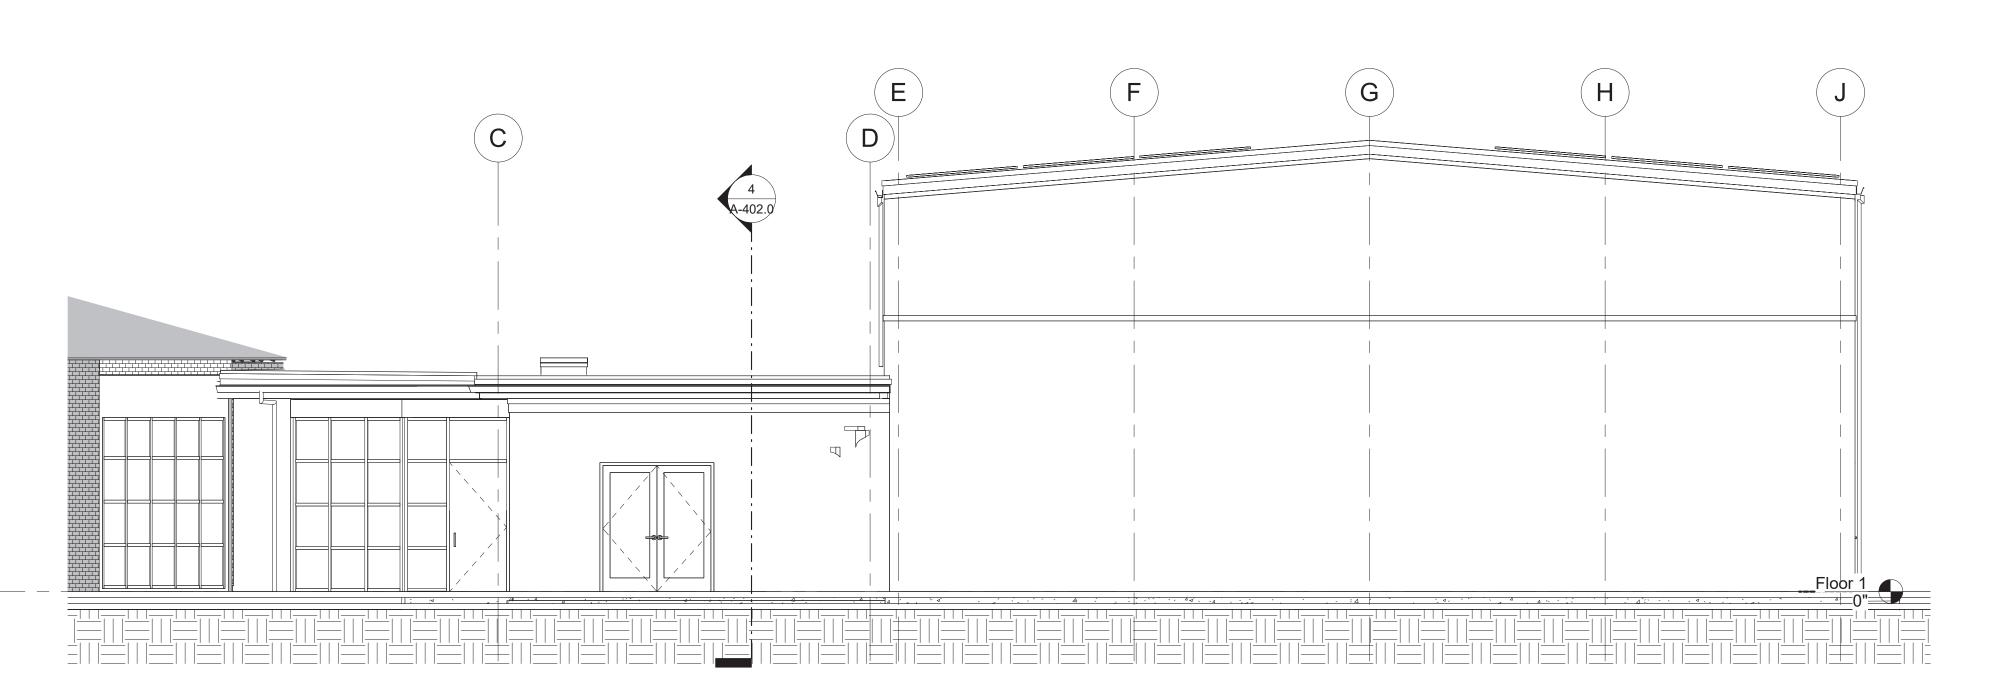
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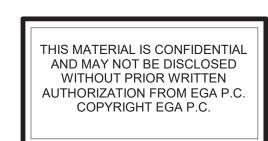
2 3 - a 3/16" = 1'-0"




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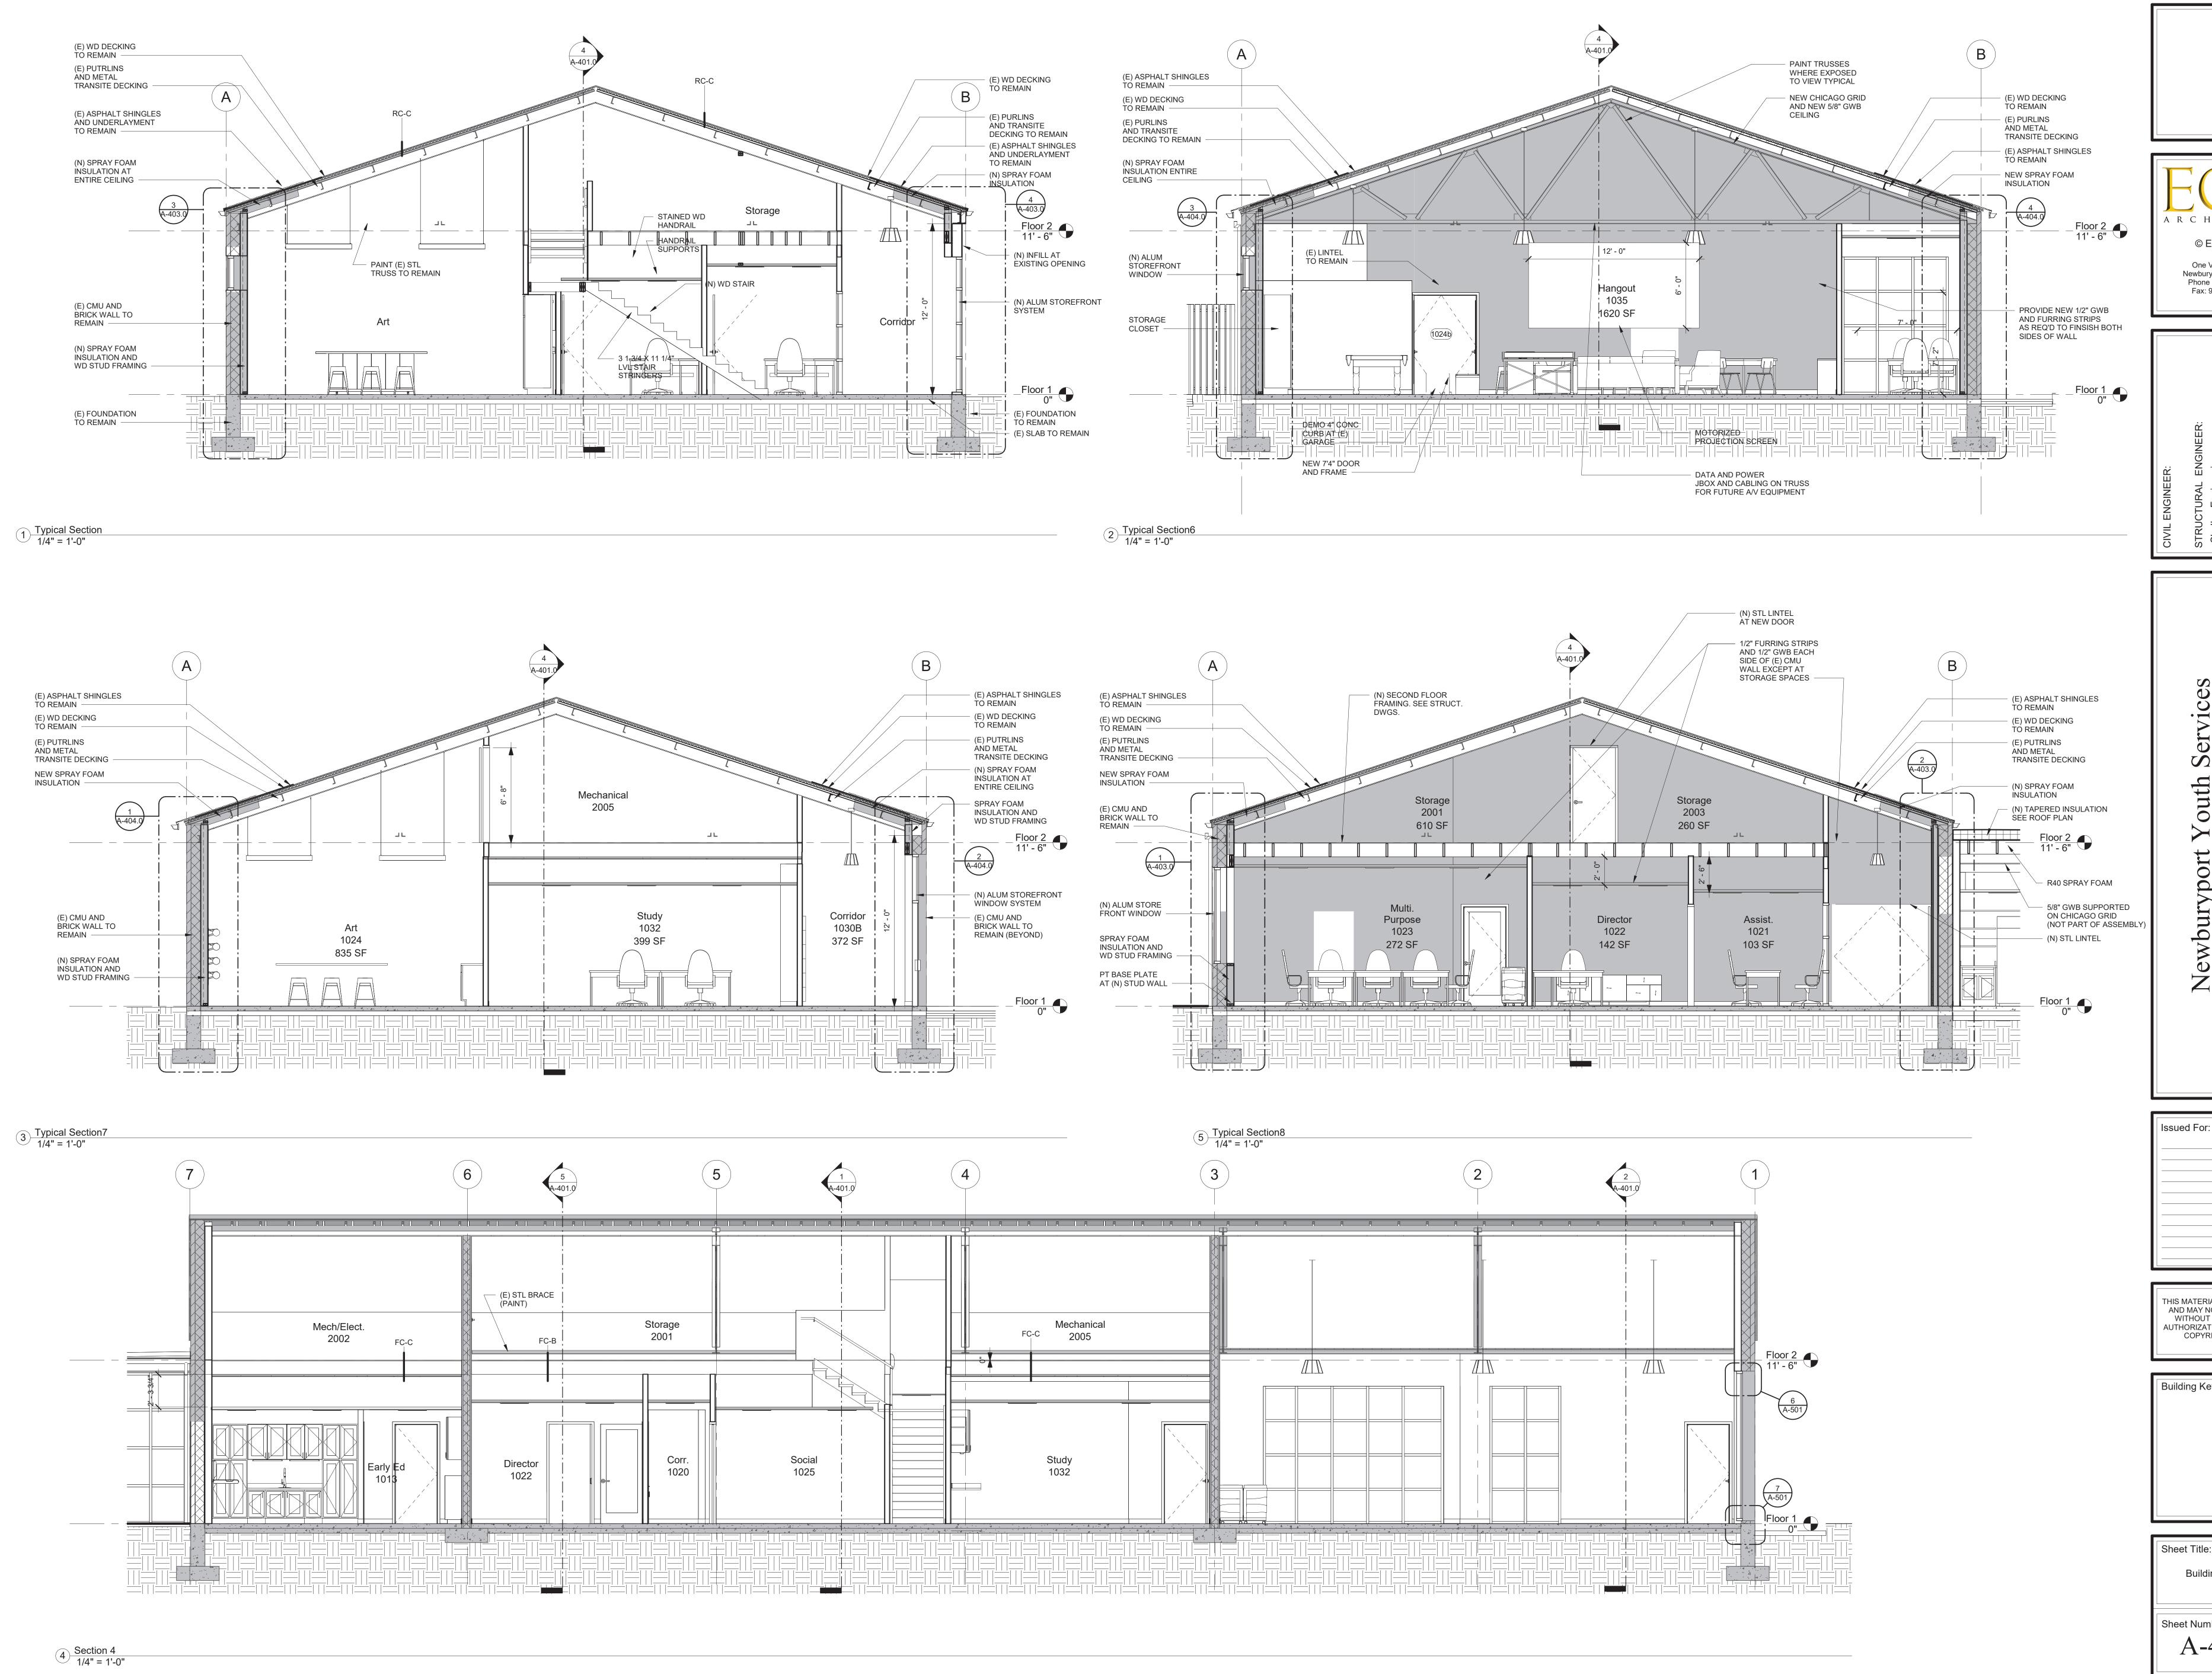
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Elevations	
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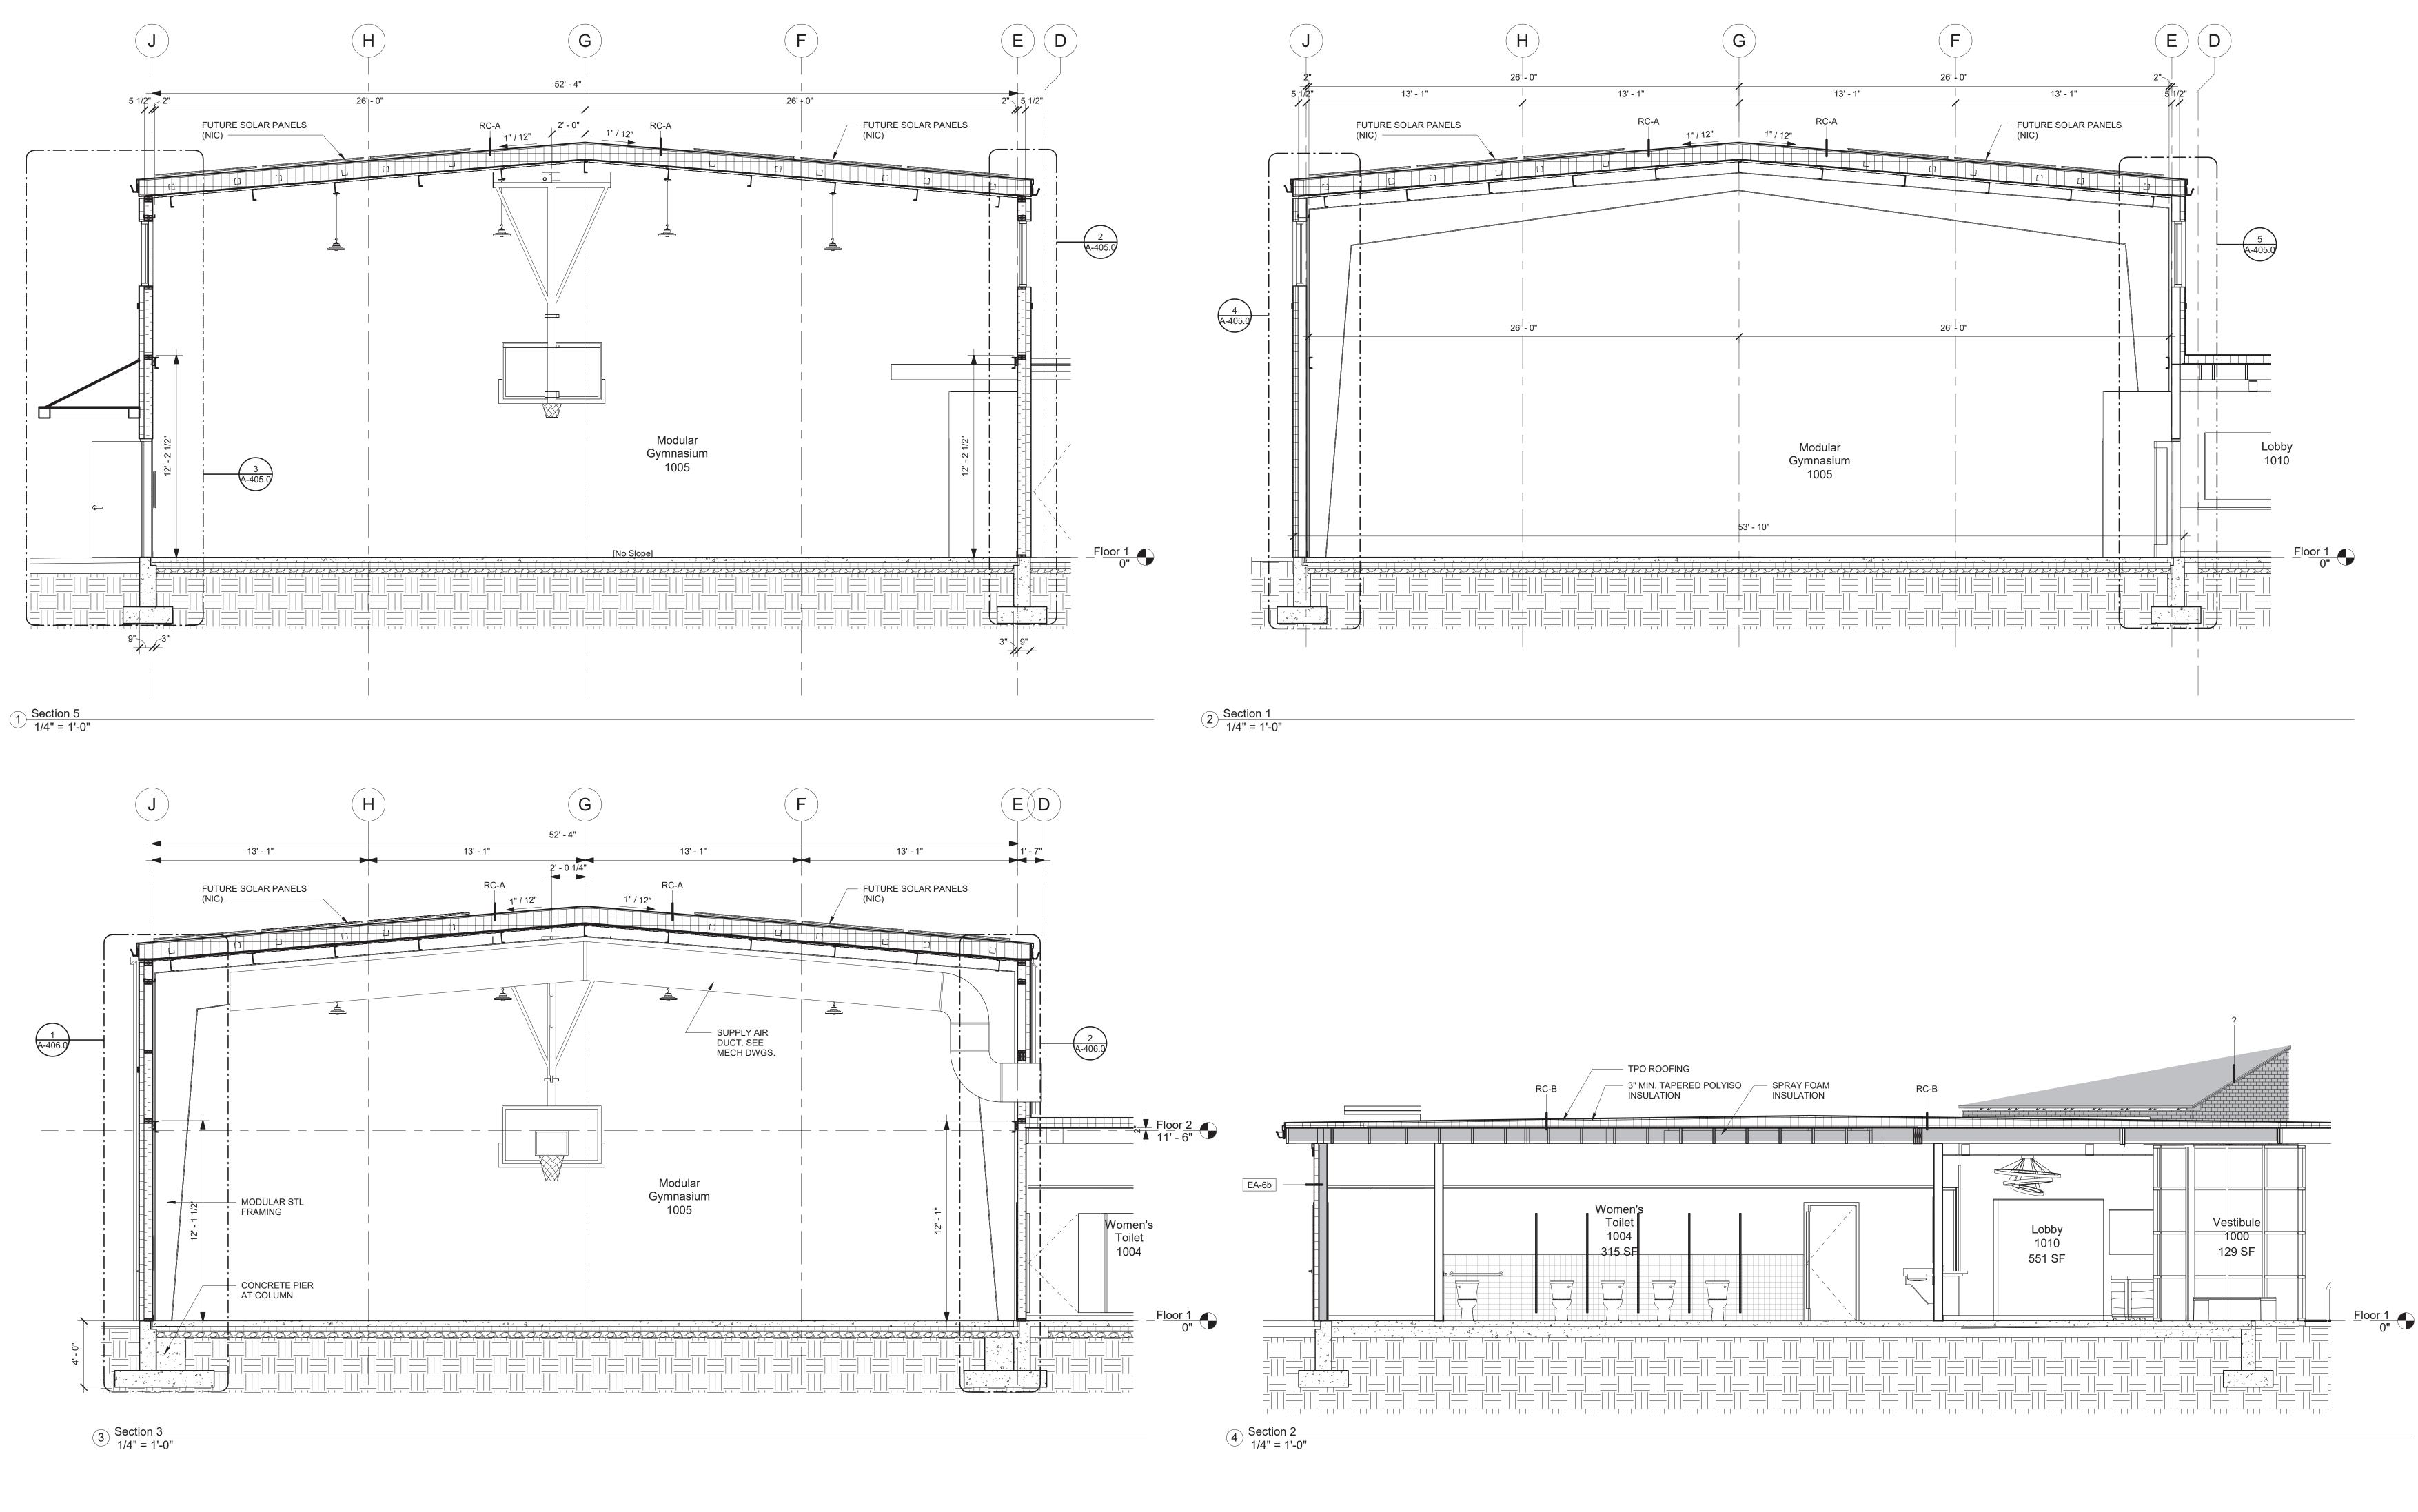
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Building Sections
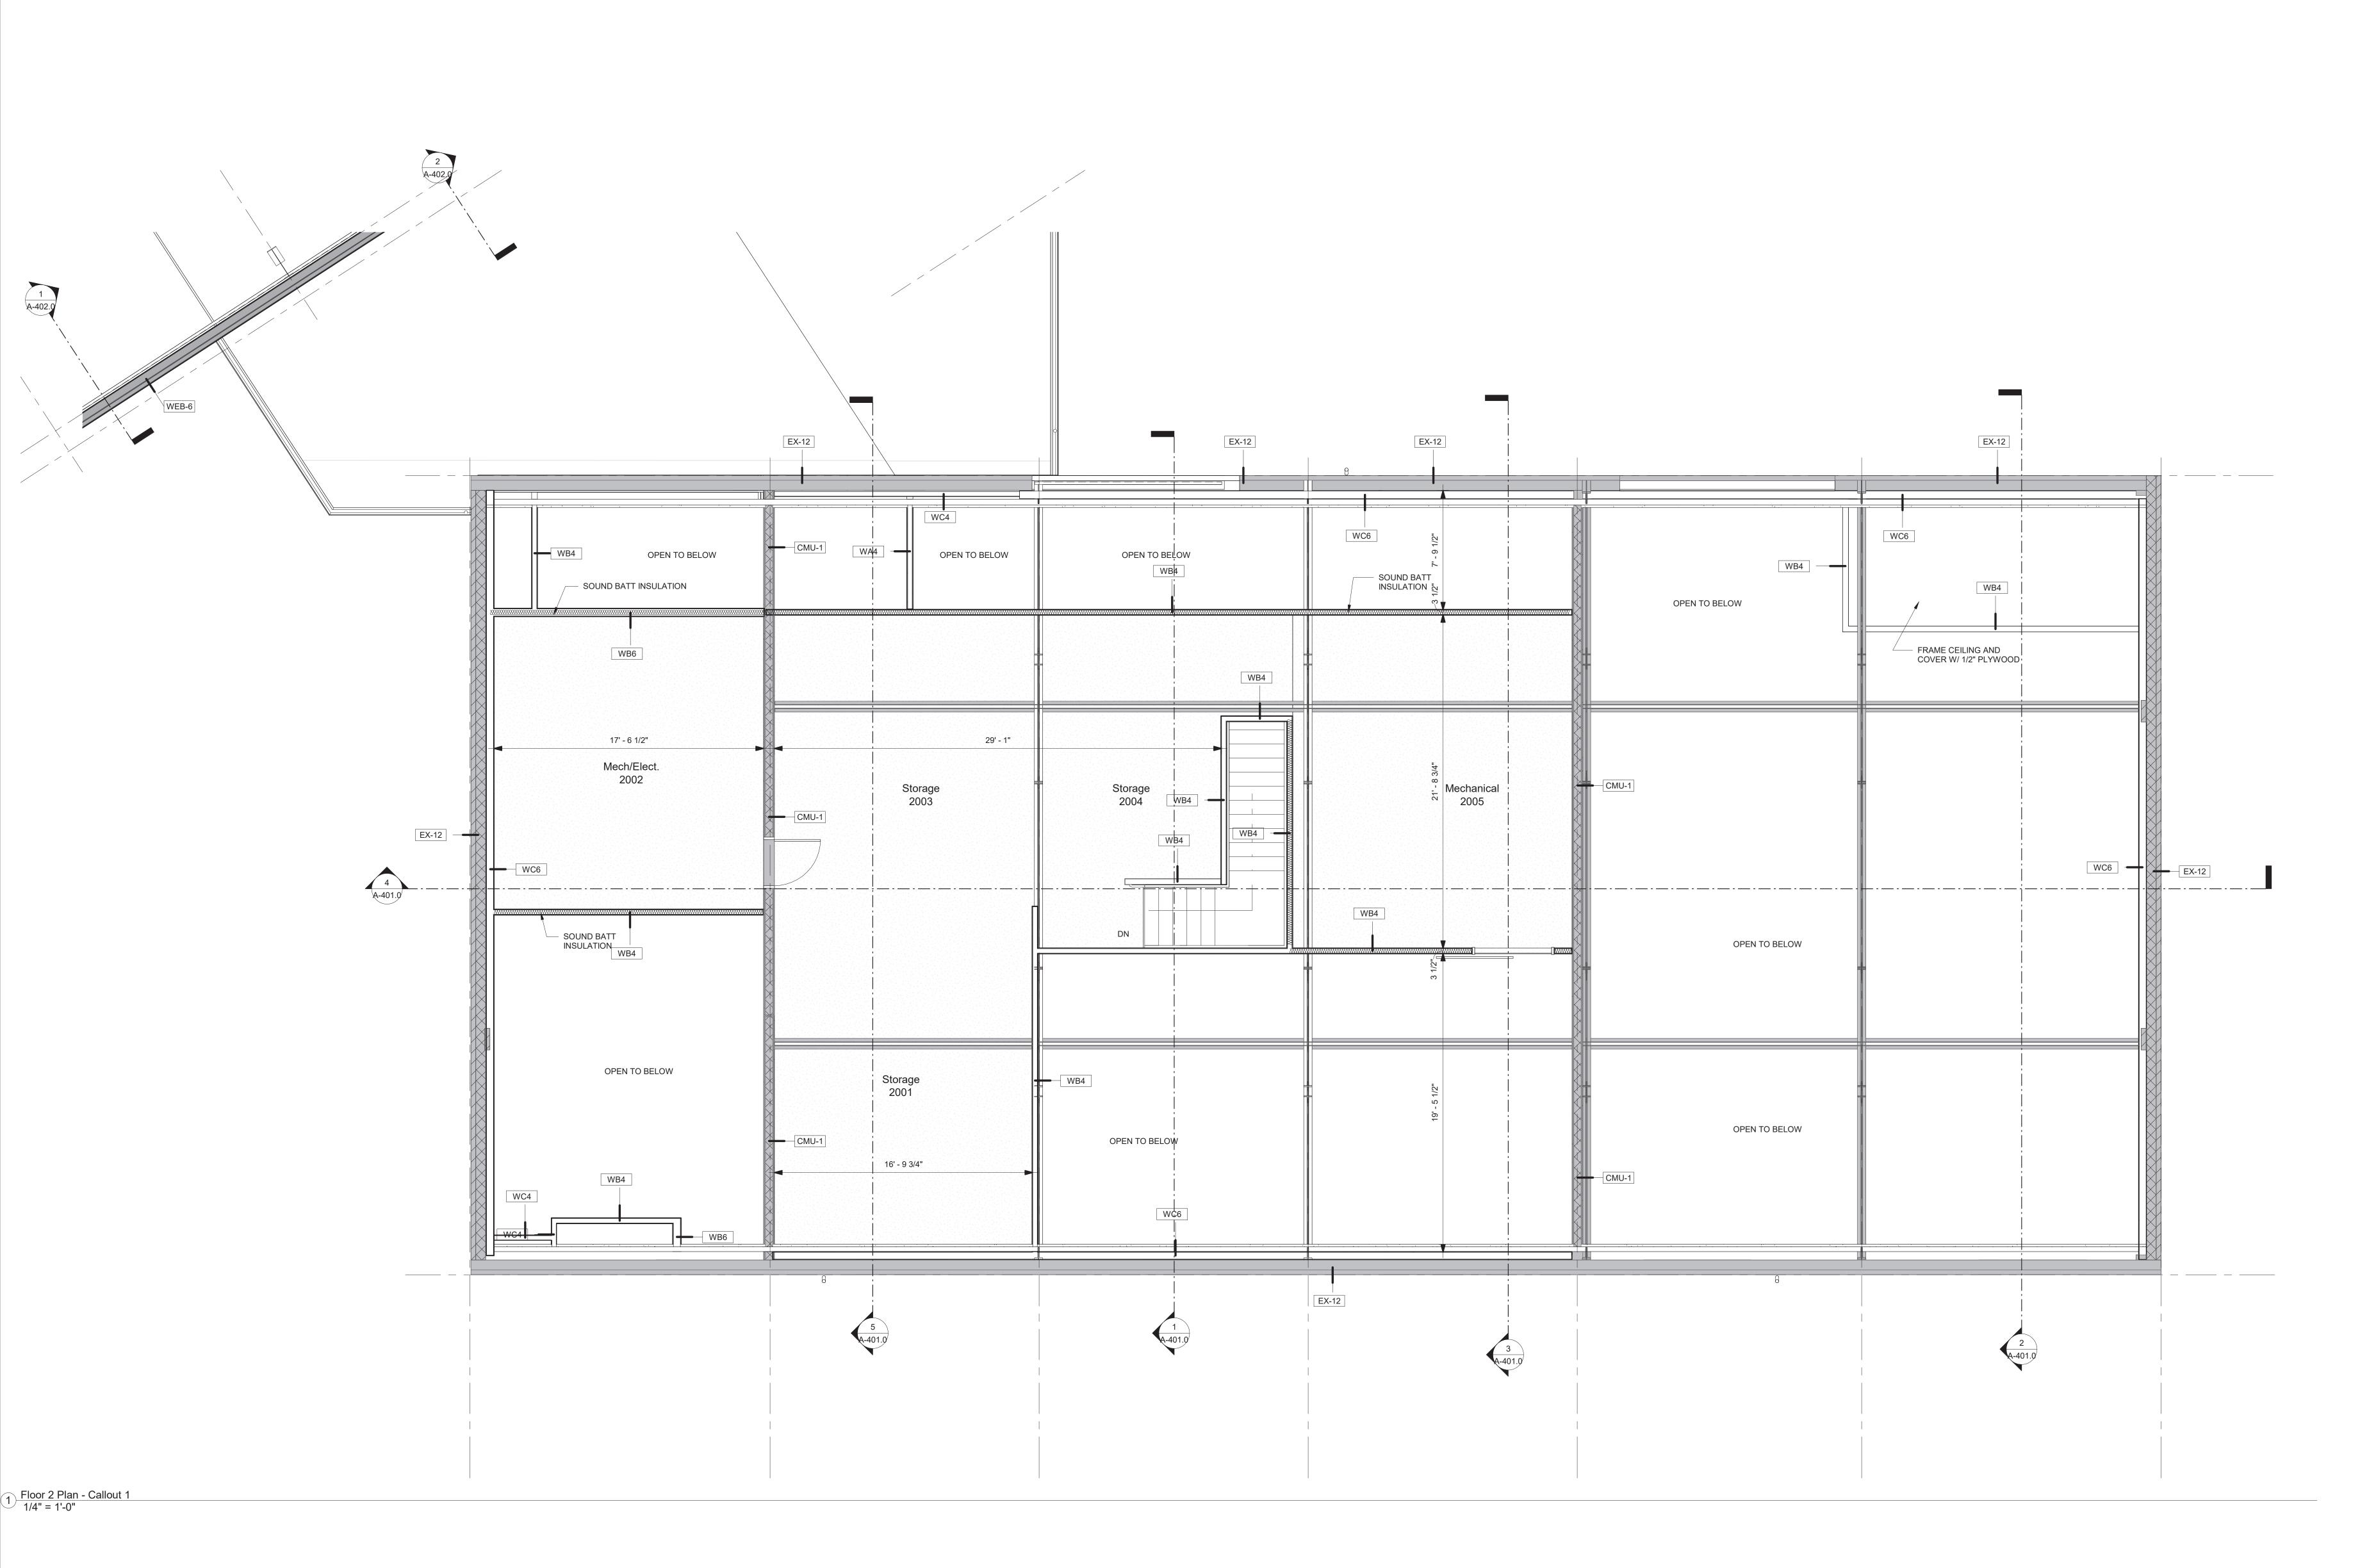
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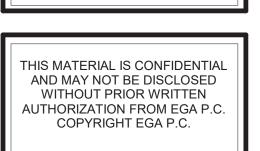





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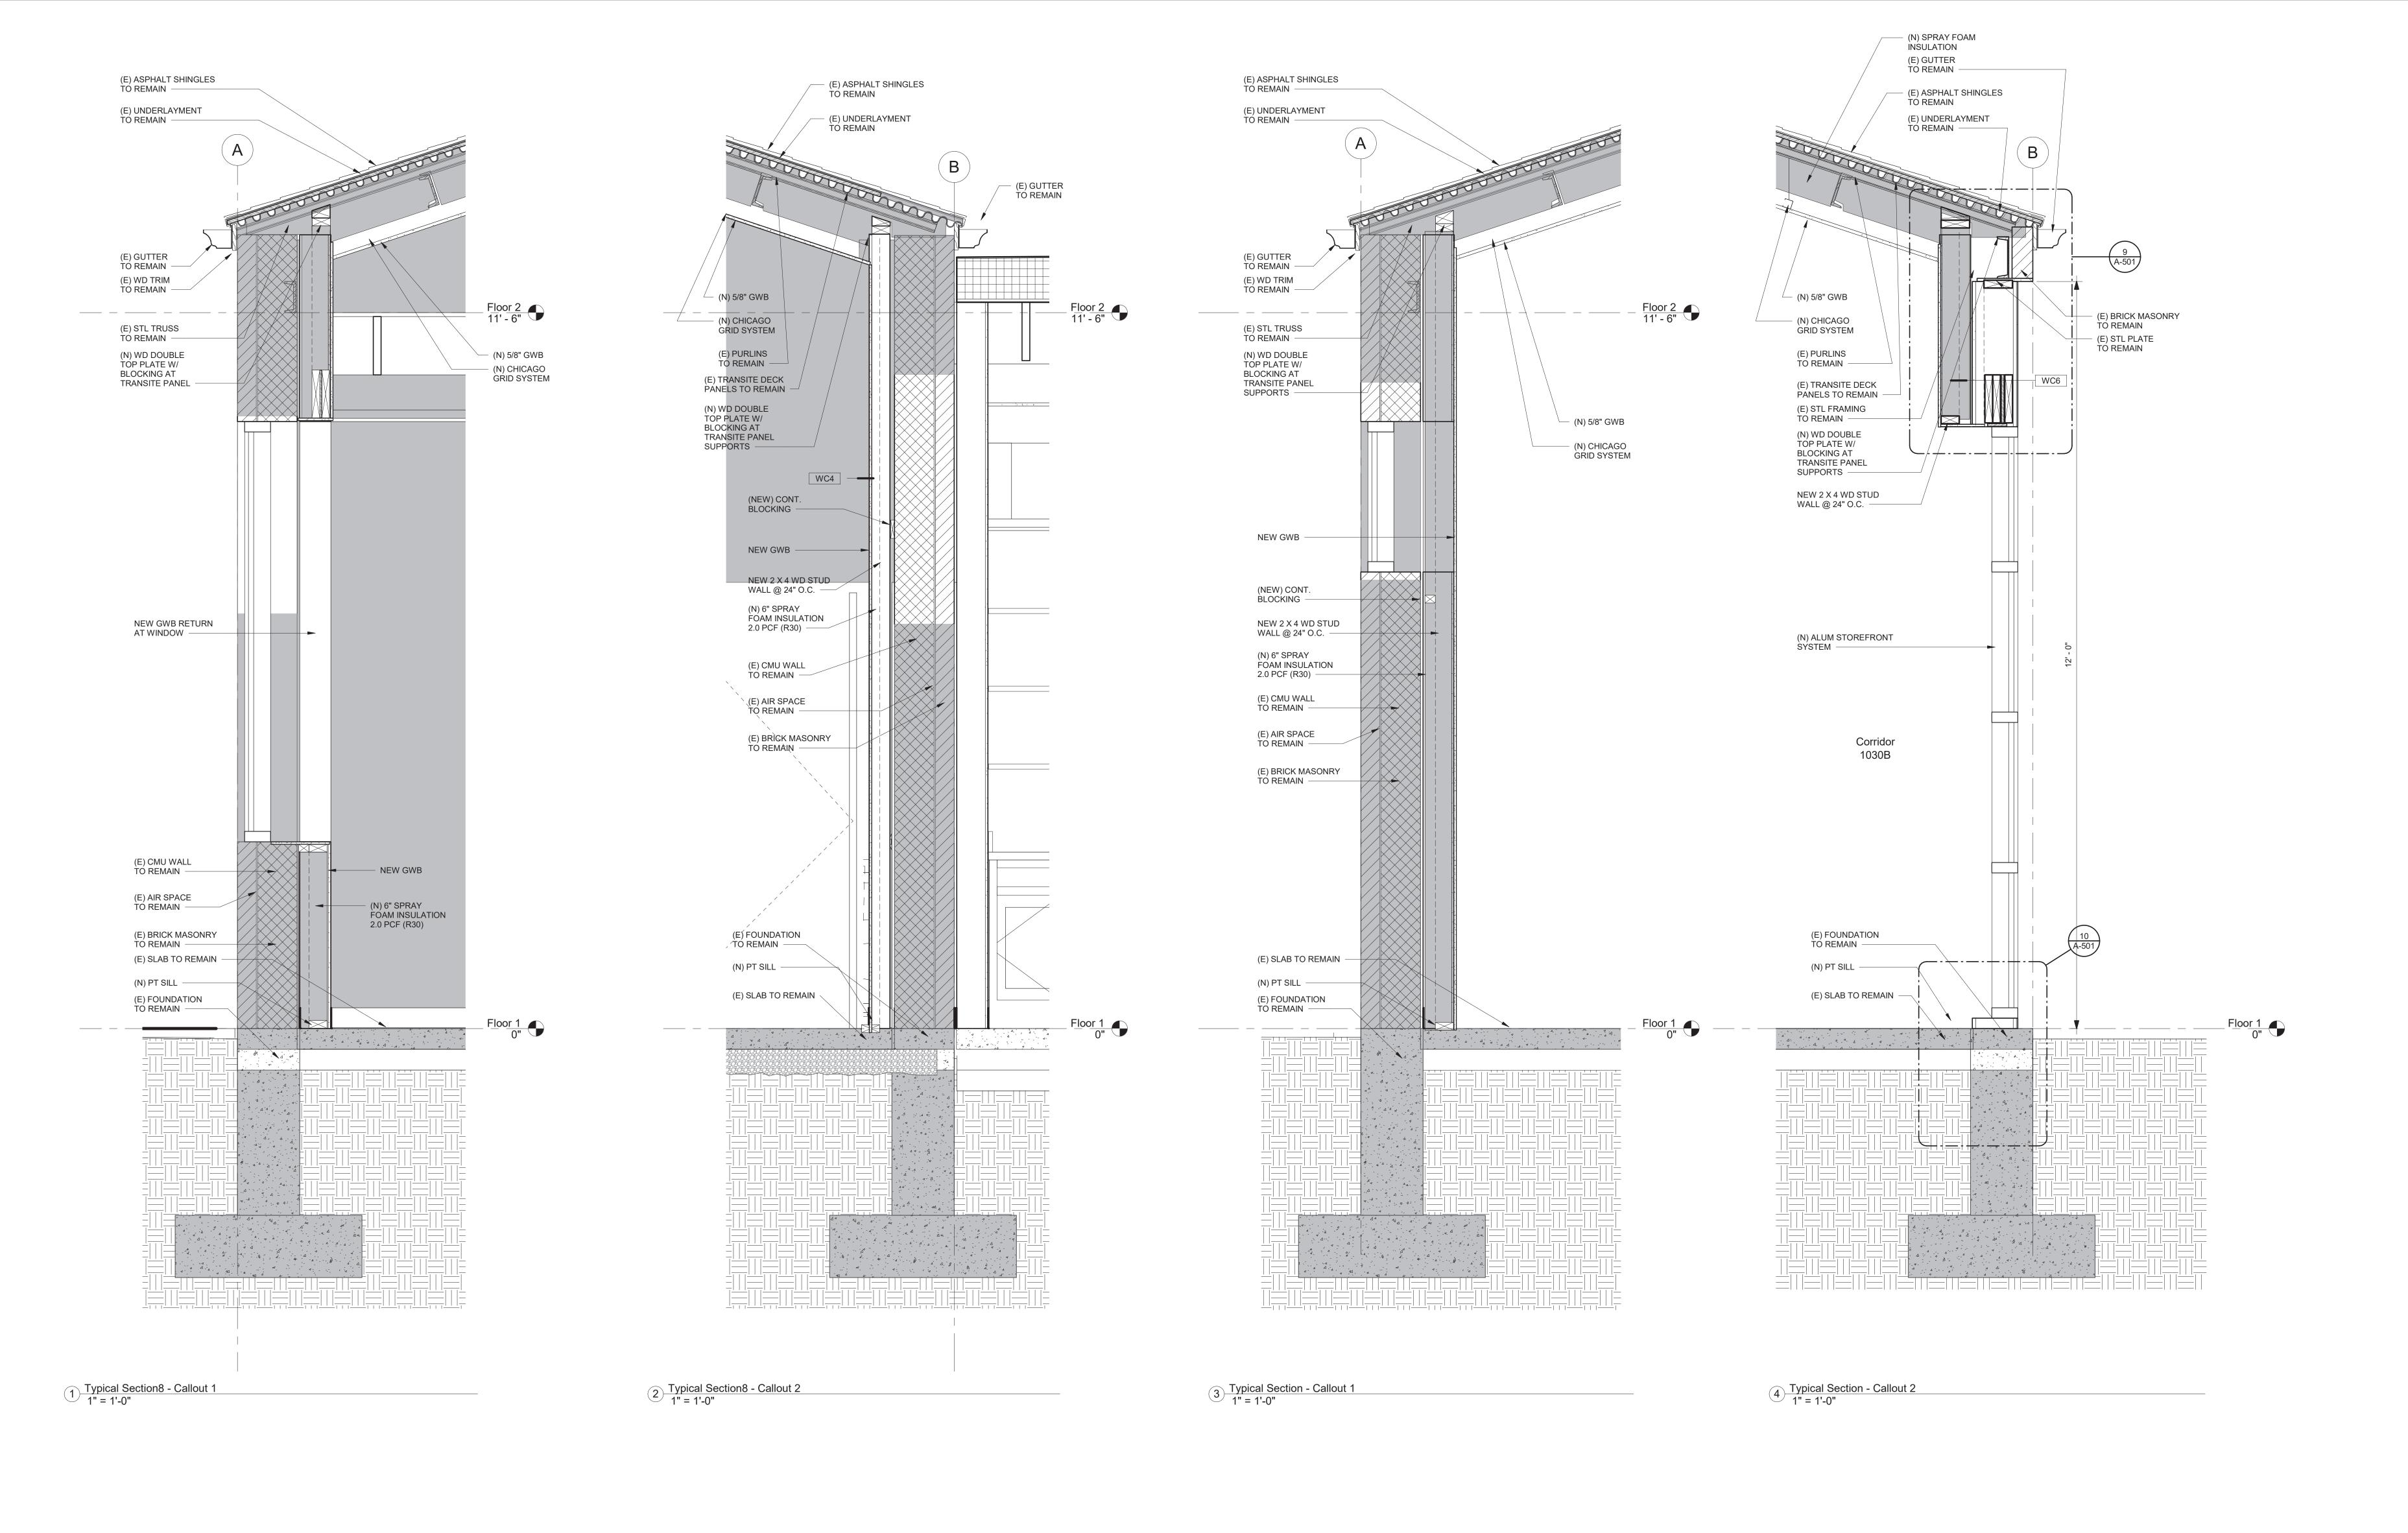


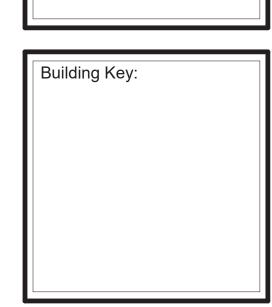


Sheet Title:

Building Sections
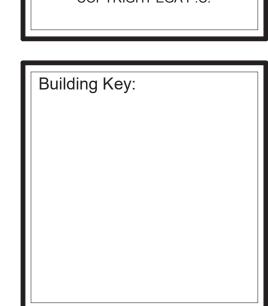
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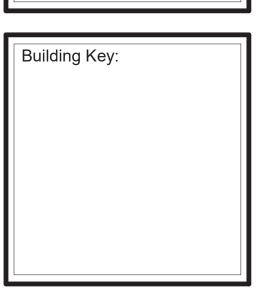


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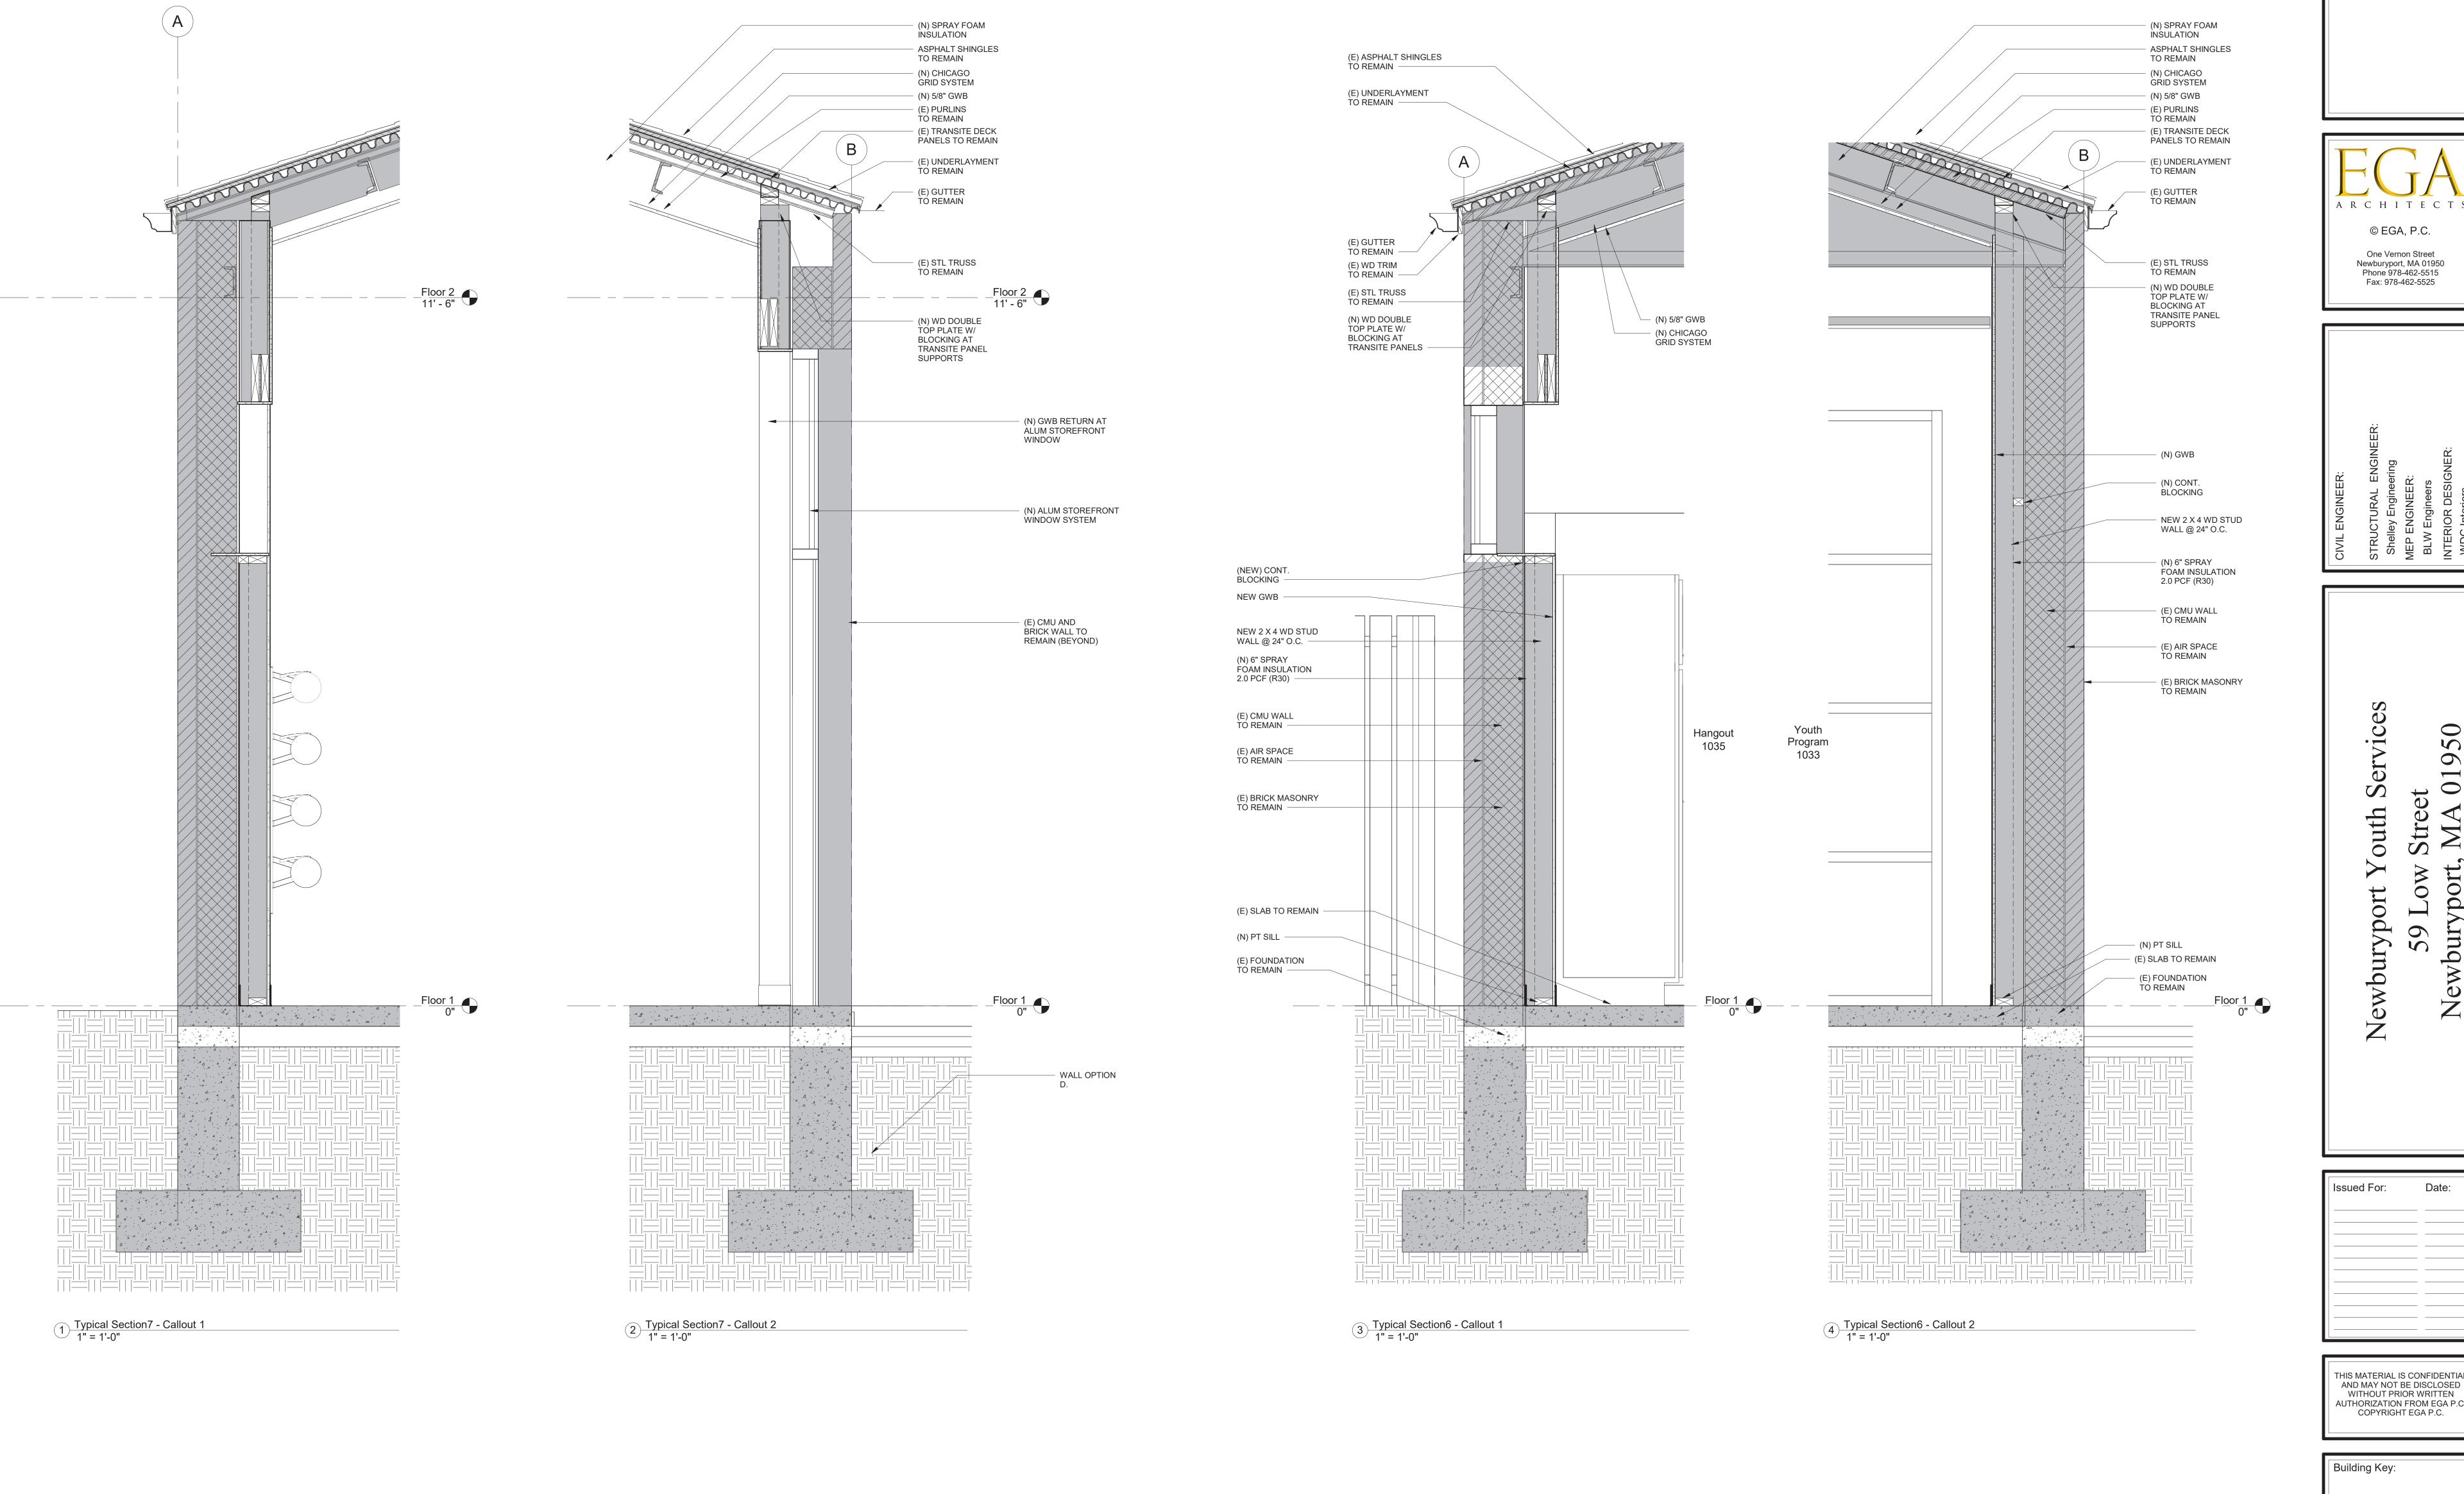

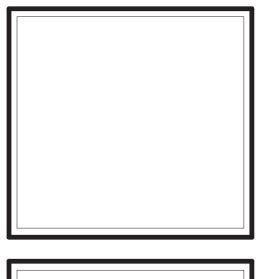
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Wall Sections

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A-403.0



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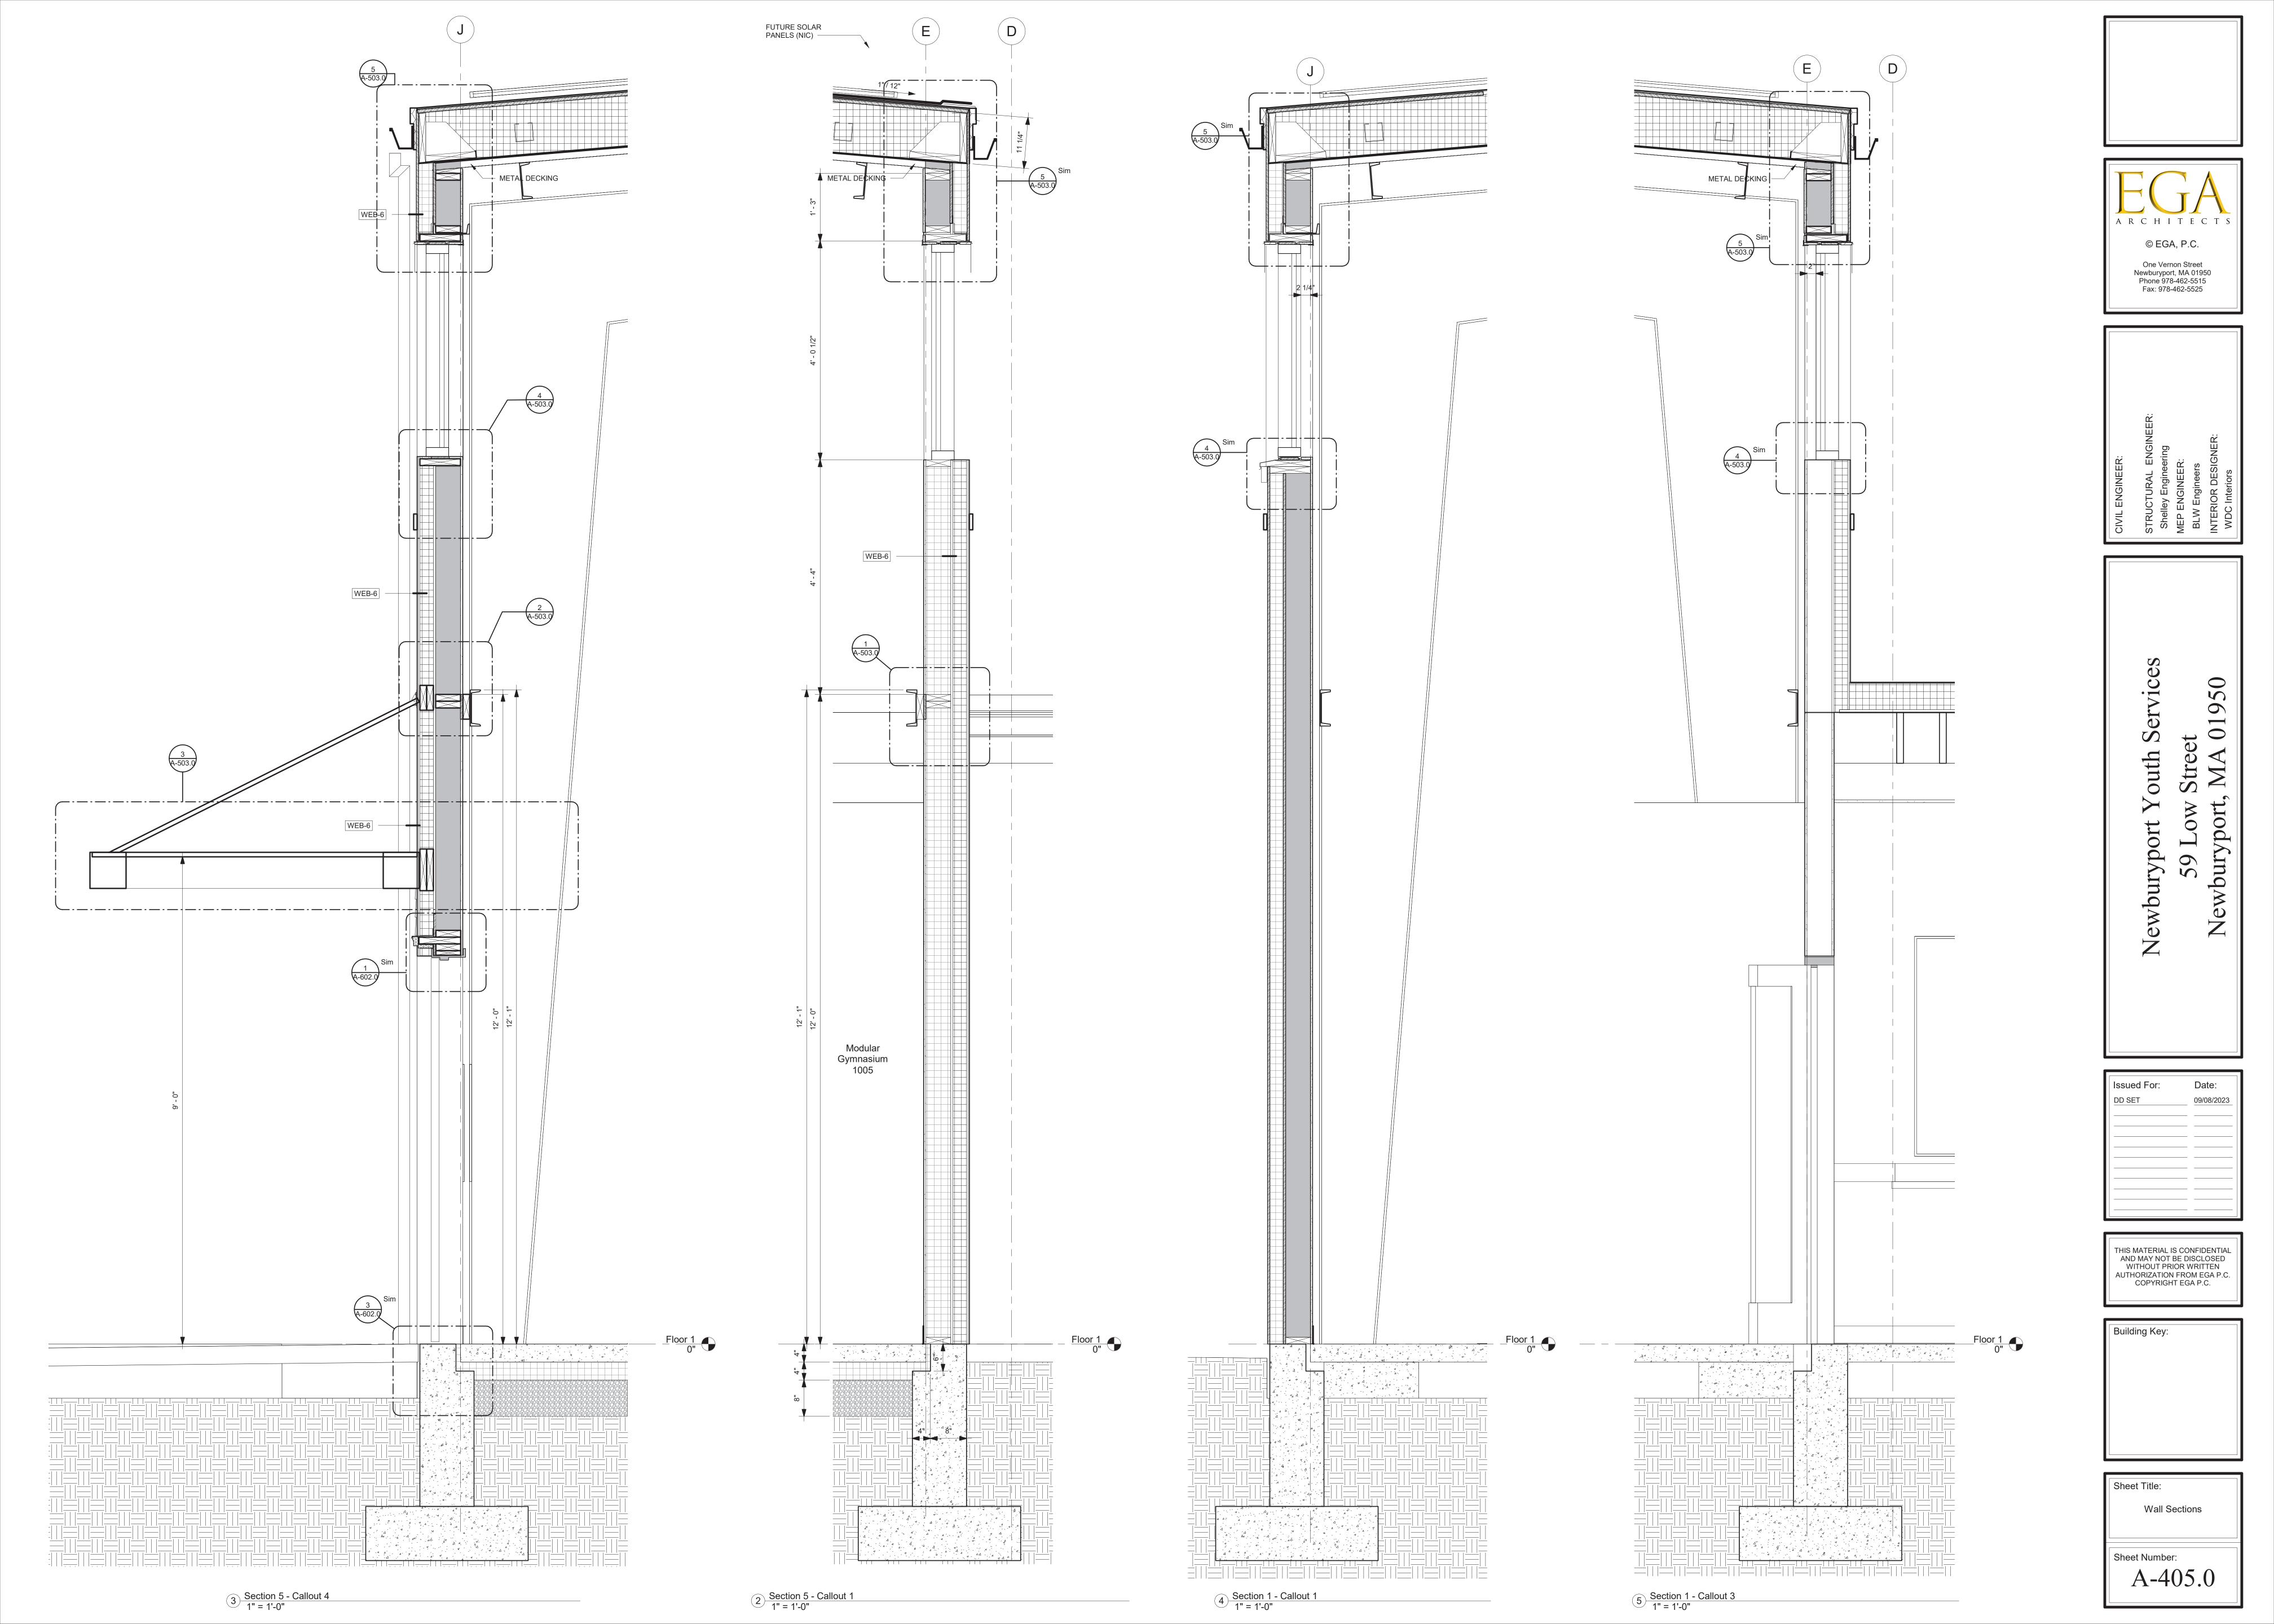
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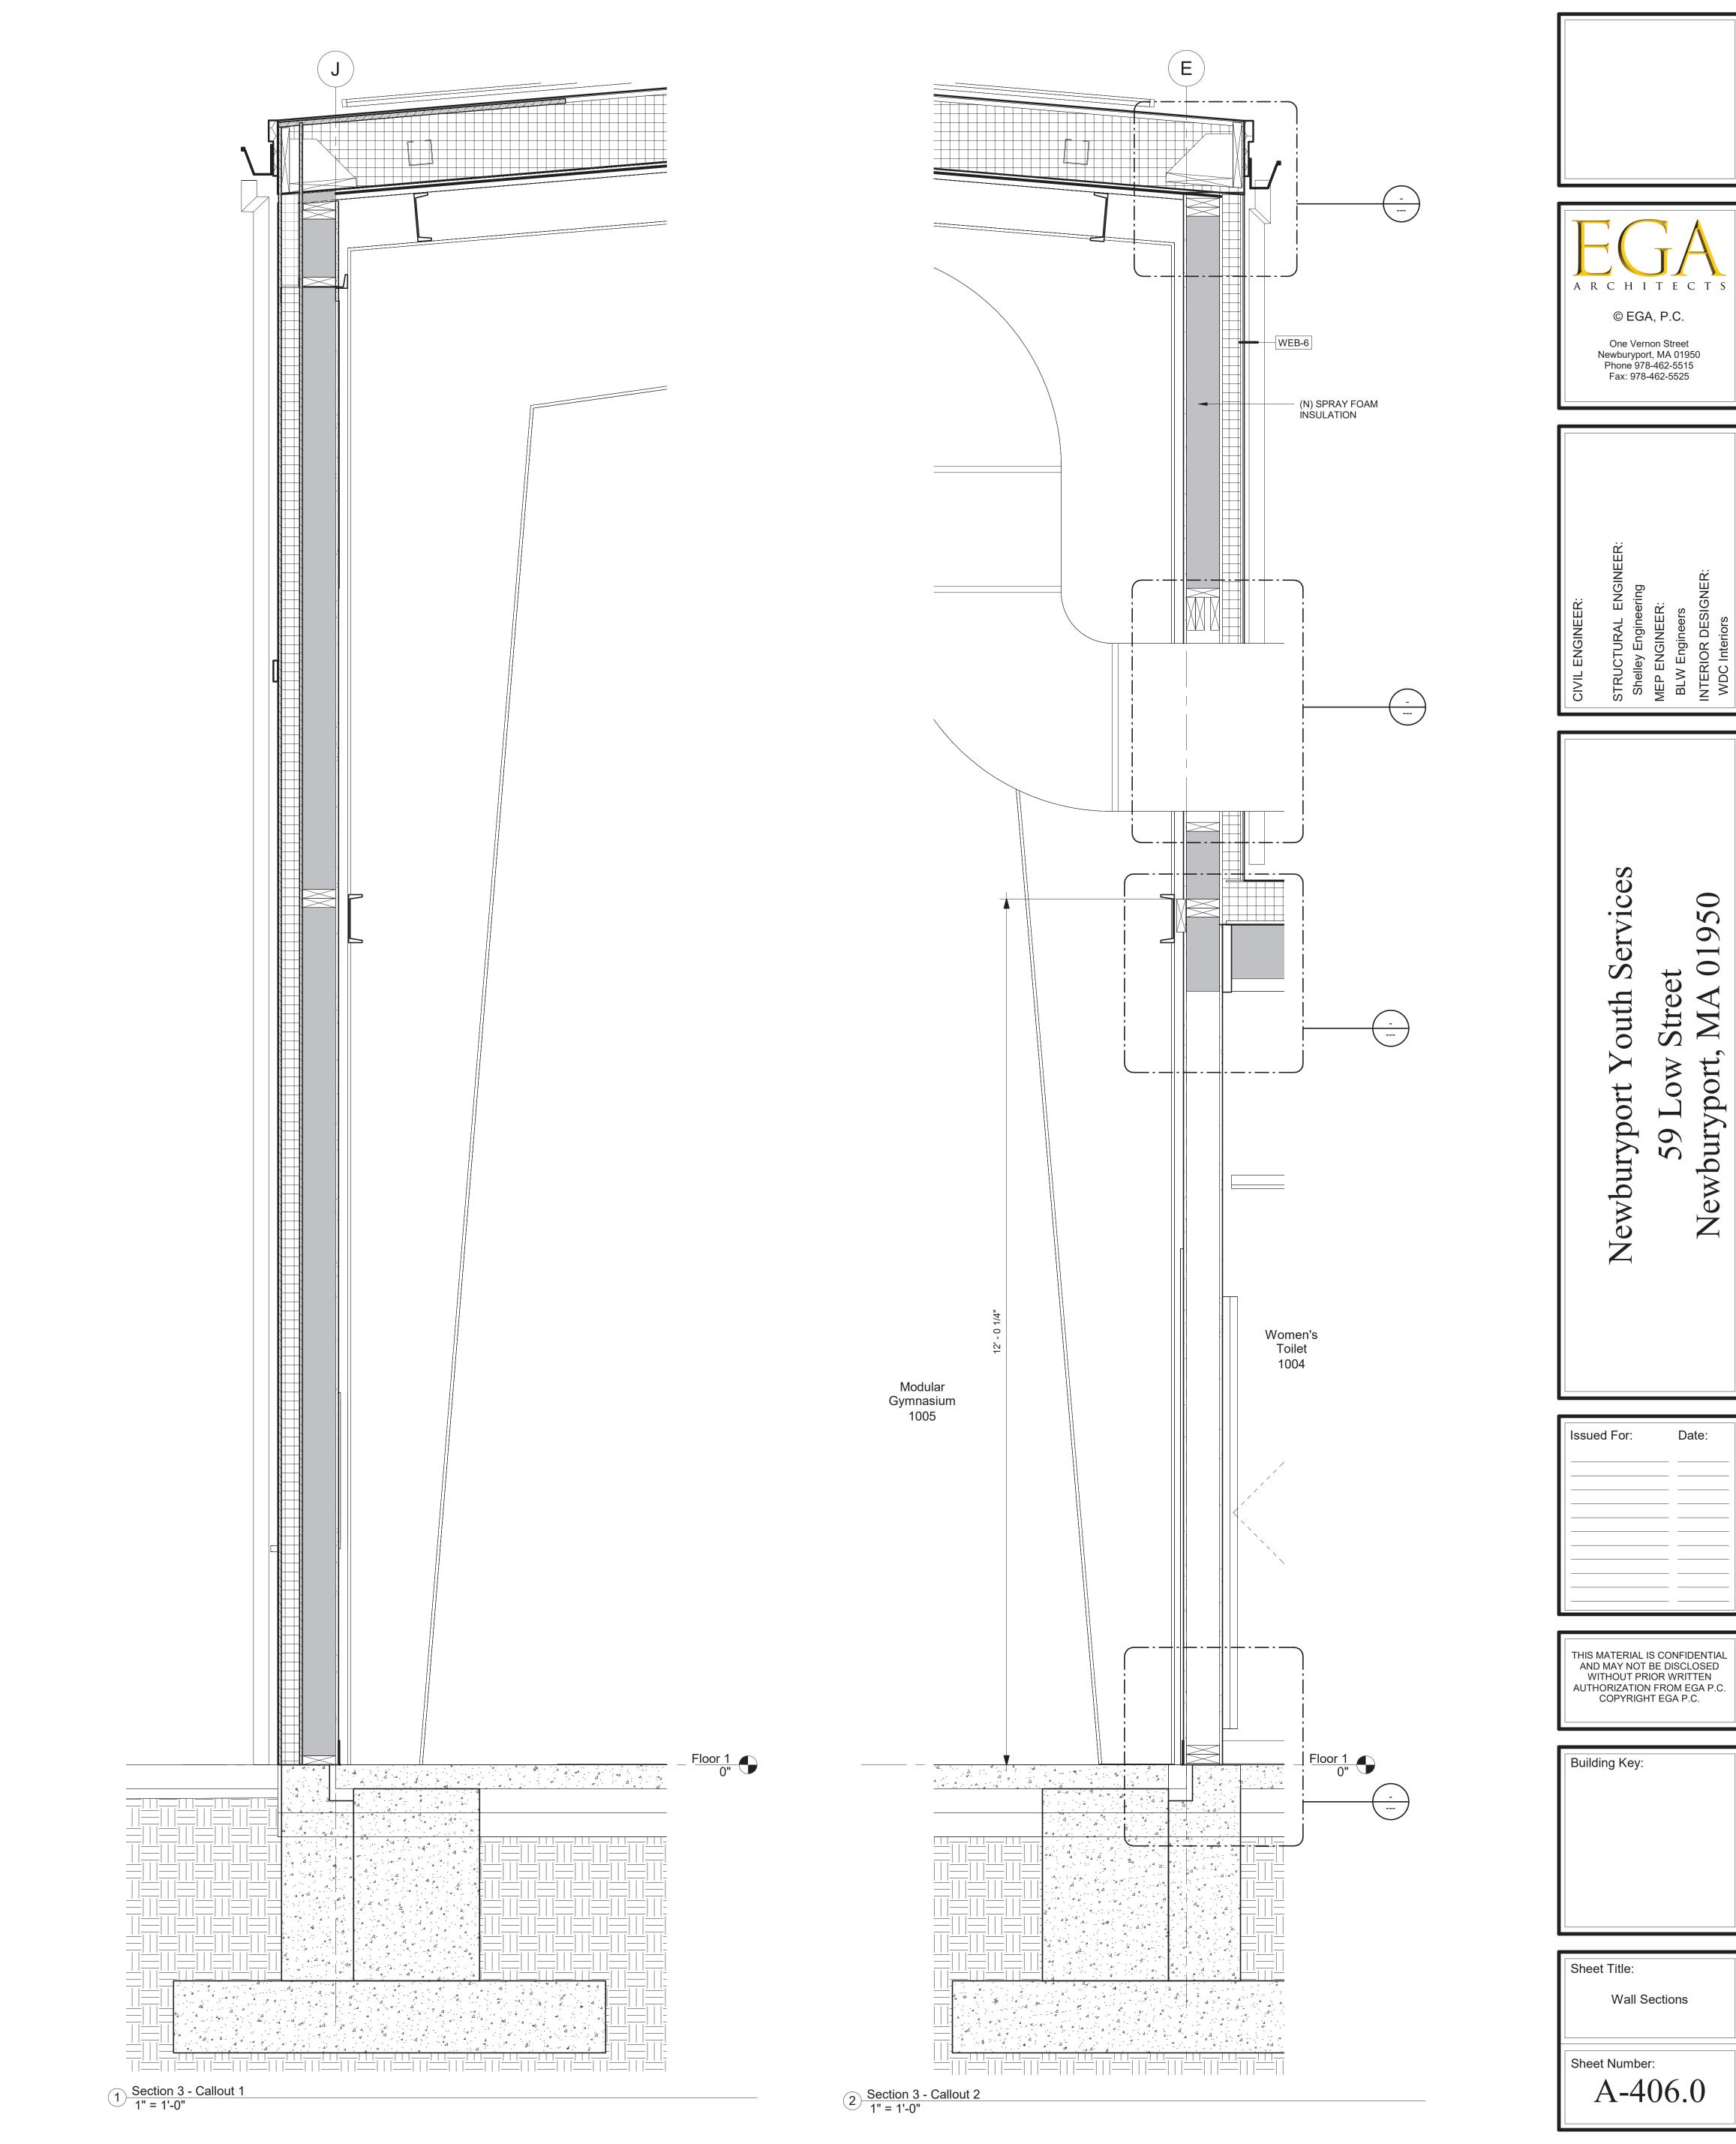
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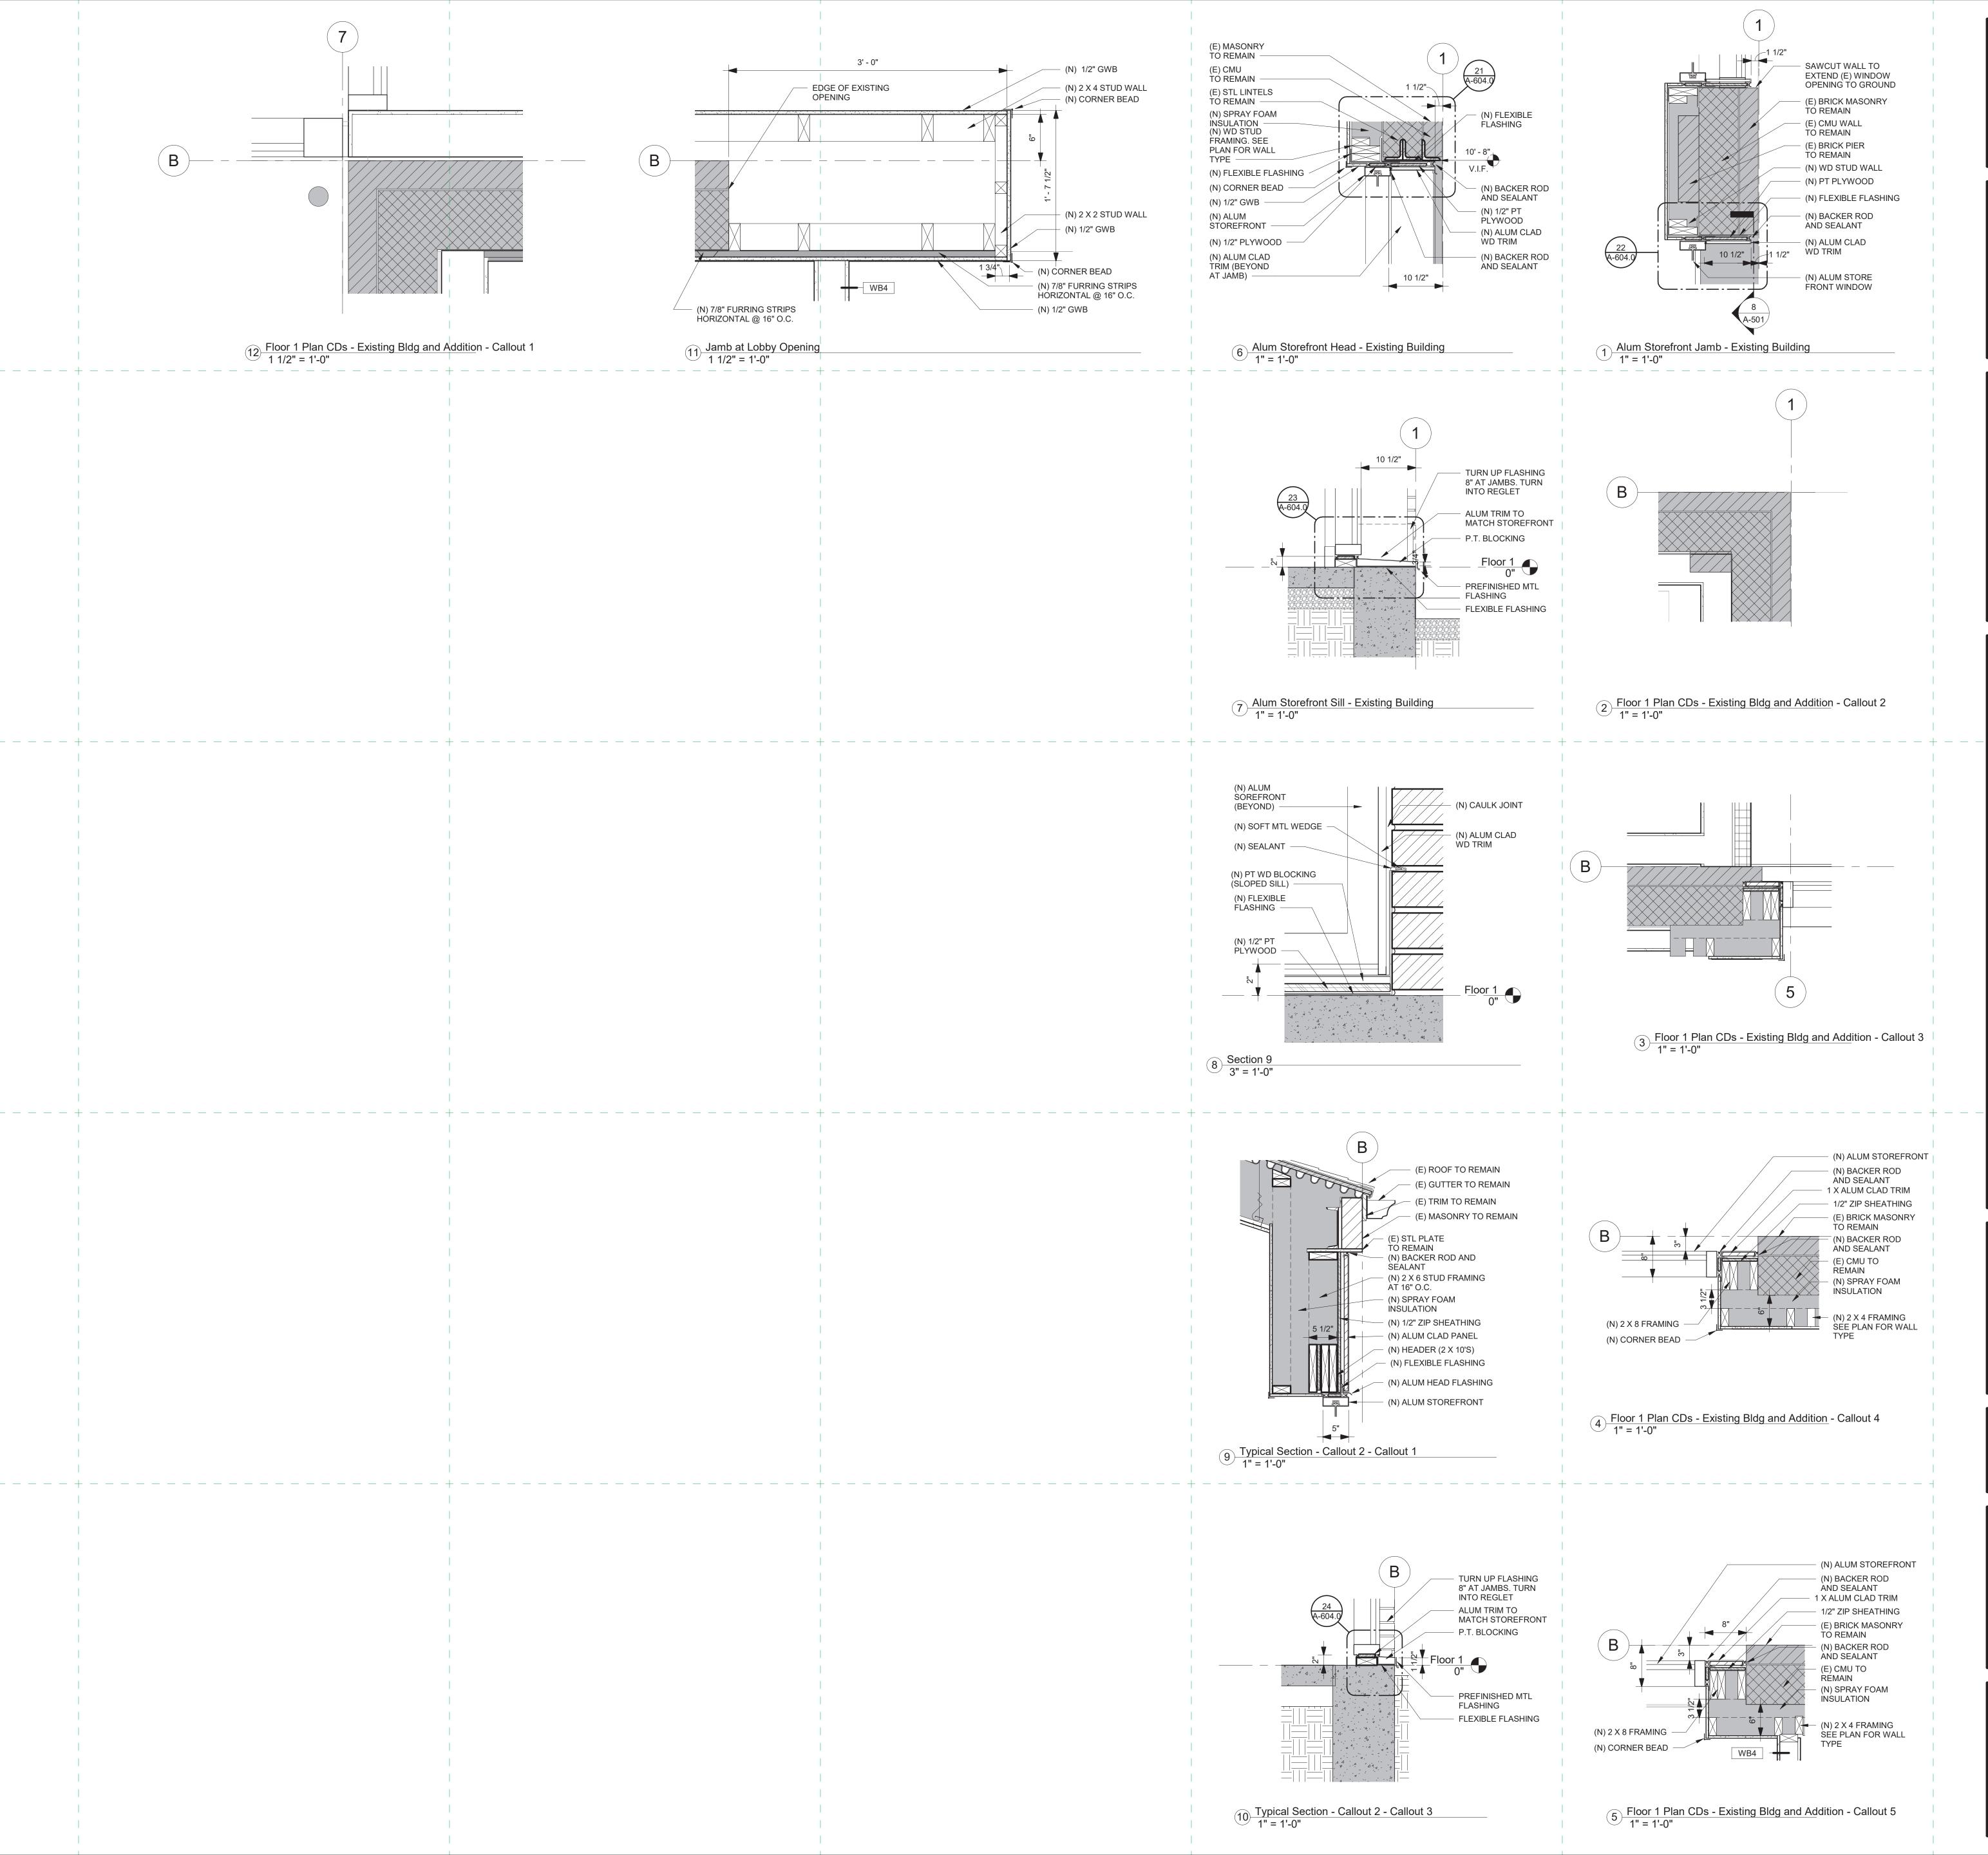
Wall Sections











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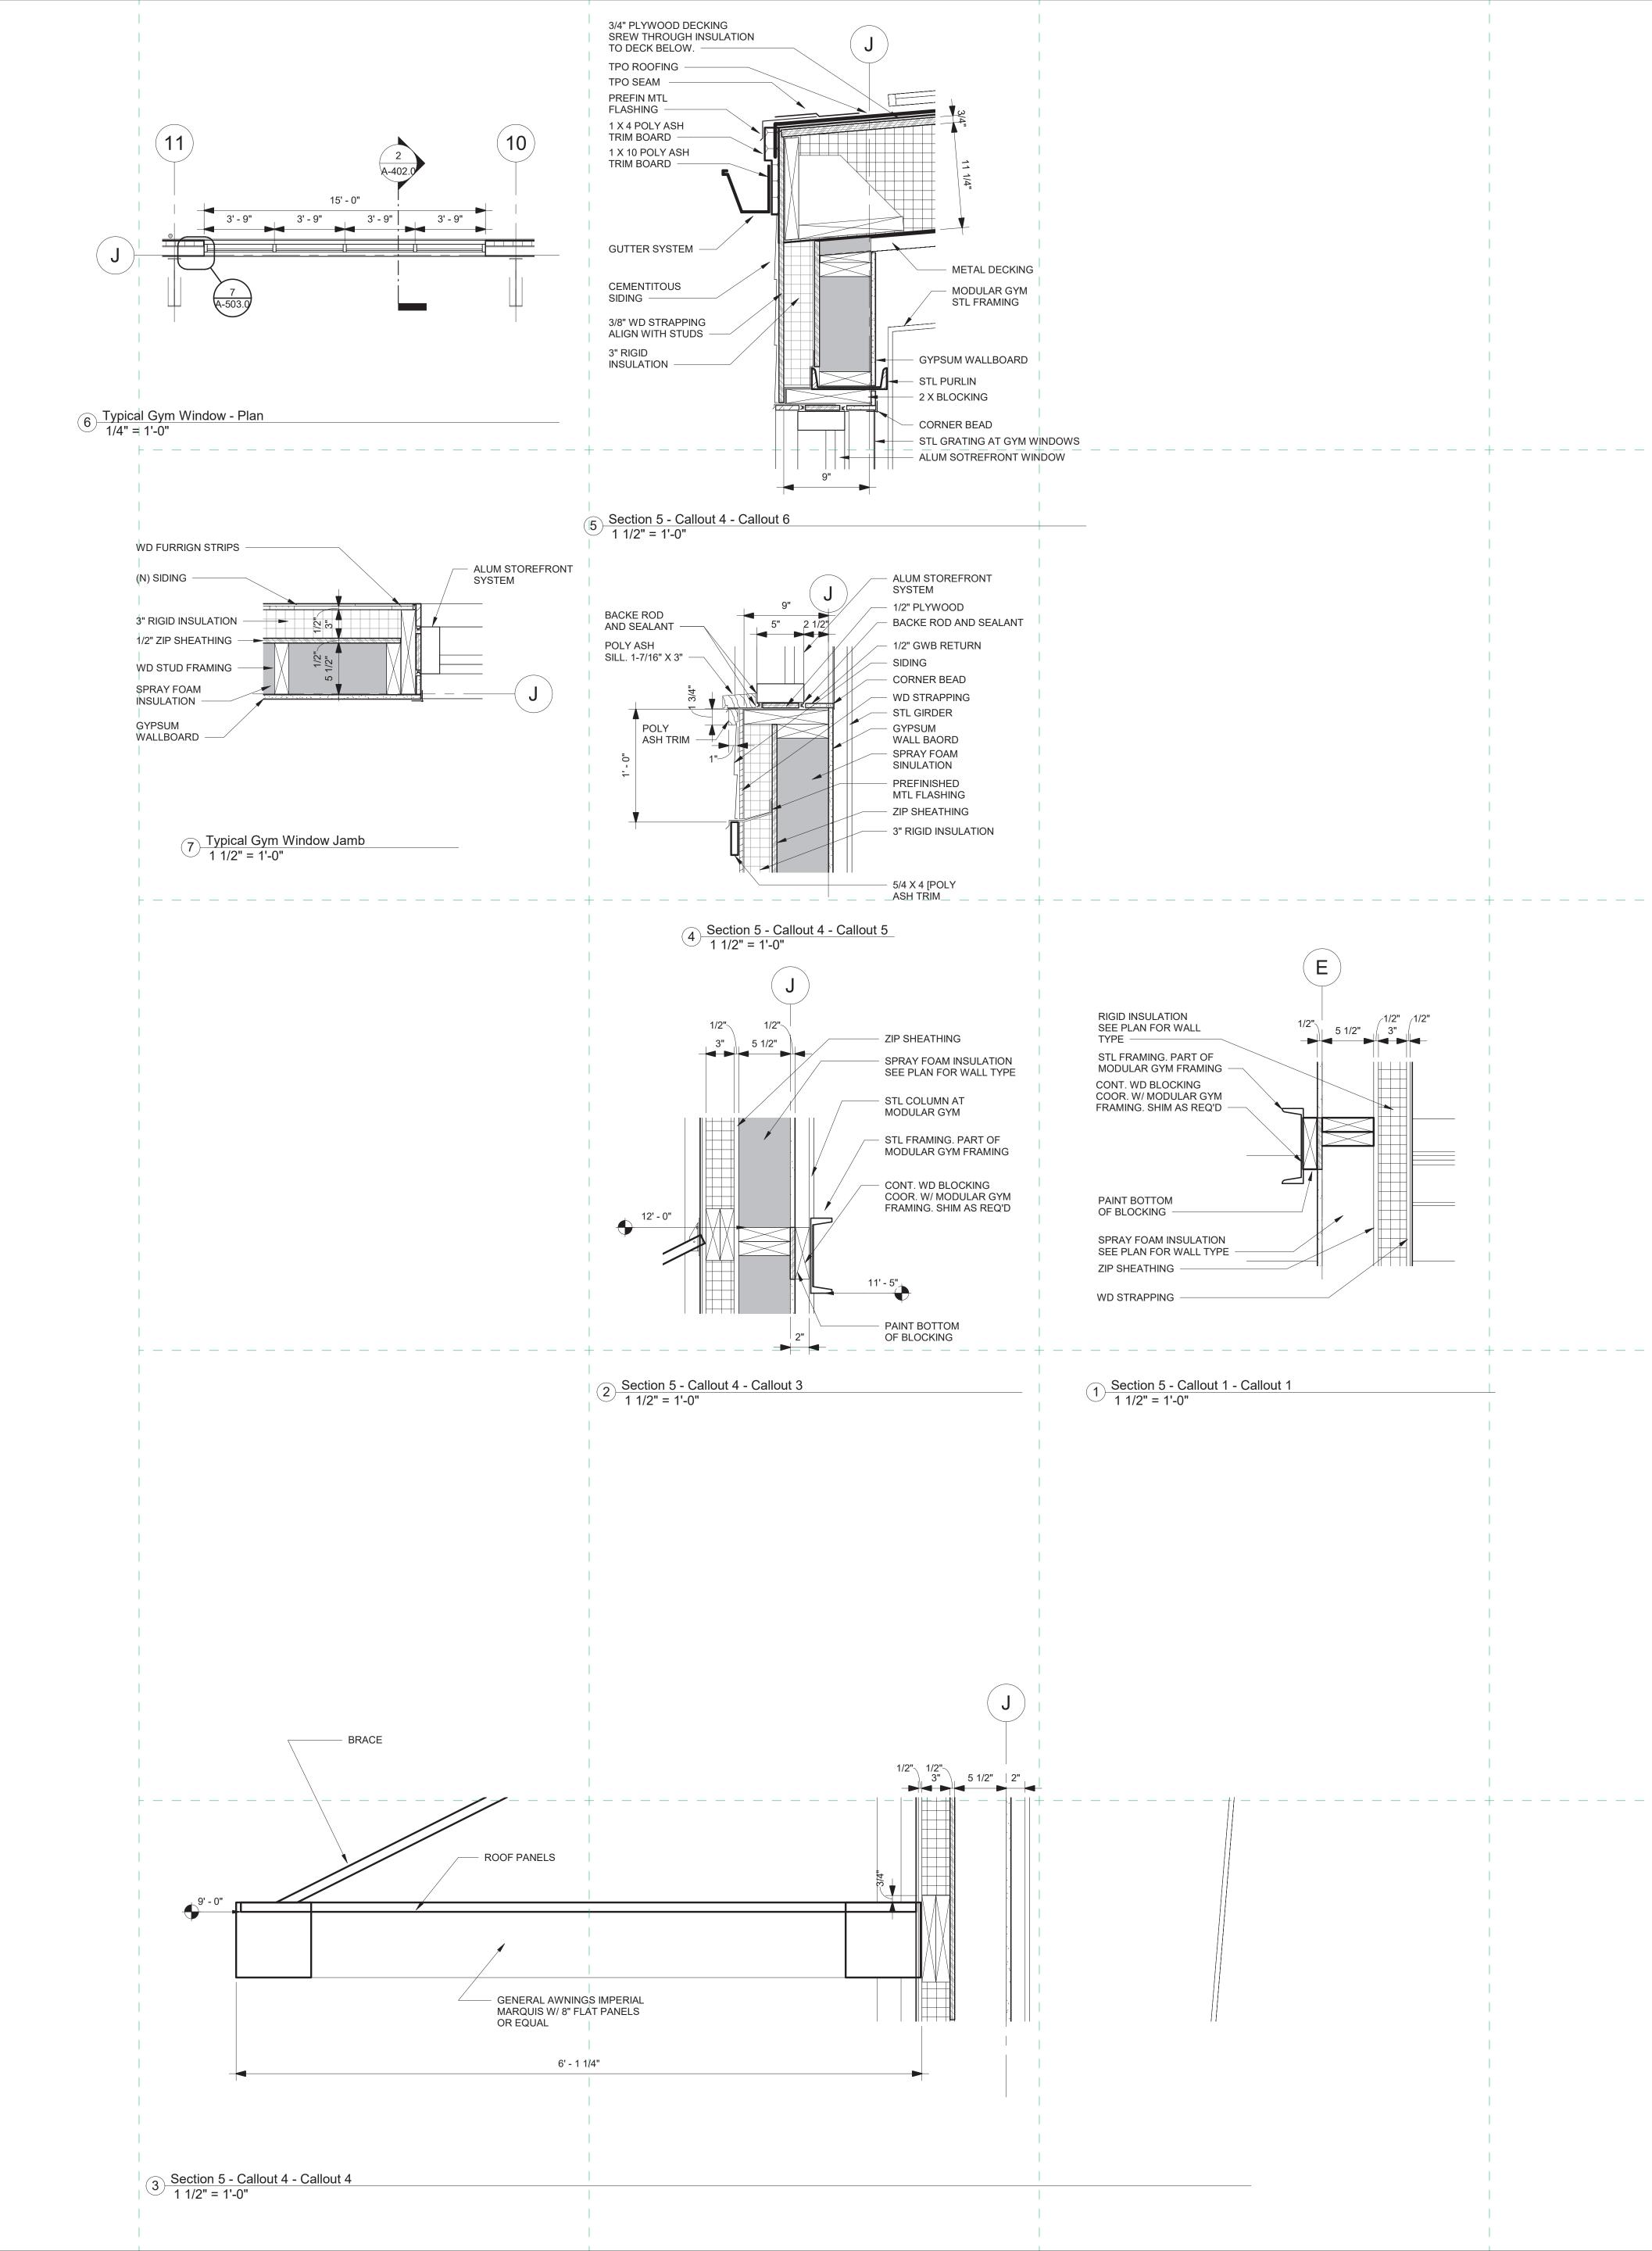
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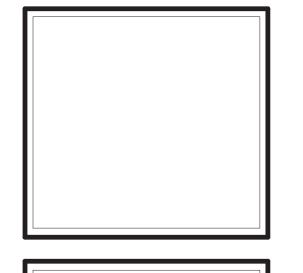
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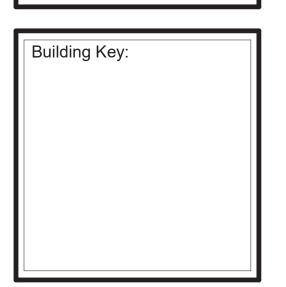


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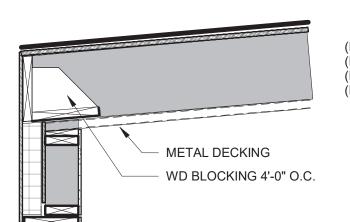


Sheet Title:

Modular Gym Details

Sheet Number:
A-503.0

ROOF/CEILING ASSEMBLIES



(N) TPO ROOFING (N) 3/4" PLYWOOD DECKING (N) 11 1/4" MIN. POLYISO INSULATION (N) METAL DECKING (PART OF MODULAR GYM)

(N) 3" MIN. TAPERED POLYISO INSULATION

(N) CEILING BELOW VARIES (SEE RCP PLANS)

(N) SPRAY FOAM INSULATION R40 MIN.

(N) TPO ROOFING

(N) 2 X 12 FRAMING

(N) PLYWOOD DECKING

FC-A

FC-B

LOAD BEARING


NO RATING

SLAB ON GRADE




FC-C LOAD BEARING NO RATING (AT 2ND FLR MECH. ROOM FLOOR




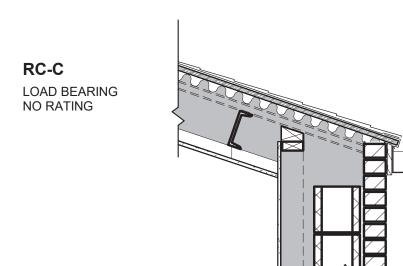



LOAD BEARING NO RATING



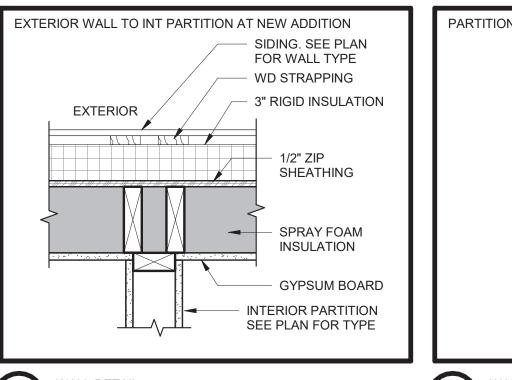


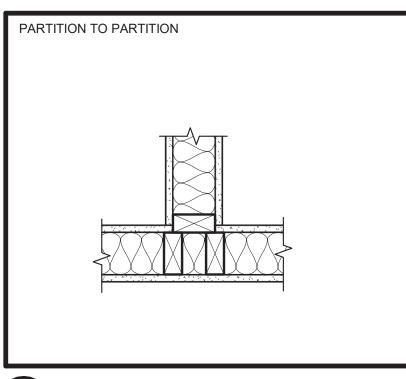


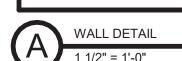


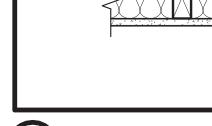


FLOOR/CEILING ASSEMBLIES

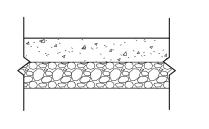

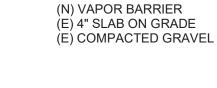

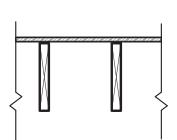




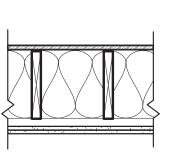

EXTERIOR WALLS EXTERIOR NON-LOAD BEARING RATING: O HOUR

EXTERIOR

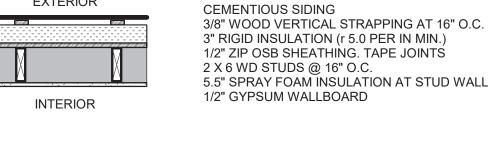

CEMENTIOUS SIDING

2 X 6 WD STUDS @ 16" O.C.

1/2" GYPSUM WALLBOARD

(E) BRICK MASONRY

(E) CMU WALL

INSIDE (E) WALL

3/8" WOOD VERTICAL STRAPPING AT 16" O.C.

5.5" SPRAY FOAM INSULATION AT STUD WALL


NEW 2 X 4 STUD FRAMING @ 16" O.C.

(N) 6" 2.0 PCF SPRAY FOAM INSULATION

3" RIGID INSULATION (r 5.0 PER IN MIN.)


1/2" ZIP OSB SHEATHING. TAPE JOINTS

LOAD BEARING RATING: 0 HOUR (NEW ADDITION WALLS) INTERIOR

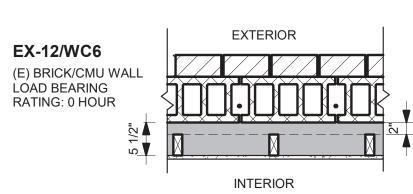

NON LOAD BEARING RATING: 0 HOUR (NEW INFILL WALLS)

(GYM WALLS)

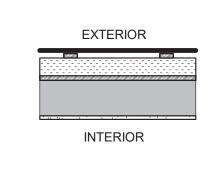

CEMENTIOUS SIDING 3/8" WOOD VERTICAL STRAPPING AT 16" O.C. 3" RIGID INSULATION (r 5.0 PER IN MIN.) 1/2" ZIP OSB SHEATHING. TAPE JOINTS 2 X 6 WD STUDS @ 16" O.C. 5.5" SPRAY FOAM INSULATION AT STUD WALL 1/2" GYPSUM WALLBOARD

NON-RATED PARTITIONS WOOD STUDS SHOWN - METAL CAN BE SUBSTITUTED EQUALLY (M)(W)A#-(S)(D)5/8" GYPSUM WALLBOARD # STUDS NON-LOAD BEARING RATING: 0 HOUR 5/8" GYPSUM WALLBOARD WALLS WITH (S) - SOUND BATT stc 45 W/ INSULATION INSULATION TO FILL CAVITY (M)(W)B#-(S)(D)1/2" GYPSUM WALLBOARD # STUDS NON-LOAD BEARING 1/2" GYPSUM WALLBOARD WALLS WITH (S) - SOUND BATT RATING: 0 HOUR stc 45 W/ INSULATION INSULATION TO FILL CAVITY (M)(W)C#-(S)(D)5/8" GYPSUM WALLBOARD # STUDS NON-LOAD BEARING WALLS WITH (S) - SOUND BATT RATING: 0 HOUR INSULATION TO FILL CAVITY (M)(W)D#-(S)(D)1/2" GYPSUM WALLBOARD # STUDS NON-LOAD BEARING WALLS WITH (S) - SOUND BATT RATING: 0 HOUR INSULATION TO FILL CAVITY (M)(W)G#-(S)(D)1/2" GYPSUM WALLBOARD # STUDS NON-LOAD BEARING 1/2" PLYWOOD RATING: 0 HOUR 1/2" GYPSUM WALLBOARD stc 45 W/ INSULATION WALLS WITH (S) - SOUND BATT **BATHROOM SIDE**

(M)(W)H#-(S)(D)

RATING: 0 HOUR

NON-LOAD BEARING

stc 45 W/ INSULATION

5/8" GYPSUM WALLBOARD # STUDS 1/2" PLYWOOD 5/8" GYPSUM WALLBOARD WALLS WITH (S) - SOUND BATT **BATHROOM SIDE** INSULATION TO FILL CAVITY

INSULATION TO FILL CAVITY


ASSEMBLY NOTATION SYSTEMS

∠ ROOF/CEILING ASSEMBLY INDICATES USE OF WOOD STUDS --(W)(E)A-#INDICATES EXTERIOR WALL ASSEMBLY TYPE

WALL WIDTH SCHEDULE

WOOD ST	TUD WIDTH SCHEDULE	METAL S	METAL STUD WIDTH SCHEDULE						
# SYMBOL	WOOD STUD WIDTH (ACTUAL)	# SYMBOL	METAL STUD WIDTH (ACTUAL)						
L	LAMINATED TO CMU	L	LAMINATED TO CMU						
RC	1/2" RESILIENT CHANNELS	RC	1/2" RESILIENT CHANNELS						
F	7/8" FURRING CHANNELS	F	7/8" FURRING CHANNELS						
Z	1 1/2" Z STUDS WITH RIGID INSULATION	Z	1 1/2" Z STUDS WITH RIGID INSULATION						
1	NOT USED	1	1 5/8"						
2	1 1/2"	2	2 1/2" (ALSO C-H STUD)						
3	NOT USED	3	3-5/8						
4	3 1/2"	4	4" C-H STUD						
5	NOT USED	5	NOT USED						
6	5 1/2"	6	6"						
7	NOT USED	7	NOT USED						
8	7 1/4"	8	8"						
10	9 1/4"	10	10"						
12	11 1/4"	12	12"						

- **GENERAL NOTES** CONTRACTOR TO VERIFY AND INSTALL ALL COMPONENTS PER LISTED ASSEMBLIES STUD SPACING LISTED IS MAXIMUM FOR ALL WALL ASSEMBLIES
- REFER TO STRUCTURAL FOR STUD SPACING OF BEARING WALLS REFER TO MECHANICAL AND PLUMBING DRAWINGS TO COORDINATE SIZE AND LOCATION OF SHAFTS. CONTRACTOR TO PROVIDE APPLICABLE TYPE OF TILE BACKER BOARD WHEREVER TILE IS INDICATED ON THE FINISH
- NON-LOAD BEARING WALL STUD SPACING AT 16" O.C., U.O.N.

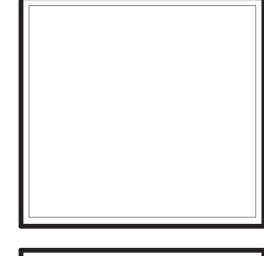




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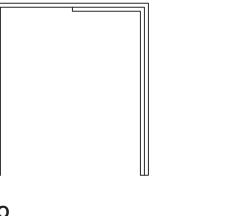
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Building Key:

Sheet Title: Assemblies Sheet Number:

		Door Schedule														
		Door Frame														
Door Number	Room Name	Width	Height	Thickness	Туре	Mater ial	Fini h	s Type	Material	Finish	Head Detail	Jamb Detail	Sill Detail	Fire Rating	Hard ware	
1000	Vestibule	6' - 1"	7' - 11"		2SF										1	STOREFRONT SYSTEM
1001	Vestibule	6' - 1"	7' - 11"		2SF										1	STOREFRONT SYSTEM
1002a	Concession	3' - 0"	7' - 0"	1 3/8"	E1	WD	PT	S	WD	PT					4a	POCKET DOOR
1002b	Concession	2' - 6"	7' - 0"	1 3/8"	E1	WD	PT	S	WD	PT					4	
1003	Men's Toilet	3' - 0"	7' - 0"	1 3/8"	E1	WD	РТ	S	НМ	PT					5	
1004	Women's Toilet	3' - 0"	7' - 0"	1 3/8"	E1	WD	PT	S	НМ	PT					5	
1005a	Lobby	7' - 0"	7' - 0"	1 3/8"	2F	НМ	PT	S	НМ	PT				90	2	
1005b	Modular Gymnasium	3' - 0"	7' - 0"	1 3/8"	F	НМ	PT	S	НМ	PT					3	
1005c	Modular Gymnasium	3' - 0"	7' - 0"	1 3/8"	F	НМ	PT	S	НМ	PT					3	
1006a	Storage	3' - 0"	7' - 0"	1 3/8"	F	НМ	PT	S	НМ	PT				90	4	
1006b	Storage	6' - 0"	7' - 0"	1 3/8"	2F	НМ	PT	S	НМ	PT					4b	
1010	Lobby	3' - 2"	7' - 2"	1. 0, 0	SF	1									3	STOREFRONT SYSTEM
1011	Jan.	6' - 0"	7' - 0"	1 3/8"	2E1	WD	PT	S	НМ	PT					4b	
1012a	Toilet	3' - 0"	7' - 0"	1 3/8"	E1	WD	PT	S	HM	PT					4	
1012b	Toilet	3' - 0"	7' - 0"	1 3/8"	DD	WD	PT	S	HM	PT					4	DUTCH DOOR
1013a	Early Ed	3' - 0"	7' - 0"	1 3/8"	E1	WD	PT	S	HM	PT					4	30101130011
1013b	Water	6' - 0"	7' - 0"	1 3/8"	2E1	HM	PT	S	HM	PT					4b	
1013c	Early Ed	3' - 0"	7' - 0"	1 3/8"	E1	WD	PT	S	HM	PT					4	
1013d	Early Ed	3' - 2"	7' - 3"	1 0/0	SF	770	 		1 IIVI						3	STOREFRONT SYSTEM
1021	Assist.	3' - 1"	7' - 1"		SF										1	STOREFRONT SYSTEM
1021 1022a	Director	3' - 0"	7' - 0"	1 3/8"	E1	WD	PT	S	НМ	PT					4	OTORETRONT STOTEM
1022a	Director	3' - 0"	7' - 0"	1 3/8"	E1	WD	PT	S	WD	PT					4a	POCKET DOOR
10225	Multi. Purpose	3' - 0"	7' - 0"	1 3/8"	E1	WD	PT	S	HM	PT					4	FOCKET BOOK
1023 1024a	Art	3' - 0"	7' - 0"	1 3/8"	E1	WD	PT	S	HM	PT					6	
1024a	Art	5' - 0"	7' - 0"	1 3/8"	2FG	WD	PT	S	HM	PT					6a	UNEVEN - 36" + 24" LEAFS
1024b	Art	3' - 0"	7' - 0"	1 3/8"	E1	WD	PT	S	НМ	PT					4	UNLVLIN- 30 T 24 LEAFS
10240	Social	3' - 0"	7' - 0"	1 3/8"	E1	WD	PT	S	НМ	PT					4	
1025	Rec/Enrich	3' - 0"	7' - 0"	1 3/8"	E1	WD	PT	S	HM	PT					4	
	Corridor	6' - 8"	7' - 0"	1 3/8"	20	HM	PT	S	НМ	PT					6b	OPPOSITE SWING, W/ LOCKING
1030a		3' - 0"	7' - 0"	1 3/0	SF	ITIVI		3	ΠIVI	FI				+	3	·
1030b	Corridor	3' - 0"		1 2/0"	E1	WD	PT	S	HM	PT					4	STOREFRONT SYSTEM
1031	Stair		7' - 0"	1 3/8"											4	
1032	Study	3' - 0"	7' - 0"	1 3/8"	E1	WD	PT	S	HM	PT					4	
1033	Youth Program	3' - 0"	7' - 0"	1 3/8"	E1	WD	PT	S	HM	PT					4	
1034	Storage	6' - 0"	7' - 0"	1 3/8"	2E1	WD	PT	S	HM	PT					4b	
2001	Storage	3' - 0"	6' - 8"	1 3/8"	F	WD	PT	S	HM	PT					4	DADNI DOGG
2005	Mechanical	5' - 0"	6' - 8"	1 3/8"	BD	WD	PT	S	WD	PT					7	BARN DOOR



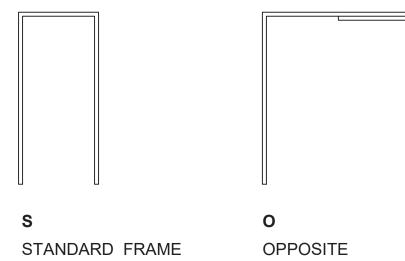

SWING FRAME

L# STANDARD FRAME WITH ONE SIDELITE # NUMBER **EQUALS WIDTH**

OF SIDELITE

(INCHES)

DOOR SCHEDULE LEGEND

DOOR TYPES F - FLUSH PANEL **E# - EMBOSSED PANEL** (#=NO OF PANELS)

HM - HOLLOW METAL WD - SOLID WOOD N - NARROW LITE **HG - HALF GLASS** FG - FULL GLASS D - DUTCH L - LOUVERED WS - WALL SLIDING (BARN DOOR)

DOOR AND FRAME MATERIALS

HC-HB - HOLLOW CORE

SC-HB - SOLID CORE

HB - HARDBOARD

FG - FIBERGLASS

AL - ALUMINUM


MTL - METAL


FRAMES S - STANDARD SC - STANDARD FRAME W/WOOD CASING **HM - METAL FRAME** WD - WOOD FRAME L# - SIDELITE (#=WIDTH IN INCHES) T# - TRANSOM (# = HEIGHT IN INCHES)
O - OPPOSING SWING
SF - STANDARD FLUSH


FRAME


DOOR AND FRAME FINISHES PT - FACTORY PRIME (PAINT IN FIELD) STN - STAIN AND **POLYURETHANE** NW - NATURAL WOOD **FINISH** PFM - FACTORY PRIME **AND PAINT**

Door Frame Type Legend and Notes
1/4" = 1'-0"

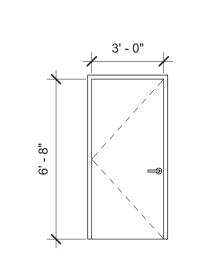


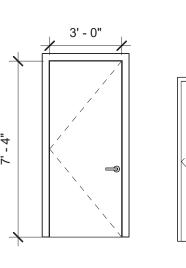

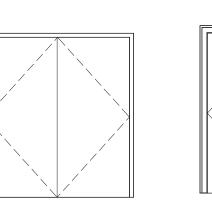


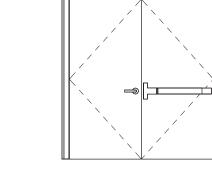

<u>Door Schedule</u> 1/4" = 1'-0"

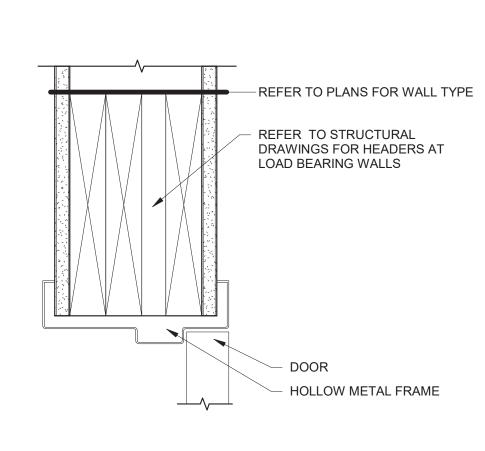



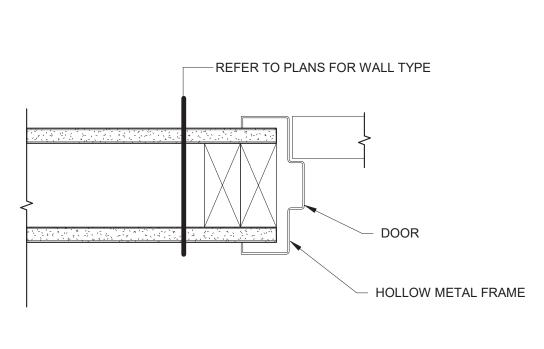

REFER TO FINISH SCHEDULE FOR FLOORING

MARBLE THRESHOLD

REFER TO


FOR FLOORING

TRANSITION STRIP


FINISH SCHEDULE

8 Door Sill Interior Vinyl Transition
3" = 1'-0"


6 Door Sill Interior Marble 3" = 1'-0"

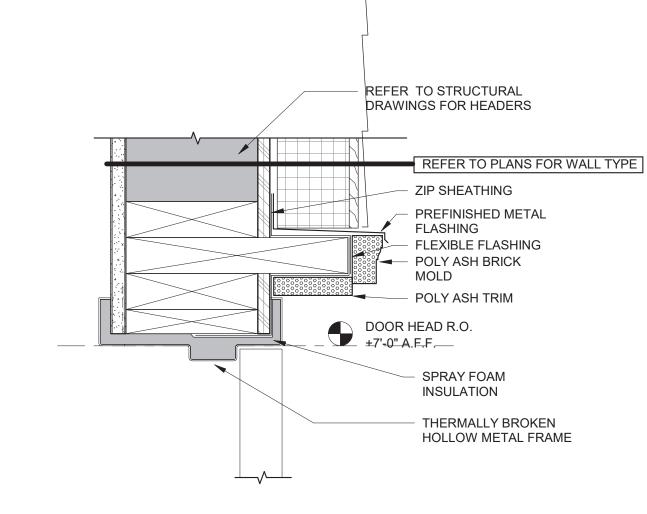


Detail Door Head Mtl Frame Exterior Brick Mold WC-1 3" = 1'-0"

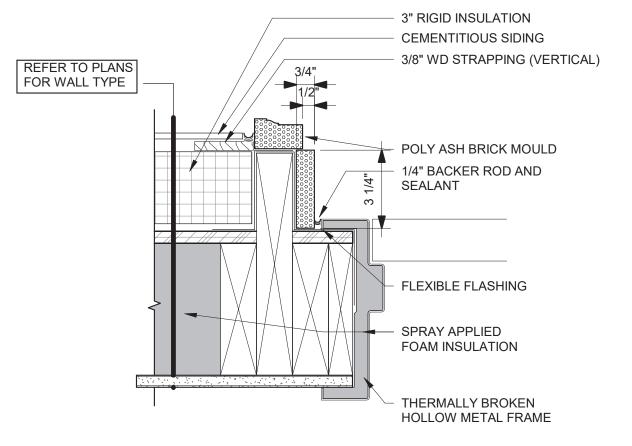


Detail Door Jamb Mtl Frame Tabs Exterior Brick Mold WC-1
3" = 1'-0"

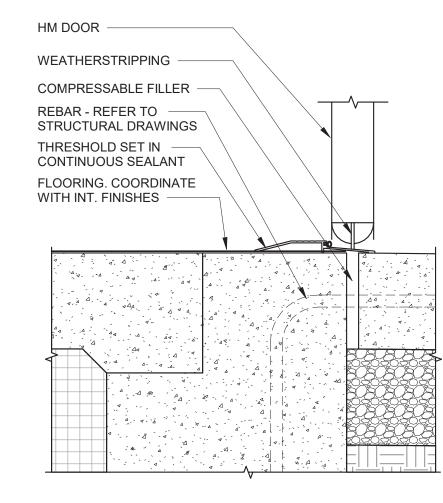

3 Detail Door Sill Exterior Metal Threshold
3" = 1'-0"

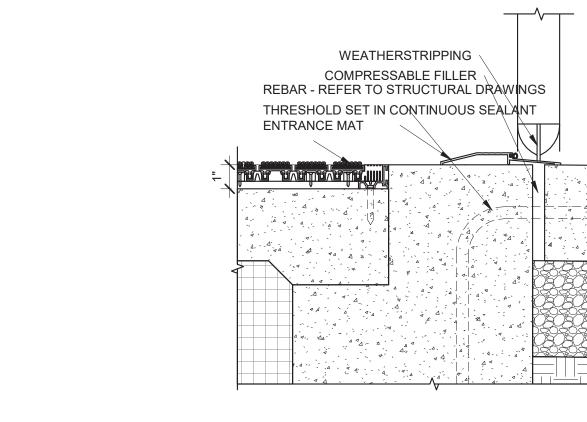

Detail Door Sill Exterior Metal Threshold Entry Mat
3" = 1'-0"

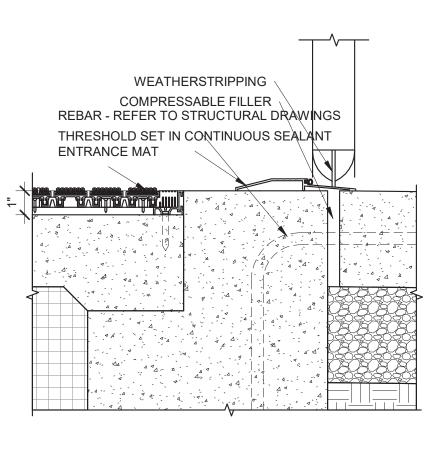



Issued For:

ARCHITECTS

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One Vernon Street Newburyport, MA 01950

Phone 978-462-5515

Fax: 978-462-5525

ſ	Sheet Title:
	Door Schedule
ı	
ľ	Sheet Number:





STRUCTURAL ENGINEER:
Shelley Engineering
MEP ENGINEER:
BLW Engineers
INTERIOR DESIGNER:

59 Low Street
Newburyport, MA 01950

Issued For:	Date:
MEETING	07/25/2023


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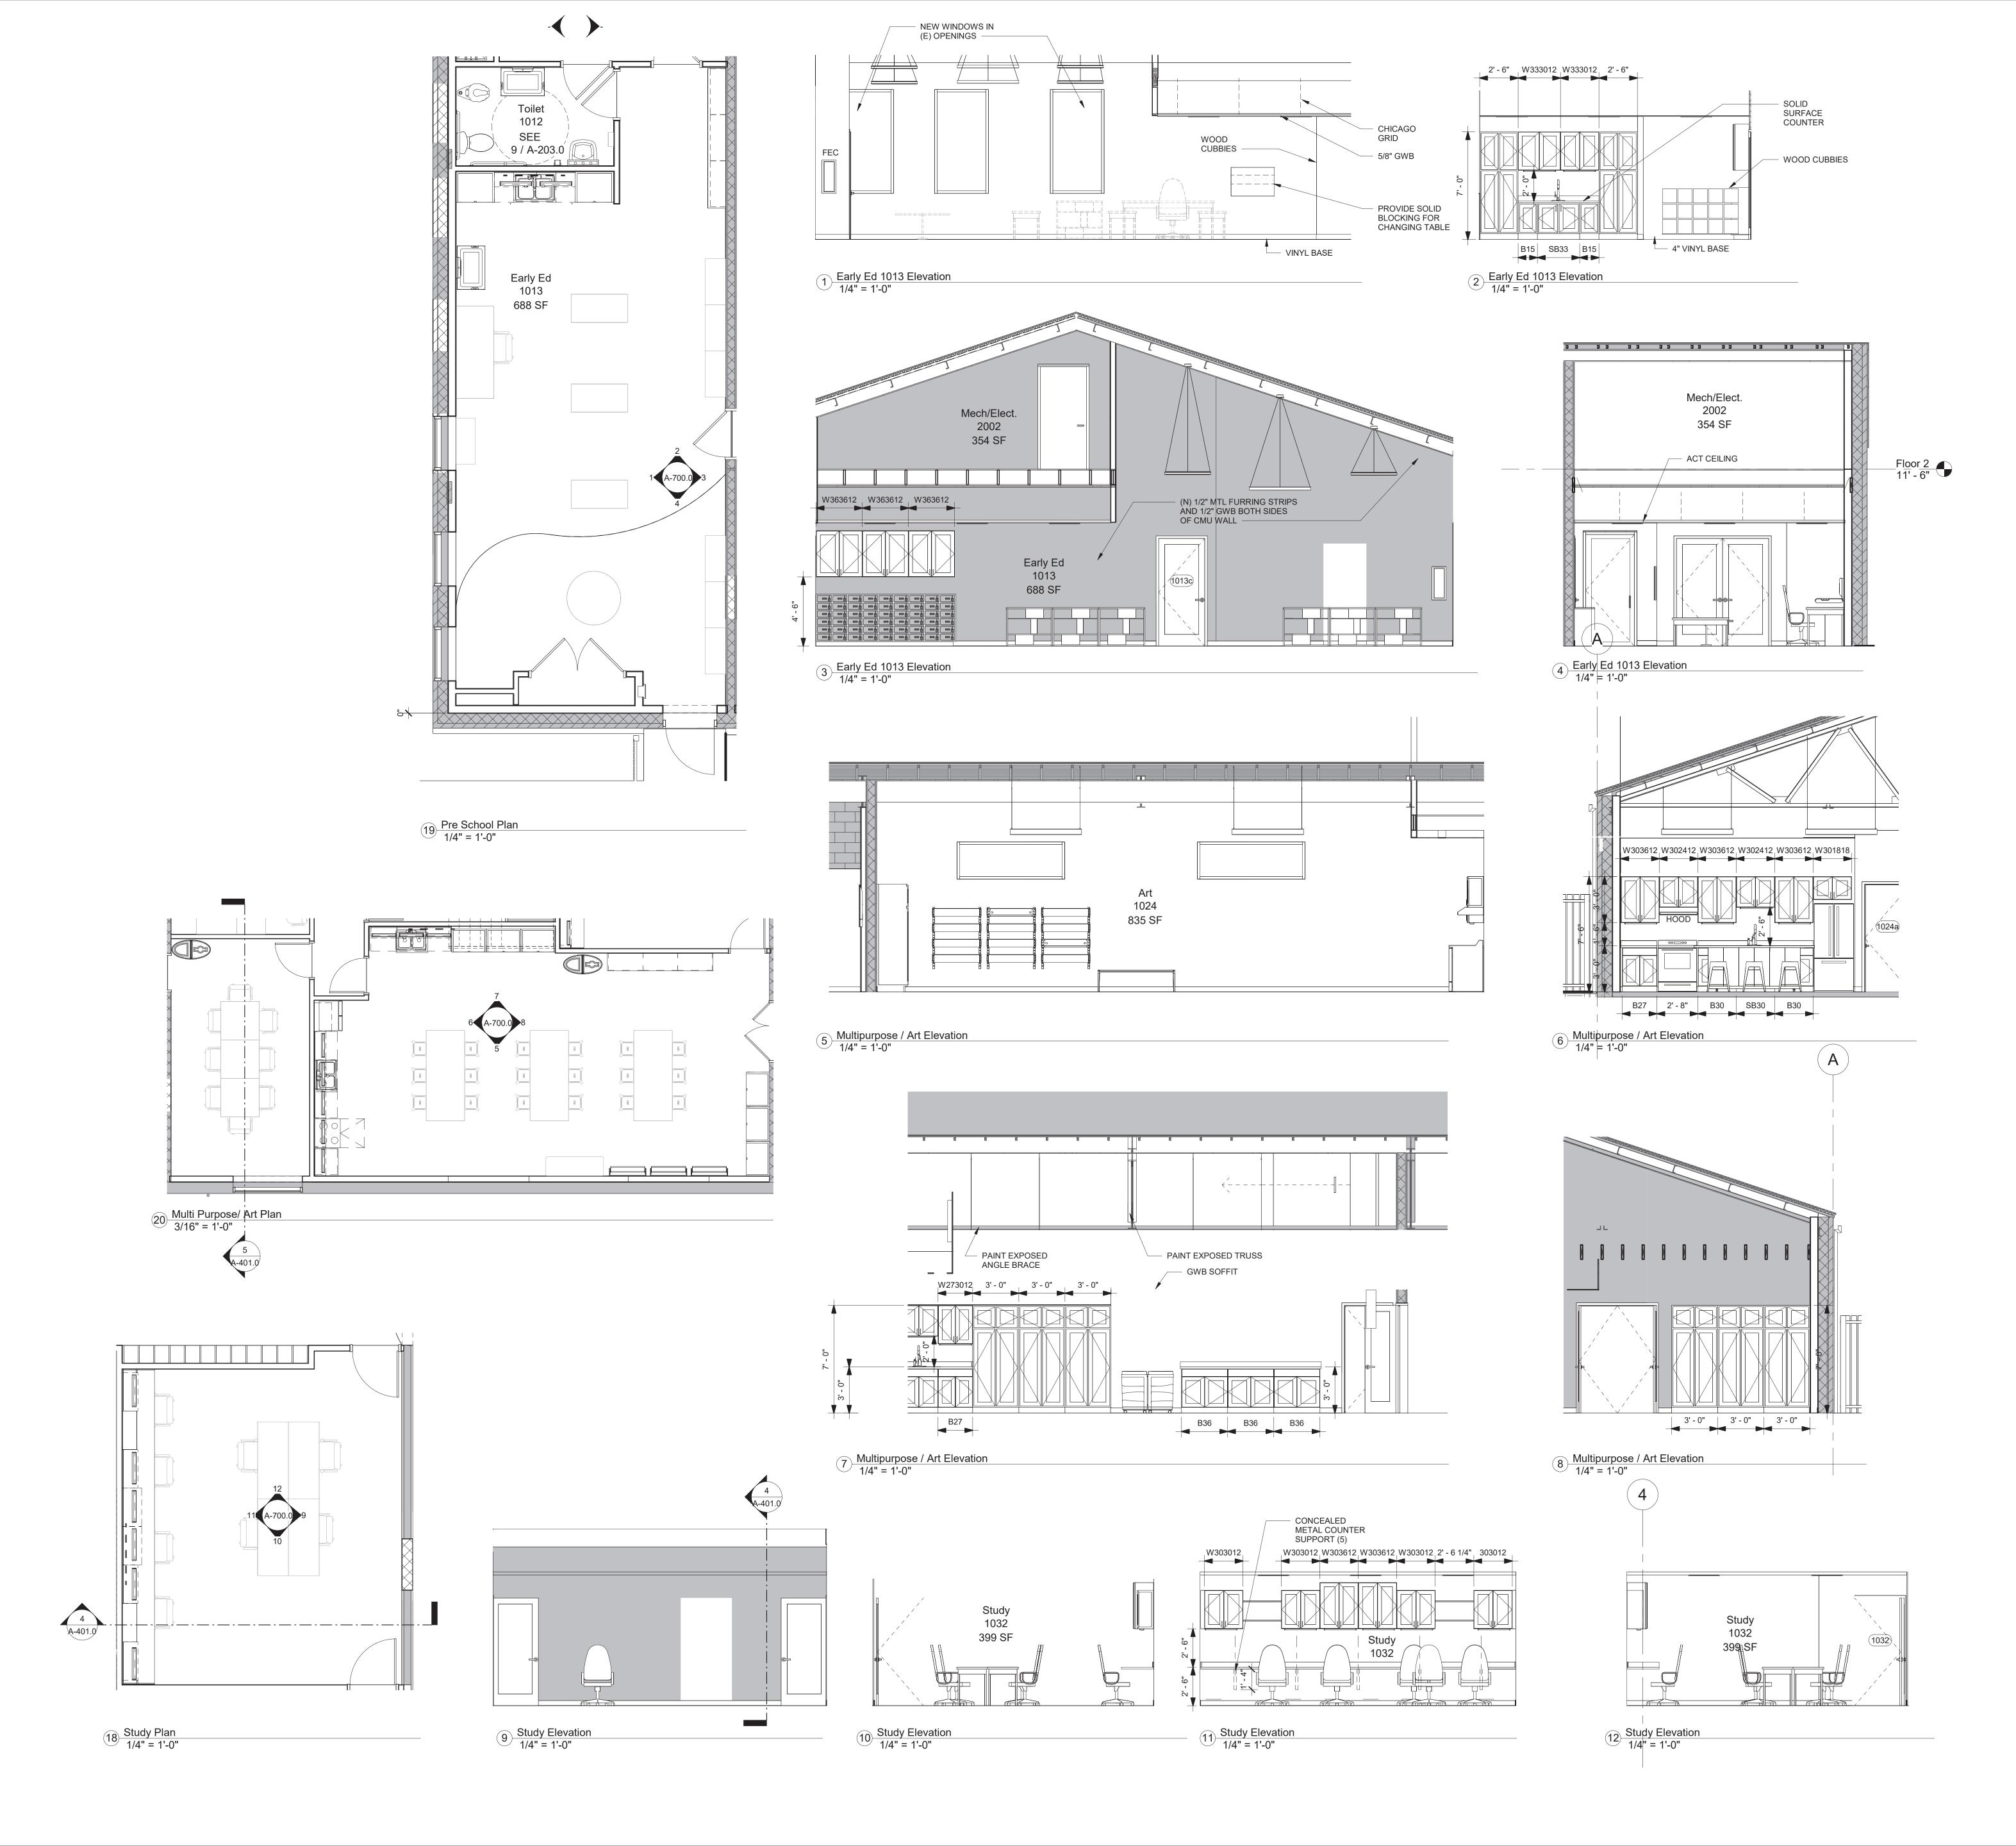
uilding Key:		

Sheet Title:

Door Hardware Diagram

Sheet Number: A-603.0



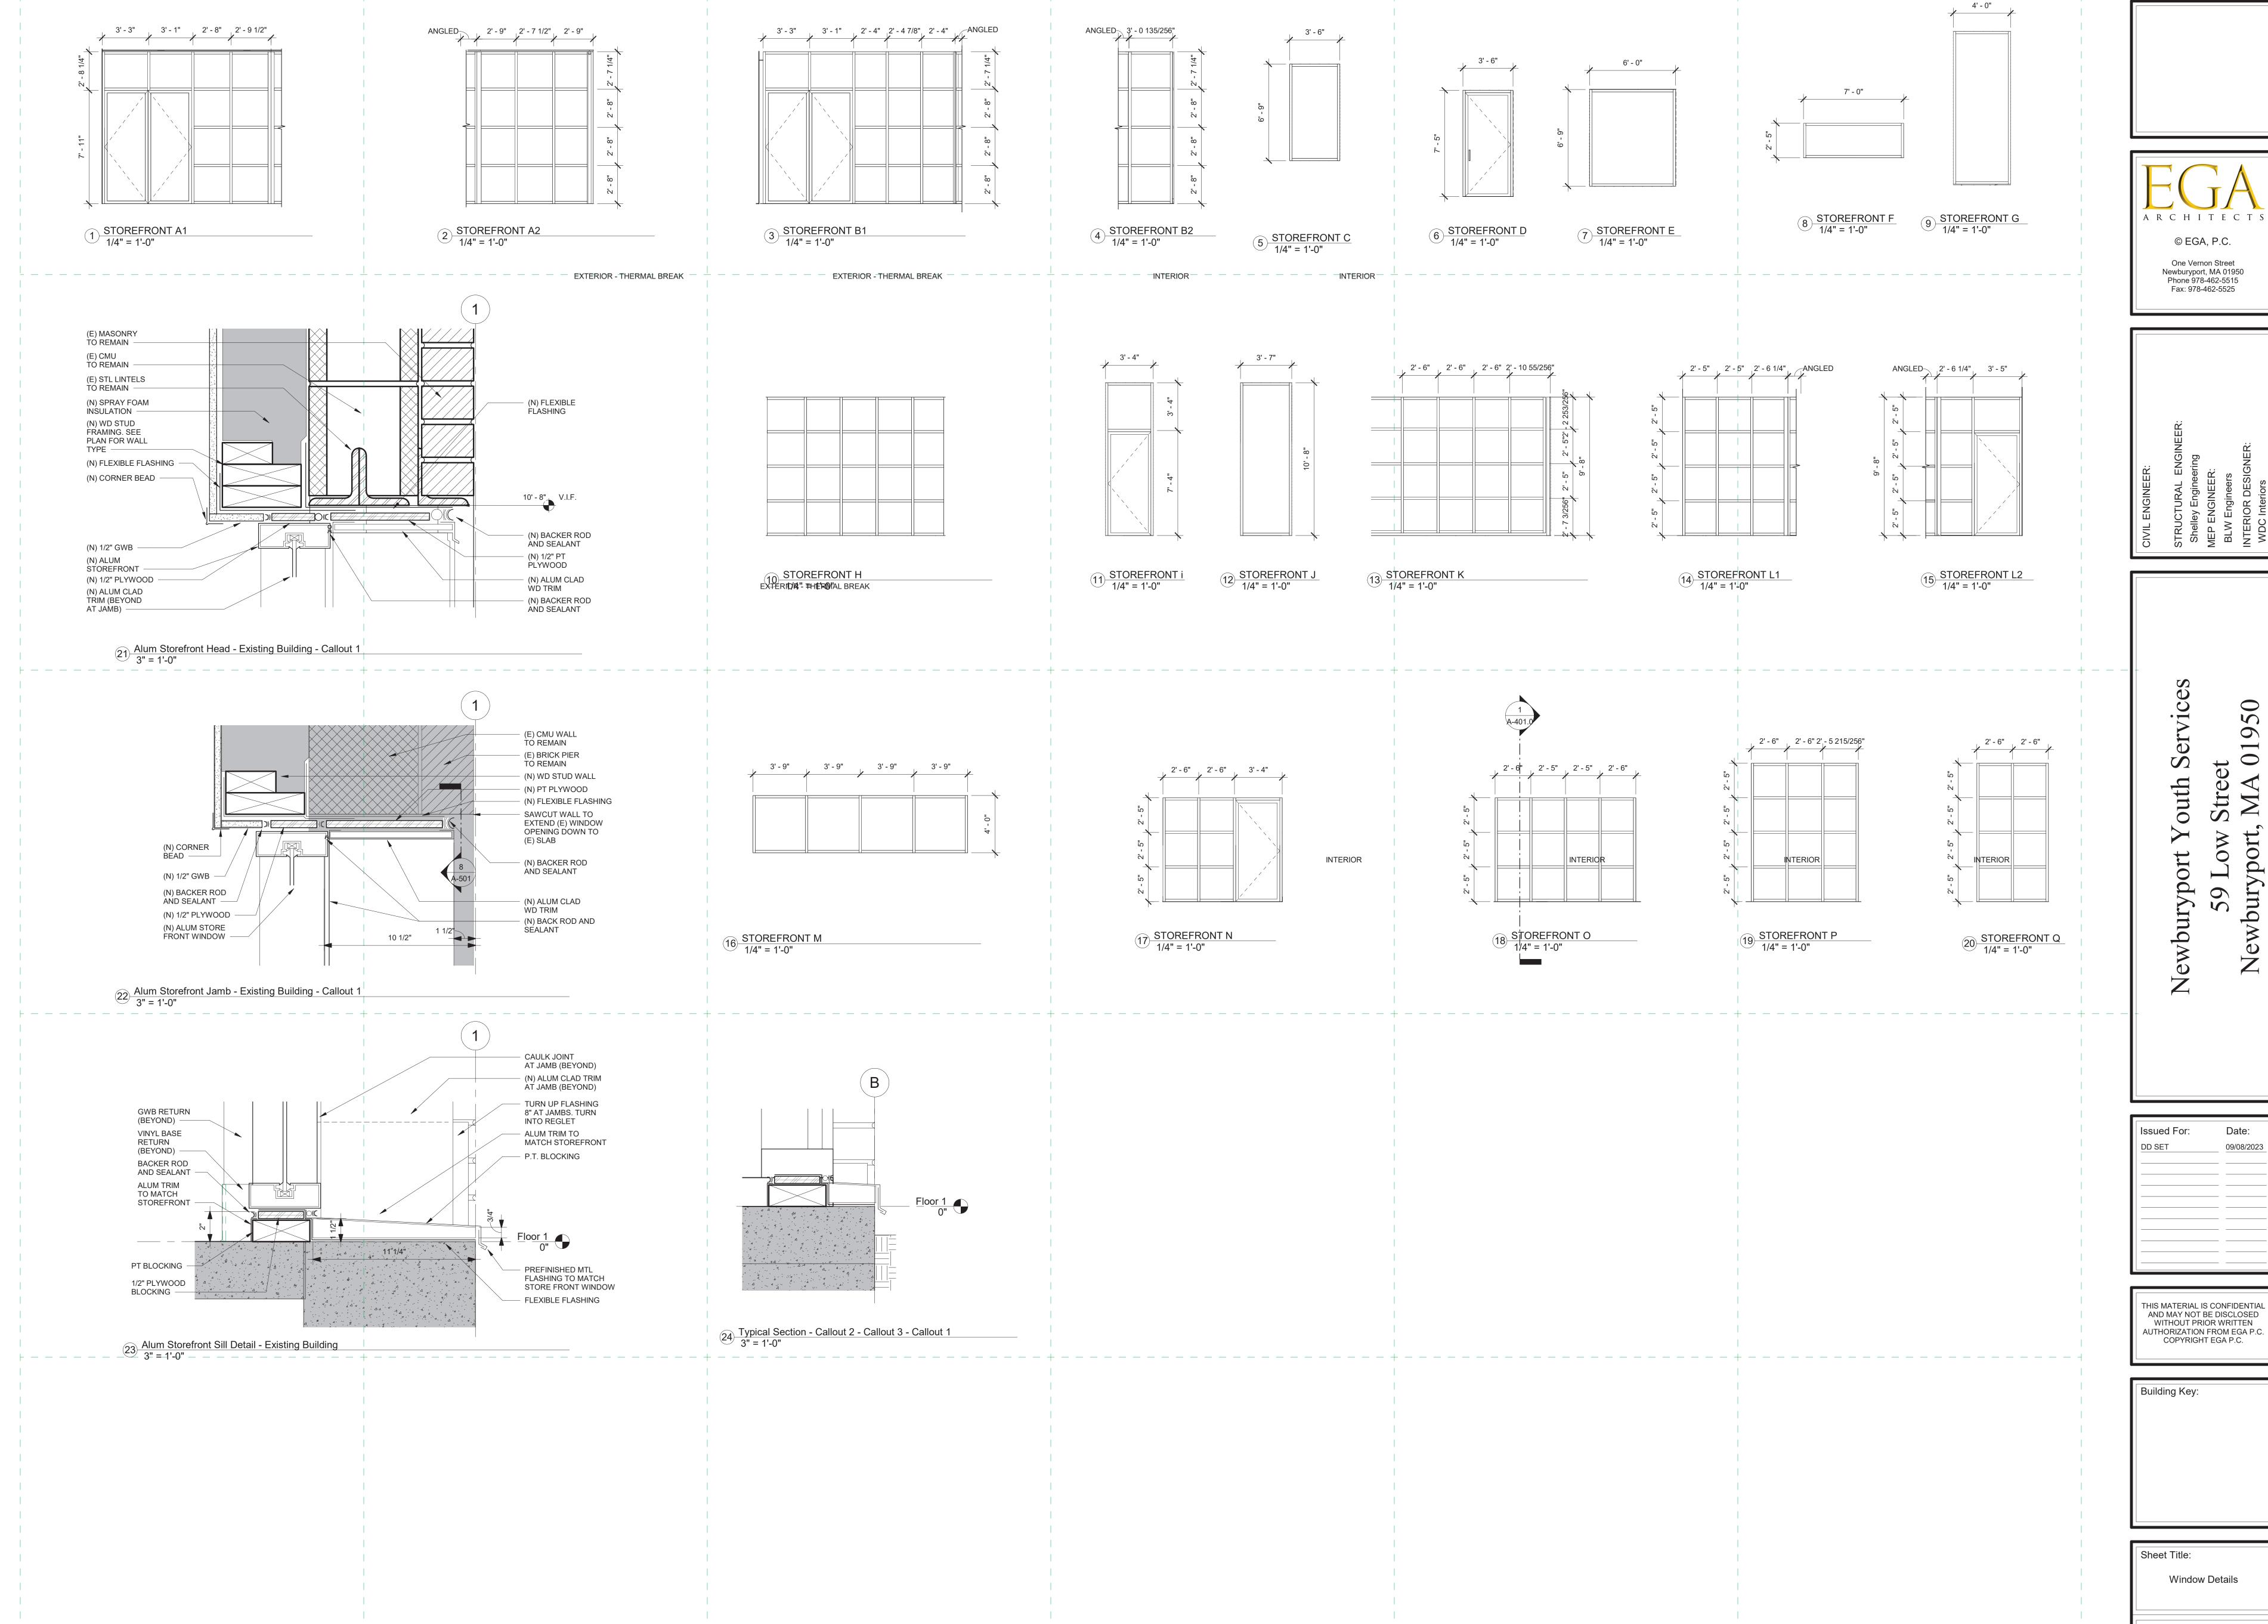



Street, MA 0 59 Low

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Building Key:

Sheet Title: Interior Elevations Sheet Number: A-700.0








STRUCTURAL ENGINEER:
MEP ENGINEER:
INTERIOR DESIGNER:
WELLESLEY DESIGN CONSULTANT

Jewburyport Youth Service
59 Low Street

Issued For: Date:

DESIGN DEV. SET 09/072023

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Sheet Title:
FURNITURE PLAN

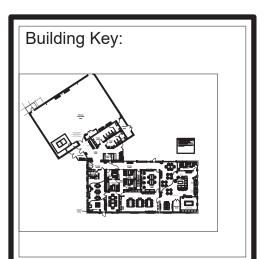Sheet Number:
ID.1



1 FLOOR FINISH ACCENT PLAN
1/8" = 1'-0"






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Building Key:

FLOOR FINISH PLAN Sheet Number: ID.2-1





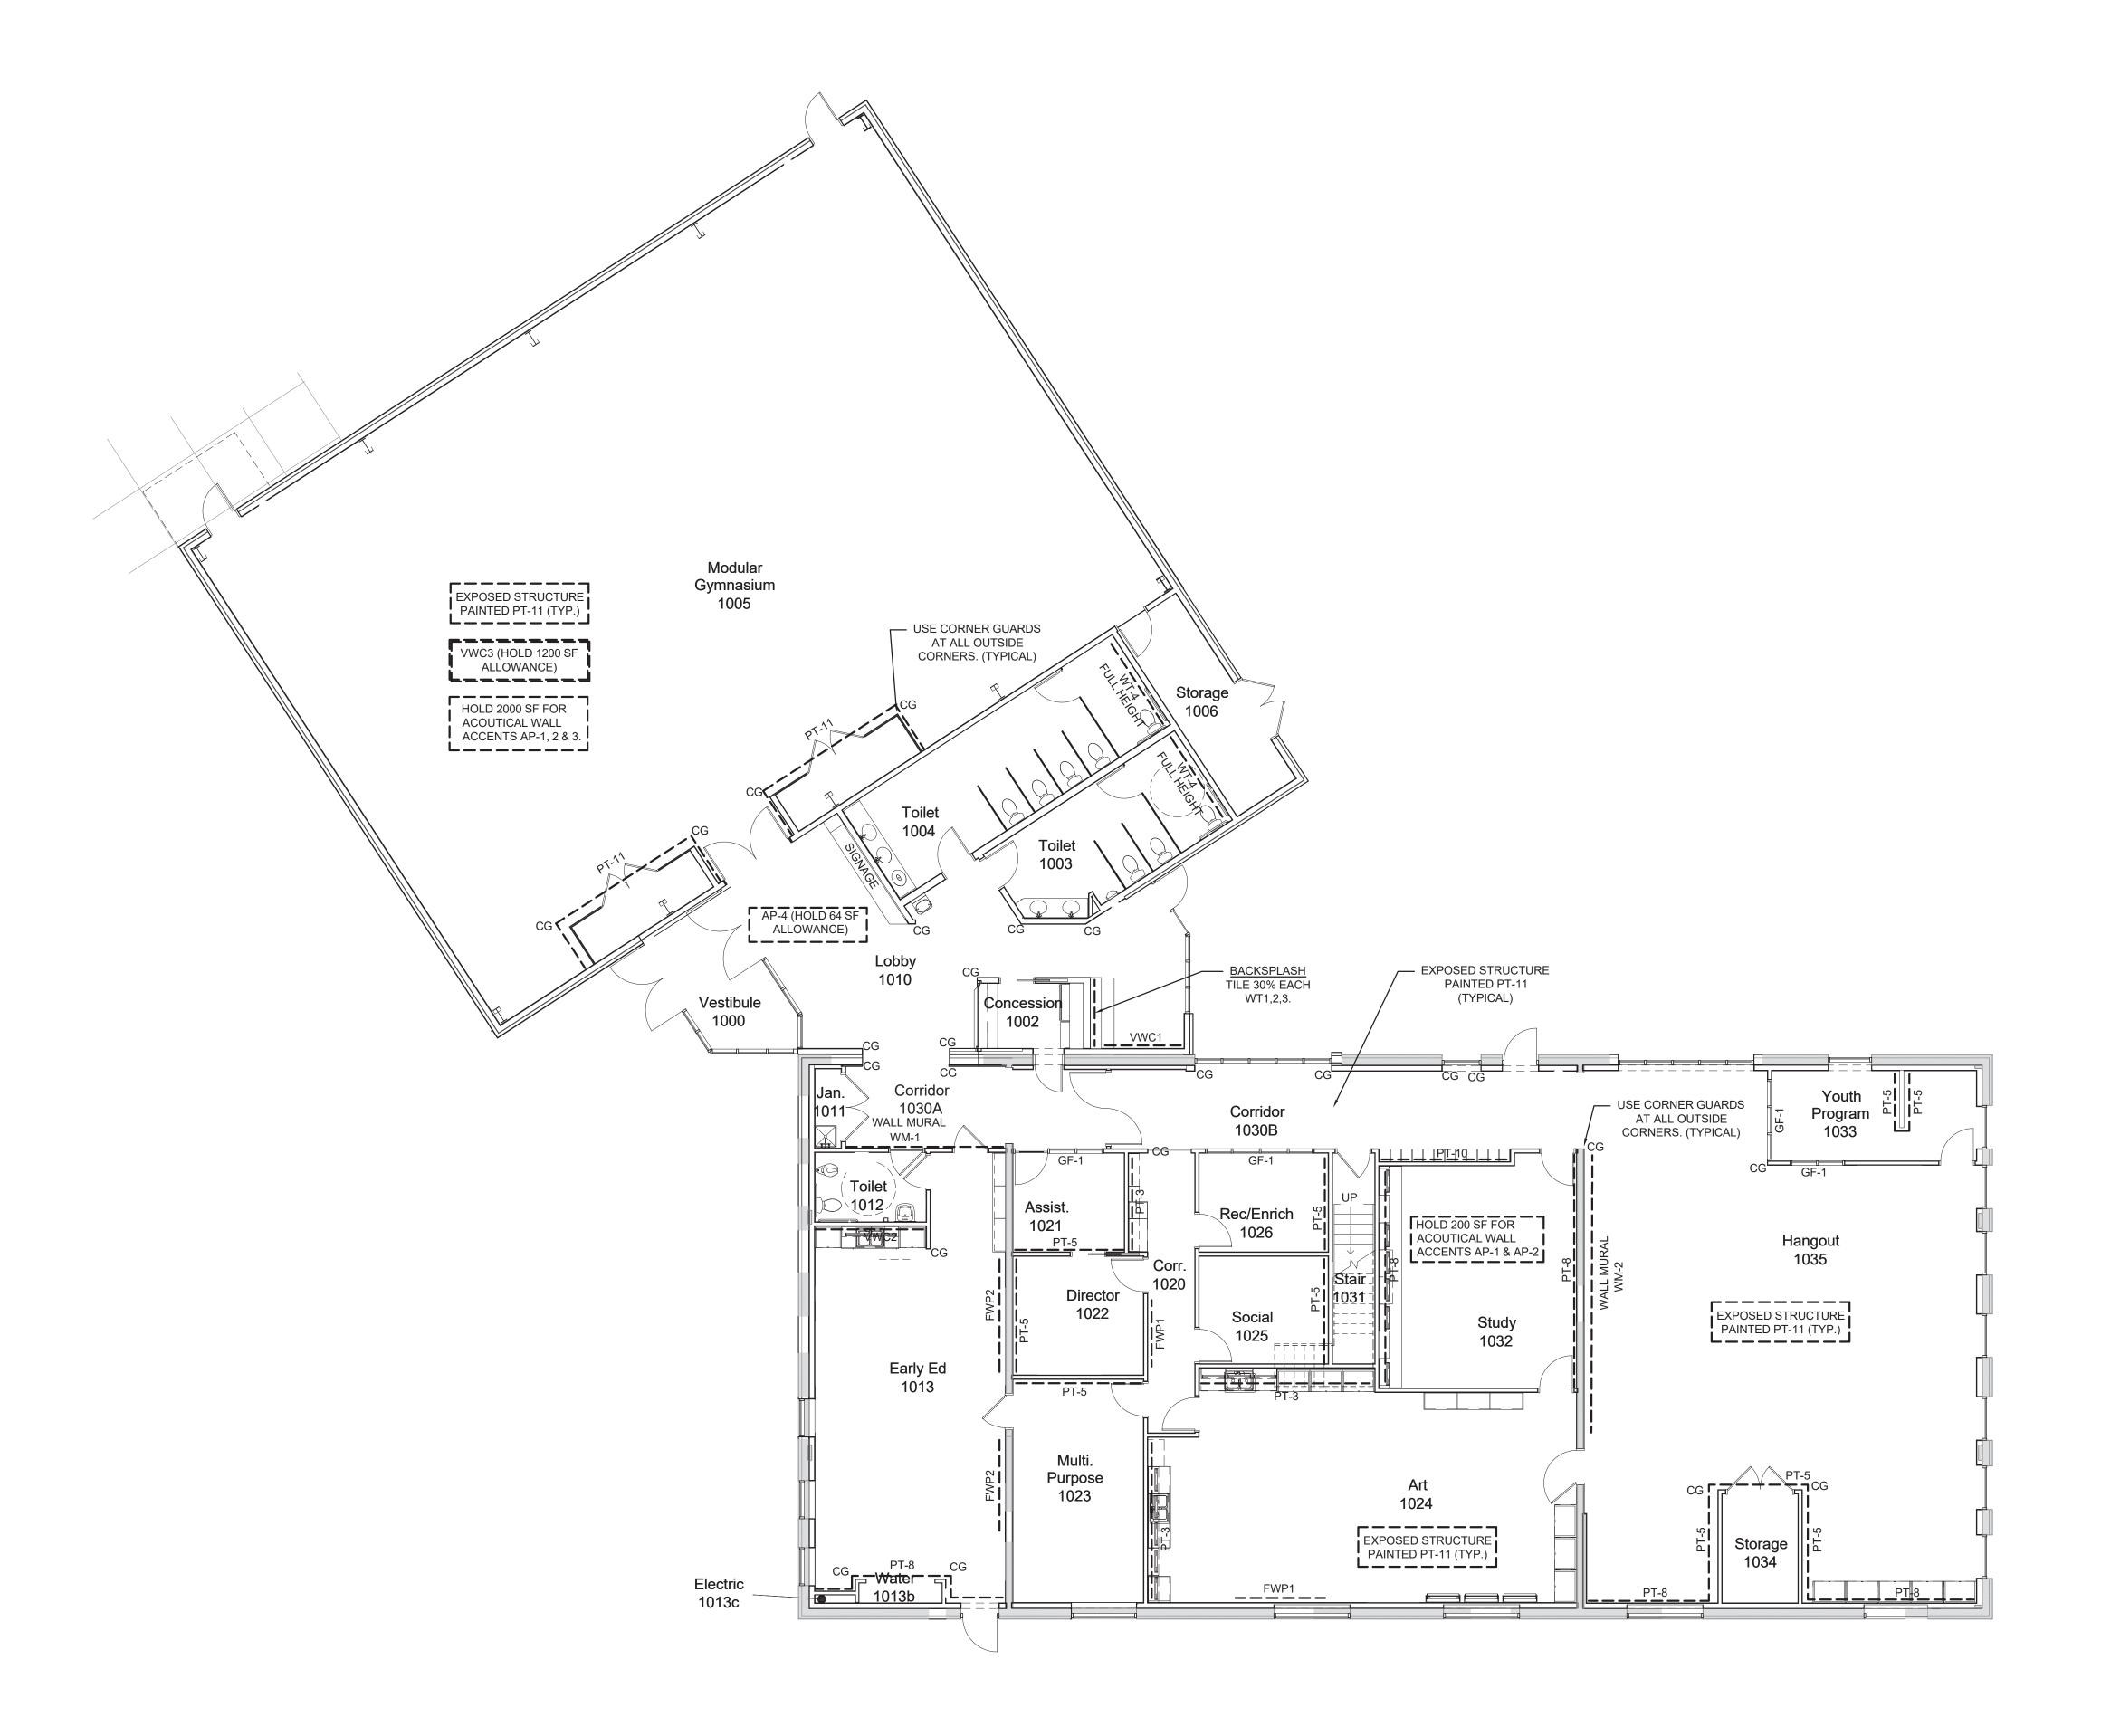



STRUCTURAL ENGINEER:

MEP ENGINEER:

INTERIOR DESIGNER:

WELLESLEY DESIGN CONSULTANTS

Newburyport Youth Services

59 Low Street

Newburyport, MA 01950

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Building Key:

Sheet Title:

WALL ACCENT
FINISH PLAN

Sheet Number:

ID.2-2

NBPT Youth Services: Newburyport, MA

Finish Schedule															
											Ceiling				
				Trim			D 4					0 00 /			
				Ln/Ch Rail, Door	Full He	Above	Below Chair					Soffit/ Coffer	Ceiling		
Rm#	Room Name	Flooring	Base		Wall	Chair Rai		Cabinet	Counter	Accent	Beams	Wall	Inside	Trim	Remarks
FIRST FLOOI		8													
1000	VESTIBULE	EM1	VCB1		PT7										
1002		CT1	CT1		PT7										
1003	TOILET	CT1	CT1	PT1	PT7		WT5	PL2	SS2	WT4					WT4 ACCENT WALL SEE FINISH PLANS, WT5 TO 6'-6"
1004	TOILET	CT1	CT1	PT1	PT7		WT5	PL2	SS2	WT4					WT4 ACCENT WALL SEE FINISH PLANS, WT5 TO 6'-6"
										PT10,PT11 VWC3					
1005	GYM	SF1	VCB1	PT1	PT5	VWC3				AP1,2,3	PT11				PT10 - HOLD 30% PAINT ACCENT, SEE PLANS FOR MORE INFO.
1006	STORAGE	QCT1	VCB1	PT1	PT7										
1010	LOBBY	EM1	CT1		PT5	VWC1	WP2	PL1	SS2	AP4					
1011	JANITOR'S CLOSET	QCT1	VCB1	PT1	PT5										
1012	TOILET	CT1	CT1	PT1		VWC2	WT5	PL2	SS2						WT5 TO 4'-6" +/- HIGH, USE WHOLE TILE, VWC2 ABOVE
1013	EARLY ED	LVT2,3,4, CPT4	VCB1		PT8	VWC2	WP4	PL4	SS1	DS2/FWP2					
1013b	WATER	QCT1	VCB1	PT1	PT5										
1020	CORRIDOR	RT1	VCB1	PT1	PT5, 3					FWP1, PT3					PT3 ACCENT SEE FINISH PLANS
1020	ASSIST. DIRECTOR	1	VCB1		PT7,5					GF1, PT5					PT5 ACCENT SEE FINISH PLANS
1021		CPT2	VCB1		PT7,5					PT5					PT5 ACCENT SEE FINISH PLANS
1023		CPT2	VCB1	PT1	PT7,5					WM-2					PT5 & PT8 ACCENT SEE FINISH PLANS, WM-2 FEATURE WALL
1024		LVT1	VCB1	PT1	PT2	PT2	WP1	PL3	SS1	DS1, FWP1	PT11				CONTINUOUS WP1 AS SHOWN
1025	SOCIAL	CPT2	VCB1		PT7,5	1 12	771	1 20	001	PT5					PT5 ACCENT SEE FINISH PLANS
1026		CPT2	VCB1		PT7,5					GF1, PT5					PT5 ACCENT SEE FINISH PLANS
1030A		EM1	VCB1	PT1	PT7					WM-1					WM-1, SEE PLANS FOR WALL MURAL LOCATION
1030B		RT1,2,3,4	VCB1	PT1	PT5,10					PT10	PT11				PT10 ACCENT SEE FINISH PLANS
1031	STAIRS	RST1	VCB1	PT1	PT5										
1032	STUDY	CPT2	VCB1	PT1	PT7,8					AP1,2,3					PT8 ACCENT SEE FINISH PLANS, HOLD 64
1033		CPT2	VCB1	PT1	PT7,5					GF1, PT5					PT5 ACCENT SEE FINISH PLANS
1034	STORAGE	QCT1	VCB1	PT1	PT5					,					
1035		CPT3	VCB1	PT1	PT7,5,8			PL1			PT11				PT5, 8 ACCENT SEE FINISH PLANS

NBPT Youth Services: Newburyport, MA

Finish Legend/Samples

General Notes: Install per Specifications as listed in Architect's Project Manual. Interior Design Legend, Schedule, & Plans are to be used in conjunction with one another, as well as, Architect's Interior Elevations and Floor Plans. Practices shall follow the most current Manufacturer's recommended installation methods. Manufacturer product cut sheets are included for reference. Inconsistencies shall be brought to the attention of the Architect, and therefore the Interior Designer, before proceeding. Prior to installation, Subcontractors shall do a walk through of space. Samples of all Interior materials to be submitted to WDC for approval prior to proceeding; Secondary color replications of finishes are not acceptable. All maintenence & cleaning instructions; refer to manufacturer's guidelines and recommendations.

Flooring: Flooring direction shall be verified with Interior Designer before installation. Ceramic tile pattern to be centered in room, minimizing narrow pieces that are subject to fracture. Include grout sealer for traffic areas and surfaces prone to staining, including lobbies, showers, restrooms and backsplashes. Plank type flooring shall be cut for random pattern, with minimum length to be no less than 4" at exterior border of field. All Flooring transitions shall be smooth, finished, and comply with ADA requirements. Transitions shall occur at center of opening depth, unless otherwise noted. Schluter transition strips are to be used, U.O.N (Unless Otherwise Noted).

Base: Standard Vinyl or Rubber Base: Straight Base with Carpet; Cove Base with hard surface floor.

Porcelain Base: Provide coordinating base w/ Porcelain Floor tile, U.O.N.

Walls: Vinyl Wallcovering and Paint color terminations/transitions shall occur at interiors corners. In finished rooms, match mechanical grills, wall diffusers, and access panels to adjacent surfaces.

Paint: Regardless of color or specified quantity of coats, subcontractor is responsible for full color coverage. Sub-contractor shall verify paint formulation is appropriate for substrate. Paint all exposed structural elements, ductwork, conduit, and equipment in rooms without gypsum or ACT ceiling, but scheduled for painted ceiling. Paint draw down submittals are required for approval prior to commencing work.

Ceiling: Flat

Gypsum Walls: Eggshell

Trim, Doors & Frames: Semi-gloss

CMU walls: Semi-gloss

Price add alternate for wall paints in same color using Scuffmaster

Ceiling: Refer to Architects RCP for ceiling material & finishes, U.O.N. Painted ceilings, soffits, and fascias to be PT-0 U.O.N.

*Refer to wall & floor accent finish plans & room finish schedule

NBPT Youth Services: Newburyport, MA

Finish Legend/Samples

Finishes

Entry Mat

EM-1

Manufacturer J+J Flooring Group

Collection

Style Alter Ego Modular (Style 7070)

Color 1837 Operative

Backing Nexus Modular

Size 24" x 24"


Installation Ashlar

Remarks Entry

Mfr Rep Michael Washburn

michael.washburn@jjflooringgroup.com

(617) 833-2836

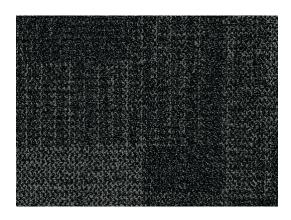

Carpet

CPT-2

Manufacturer Gatewaysurfaces

Collection Studio 44

Style Funk

Color Slide

Backing Vinyl


Size 9.49" x 39.37" Plank

Installation Ashlar

Mfr Rep Kyle Gable

kyle@salesmaster.com

(413) 887-8495

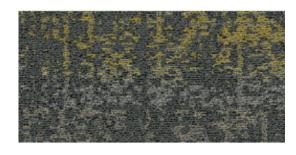

CPT-3

Manufacturer Gatewaysurfaces by Mohawk

Collection Studio 44

Style Soul

Color Still Water

Backing Vinyl

Size 19.69" x 19.69" Carpet Tile

Installation Ashlar

Mfr Rep Kyle Gable

kyle@salesmaster.com

(413) 887-8495



NBPT Youth Services: Newburyport, MA

Finish Legend/Samples

CPT-4

Manufacturer Interface

Collection Simple Abstraction

Style Video Specturm 125610AK00

Color 106014 Urban

Backing GlasBac Tile

Size 25cm x 1m

Installation 1/3 Stagger

Remarks Kids Corner

Mfr Rep Katie Garcia

katie.garcia@interface.com

(603) 401-8100



Luxury Vinyl Tile

LVT-1

Manufacturer Cobalt Surfaces

Collection Katanga

Style KP5.801

Color Myrtle

Olor

Size 7" x 48"

Installation Loose Lay 5mm/20mil

Remarks Art Room

Mfr Rep Kyle Gable

kyle@salesmaster.com

(413) 887-8495



LVT-2

Manufacturer Patcraft

Collection Monochrome & Surface Tone

Style I464V Surface Tone

Color 00300 Tropic (Green)

Size 9" x 36"

Installation Per diagram

Remarks Kids Room

Mfr Rep Heather Rowan

heather.rowan@patcraft.com

(802) 503-7917



NBPT Youth Services: Newburyport, MA

Finish Legend/Samples

LVT-3

Manufacturer Patcraft

Collection Monochrome & Surface Tone

Style I464V Surface Tone

Color 00400 Pool (Aqua)

Size 9" x 36"

Installation Per diagram

Remarks Kids room

Mfr Rep Heather Rowan

heather.rowan@patcraft.com

(802) 503-7917



LVT-4

Manufacturer Patcraft

Collection Monochrome & Surface Tone

Style I464V Surface Tone

Color 00450 Ocean (Blue)

Size 9" x 36"

Installation Per diagram

Remarks Kids room

Mfr Rep Heather Rowan

heather.rowan@patcraft.com

(802) 503-7917



Sports Floor

SF-1

Manufacturer Centaur Flooring Systems

Collection Triple Threat

Style Sports Floor

Color CS203 Honey

Size 7mm x 72"

Installation Seamless with heat weld

Remarks Gym Flooring

Mfr Rep Gerry Grenon

ggrenon@michaelhalebian.com

(603) 580-3216





NBPT Youth Services: Newburyport, MA

Finish Legend/Samples

Ceramic Tile

CT-1

Manufacturer Florida Tile

Collection Aura

Style Porecelain, Rectified

Color Light Gray

Size 12"x 24"

Installation 1/3 Stagger

Remarks Restroom Floor Tile & One Row Up Wall

Mfr Rep Tony Almeida

talmeida@genrose.com

(781)710-6581



Manufacturer Genrose Tile

Collection Shadow

Style Glossy

Color White

Size 2.5" x 5"

Installation Pattern to follow

Remarks Lobby accent wall tile

Mfr Rep Tony Almeida

talmeida@genrose.com

(781)710-6581

WT-2

Manufacturer Genrose Tile

Collection Shadow

Style Glossy

Color Warm

Size 2.5" x 5"

Installation Elevation or Detail

Remarks Lobby accent wall tile

Mfr Rep Tony Almeida

talmeida@genrose.com

(781)710-6581



NBPT Youth Services: Newburyport, MA

Finish Legend/Samples

WT-3

Manufacturer Genrose Tile

Collection Shadow

Style Glossy

Color Copper

Size 2.5" x 5"

Installation Elevation or Detail

Remarks Lobby accent wall tile

Mfr Rep Tony Almeida

talmeida@genrose.com

(781)710-6581



WT-4

Manufacturer Daltile

Collection Trellis Oak

Style Chevron accent

Color Brown Blend TR24

Size 4" x 21"

Installation Chevron

Remarks Restroom wall tile, Feature

Mfr Rep Joan Collins

joan.collins@daltile.com

(603) 552-2056



WT-5

Manufacturer Trinity Tile

Collection Harmony Canvas

Style Matte

Color White

Size 4" x 16"

Installation Straight horizontal stack

Remarks Restroom wall tile, TYP. to 6'-6"

Mfr Rep Gregg Doble

greggdoble@greggdoble.com

(617) 398-6784

NBPT Youth Services: Newburyport, MA

Finish Legend/Samples

Quartz Composition Tile

QCT-1

Manufacturer Procedo Flooring

Collection Versa Quartz US

Style

Color Norfolk- QNOR

Size 24 x 24


Installation Quarter Turn

Remarks Janitor and Storage Rooms

Mfr Rep Kyle Gable

kyle@salesmaster.com

(413) 887-8495

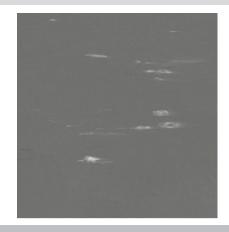

Rubber Tile & Stair Treads/Base

RT-1

Manufacturer Roppe

Collection ReNew

Style Rubber with Cork Smooth

Color R174 Smoke

Size 20 x 20

Installation Corridor

Mfr Rep Kyle Gable

kyle@salesmaster.com

(413) 887-8495



RT-2

Manufacturer Roppe

Collection ReNew

Style Rubber with Cork Smooth

Color R123 Charcoal


Size 20 x 20

Installation Corridor

Mfr Rep Kyle Gable

kyle@salesmaster.com

(413) 887-8495

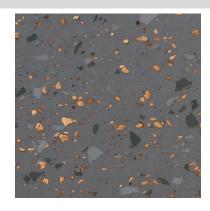

NBPT Youth Services: Newburyport, MA

Finish Legend/Samples

RT-3

Manufacturer Roppe

Collection ReNew

Style Rubber with Cork Smooth

Color R638 Cadet


Size 20 x 20

Installation Corridor

Mfr Rep Kyle Gable

kyle@salesmaster.com

(413) 887-8495

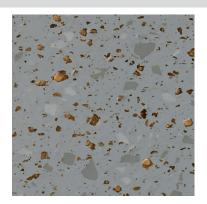

RT-4

Manufacturer Roppe

Collection ReNew

Style Rubber with Cork Smooth

Color R191 Camel

Size 20 x 20

Installation Corridor

Mfr Rep Kyle Gable

kyle@salesmaster.com

(413) 887-8495



RST-1

Manufacturer Roppe

Collection Value Tread

Style #17 Tread

Color 178 Pewter

Size Varify in field

Installation Stairs

Mfr Rep Kyle Gable

kyle@salesmaster.com Mobile (413) 887-8495



NBPT Youth Services: Newburyport, MA

Finish Legend/Samples

Vinyl Cove Base

VCB-1

Manufacturer Roppe

Collection Ready Base

Style Vinyl

Color 132 Granite

Size 4" Cove Base, 1/8" gauge

Installation Continuous roll

Remarks Wall Base

Mfr Rep Kyle Gable

kyle@salesmaster.com

(413) 887-8495



CG-1

Manufacturer Inpro

Collection Tape-On Corner Guard

Style Outside Corner

Color Bright Silver

Size 1 1/2"

Installation 48" High

Remarks Apply Above Base

Mfr Rep Ellen O'Brien

eobrien@inprocorp.com

(978) 873-3096



Paint

PT-0

Manufacturer Benjamin Moore

Number OC-129

Color Alabaster

Remarks Ceiling

Mfr Rep Marion Beaulieu

marion.beaulieu@benjaminmoore.com

(508) 954-0630

NBPT Youth Services: Newburyport, MA

Finish Legend/Samples

PT-1

Manufacturer Benjamin Moore

Number 2121-10

Color Gray

Remarks Trim - UON

Mfr Rep Marion Beaulieu

marion.beaulieu@benjaminmoore.com

(508) 954-0630

PT-2

Manufacturer Benjamin Moore

Number OC-68

Color Distant Gray

Remarks Neutral Wall - Art Room

Mfr Rep Marion Beaulieu

marion.beaulieu@benjaminmoore.com

(508) 954-0630

PT-3

Manufacturer Benjamin Moore

Number 425

Color Lime Twist

Remarks Accent Paint

Mfr Rep Marion Beaulieu

marion.beaulieu@benjaminmoore.com

(508) 954-0630

PT-4

Manufacturer Not Used

Number

Color

Remarks

Mfr Rep

NBPT Youth Services: Newburyport, MA

Finish Legend/Samples

PT-5

Manufacturer Benjamin Moore

Number 1472

Color Silver Chain

Remarks Accent Paint

Mfr Rep Marion Beaulieu

marion.beaulieu@benjaminmoore.com

(508) 954-0630

PT-7

Manufacturer Benjamin Moore

Number 2108-70

Color Lacey Pearl

Remarks TYP. Wall Color

Mfr Rep Marion Beaulieu

marion.beaulieu@benjaminmoore.com

(508) 954-0630

PT-8

Manufacturer Benjamin Moore

Number HC-150

Color Yarmouth Blue

Remarks Accent - Study

Mfr Rep Marion Beaulieu

marion.beaulieu@benjaminmoore.com

(508) 954-0630

PT-9

Manufacturer Not Used

Number

Color

Remarks

Mfr Rep



NBPT Youth Services: Newburyport, MA

Finish Legend/Samples

PT-10

Manufacturer Benjamin Moore

Number 188

Color Eye of the Tiger

Remarks Accent - Gym

Mfr Rep Marion Beaulieu

marion.beaulieu@benjaminmoore.com

(508) 954-0630

PT-11

Manufacturer Benjamin Moore

Number 2121-10

Color Gray

Remarks Accent - Gym (Frames & Structure Above

Mfr Rep Marion Beaulieu

marion.beaulieu@benjaminmoore.com

(508) 954-0630

Wall Protection

WP-1

Manufacturer Wolf Gordon Rampart

Collection Venn Texture

Style GOH32181090

Color Laurel

Size 52" Sheet

Installation Railroad on walls w/ corresponding trims

Remarks Art Room

Mfr Rep Cindy Cedrone

cindy.cedrone@wolfgordon.com



NBPT Youth Services: Newburyport, MA

Finish Legend/Samples

WP-2

Manufacturer Wolf Gordon Rampart

Collection Venn Texture

Style GOH321181084

Color Beige

Size 52" Sheet

Installation Railroad on walls w/ corresponding trims

Remarks Lobby

Mfr Rep Cindy Cedrone

cindy.cedrone@wolfgordon.com

(781) 320-2972



WP-4

Manufacturer Wolf Gordon Rampart

Collection Venn Texture

Style GOH32181089

Color Iron

Size 52" Sheet

Installation Railroad on walls w/ corresponding trims

Remarks Early Ed

Mfr Rep Cindy Cedrone

cindy.cedrone@wolfgordon.com

(781) 320-2972



Vinyl Wall Covering/Vinyl Murals

VWC-1

Manufacturer Wolf Gordon

Collection Holborn

Style GOH33367275

Color Slate


Size 52" wide Repeat

Installation

Remarks Lobby Sitting Area

Mfr Rep Cindy Cedrone

cindy.cedrone@wolfgordon.com

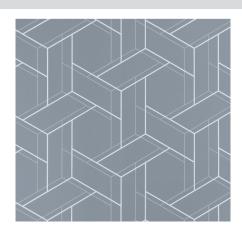

NBPT Youth Services: Newburyport, MA

Finish Legend/Samples

VWC-2

Manufacturer Wolf Gordon Collection Virtual Climb

Style GOH 32173816

Color Ballpoint

Size 52" wide repeat


Installation

Remarks Early Ed & Bathroom

Mfr Rep Cindy Cedrone

cindy.cedrone@wolfgordon.com

(781) 320-2972

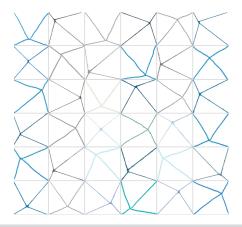

VWC-3

Manufacturer Wolf Gordon

Collection Ridgeline

Style GOH 33367268

Color Aegean

Size 52" wide repeat

Installation Allow for 1000 SF Accent Areas

Remarks Gym/ Accent
Mfr Rep Cindy Cedrone

cindy.cedrone@wolfgordon.com

(781) 320-2972



WM-1

Manufacturer Wplf Gordon Digital Walls or Equal

Collection Type II Vinyl Wallcovering

Style TBD

Color

Size 15' Wide Approx

Installation

Remarks Corridor A at Early Ed

Mfr Rep Cindy Cedrone

cindy.cedrone@wolfgordon.com



NBPT Youth Services: Newburyport, MA

Finish Legend/Samples

WM-2

Manufacturer Wolf Gordon Digital Walls or Equal

Collection Type II Vinyl Wallcovering

Style TBD

Color TBD

Size 25' Wide Approx.

Installation

Remarks Hangout

Mfr Rep Cindy Cedrone

cindy.cedrone@wolfgordon.com

(781) 320-2972



Decorative Surface

DS-1

Manufacturer 3form

Style Fairy Tale

Color Sandstone

Remarks Art Room Side Light

Mfr Rep Zoe Kustritz

zoe.kustritz@3-form.com

(651) 338-0506



DS-2

Manufacturer 3form

Style Portal + Highres White Oak


Color Sandstone

Remarks Early Ed (In FF&E Screens)

Mfr Rep Zoe Kustritz

zoe.kustritz@3-form.com

(651) 338-0506

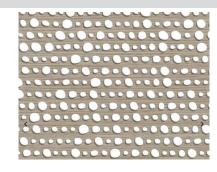

NBPT Youth Services: Newburyport, MA

Finish Legend/Samples

Fabric Wrapped Panel

FWP-1

Manufacturer Carnegie

Collection Xorel Havana

Style Panels

Color 5

Size 56" Wide


Installation

Remarks 48" x 96" Panel Tackboard Corr. @ Art

Mfr Rep Megan Parsons

mparsons@carnegiefabrics.com

(617) 538-6956

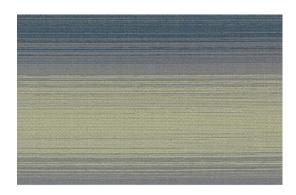

FWP-2

Manufacturer Wolf Gordon

Collection Mirror Image

Style GOH 33432629

Color Mist

Size 56" Wide

Installation Create 48" x 96: Tack Panel

Remarks Hangout

Mfr Rep Cindy Cedrone

cindy.cedrone@wolfgordon.com

(781) 320-2972



Glass Film

GF-1

Manufacturer Sonny's Glass Tinting

Collection TBD

Style Translucent Graphic Design

Color TBD

Size All Storefront Glazing at Offices

Installation Install on inside room

Remarks Offices/ Storefront

Mfr Rep Norm Bonenfant

normb@sonnysglasstinting.com

(781) 233-3647



NBPT Youth Services: Newburyport, MA

Finish Legend/Samples

Acoustic Panel

AP-1

Manufacturer Wolf Gordon (Or Approved Equal by All-

Bright Vendor)

Collection Gather Acoustical

Style **GATH 707**

Color Bluestone


Size 24 x24


Installation Random

Remarks Gym & Study

Mfr Rep Cindy Cedrone



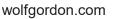

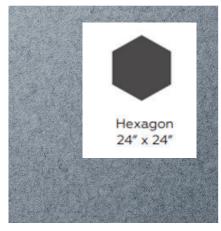

AP-2

Manufacturer

Hexagon 24" x 24"

Approved Equal by All-



Style GATH 703

Color Thunder

Size 24 x 24

Installation Random

Remarks Gym & Study

Mfr Rep Cindy Cedrone

cindy.cedrone@wolfgordon.com

(781) 320-2972



AP-3

Manufacturer Wolf Gordon (Or Approved Equal by All-

Bright Vendor)

Collection Gather Acoustical

Style GATH 700

Color Sunlight

Size 24 x 24

Installation Random

Remarks Gym

Mfr Rep Cindy Cedrone

cindy.cedrone@wolfgordon.com



NBPT Youth Services: Newburyport, MA

Finish Legend/Samples

AP-4

Manufacturer Momentum (Or Approved Equal by All-

Bright Vendor)

Collection

Style Panel

Color Heather Gray

Size 24" x 24"

Installation Random TBD

Remarks Lobby

Mfr Rep Rebecca Farren

rfarren@momtex.com (800) 366-6839 x356



Plastic Laminate

PL-1

Manufacturer Wilsonart

Style HD Laminate

Color Raleigh Walnut

Remarks Lobby

Mfr Rep Michelle O'Connor

michelle.oconnor@wilsonart.com

(781) 460-8144



PL-2

Manufacturer Wilsonart

Style Standard Laminate

Color Manitoba Maple

Remarks Restrooms at Sink Apron w/ matching

edgebanding

Mfr Rep Michelle O'Connor

michelle.oconnor@wilsonart.com

(781) 460-8144



NBPT Youth Services: Newburyport, MA

Finish Legend/Samples

PL-3

Manufacturer Wilsonart

Style Premium Laminate

Color White Cypress

Remarks Art Room, cabinets w/ matching

edgebanding

Mfr Rep Michelle O'Connor

michelle.oconnor@wilsonart.com

(781) 460-8144



Manufacturer Wilsonart

Style Premium Laminate

Color Raw Chestnut

Remarks Early Ed cabinets w/ matching

edgebanding

Mfr Rep Michelle O'Connor

michelle.oconnor@wilsonart.com

(781) 460-8144

Solid Surface (Counters including Quartz)

SS-1

Manufacturer Corian Solid Surface

Style 1.5" w/ pencil eased edged

Color Limestone Prima

Remarks Early Ed/ Art Room, restroom

Mfr Rep Lisa Carrescia

Icarrescia@parksite.com

(978) 855-0996



SS-2

Manufacturer Pental Quartz

Style Honed


Color BQ881 Blue Savoie


Remarks Lobby & Concessions

Mfr Rep Diane Carrescia

dianec@arcsurfaces.com

(508) 265-1290

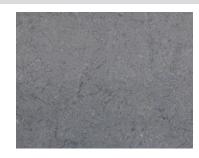

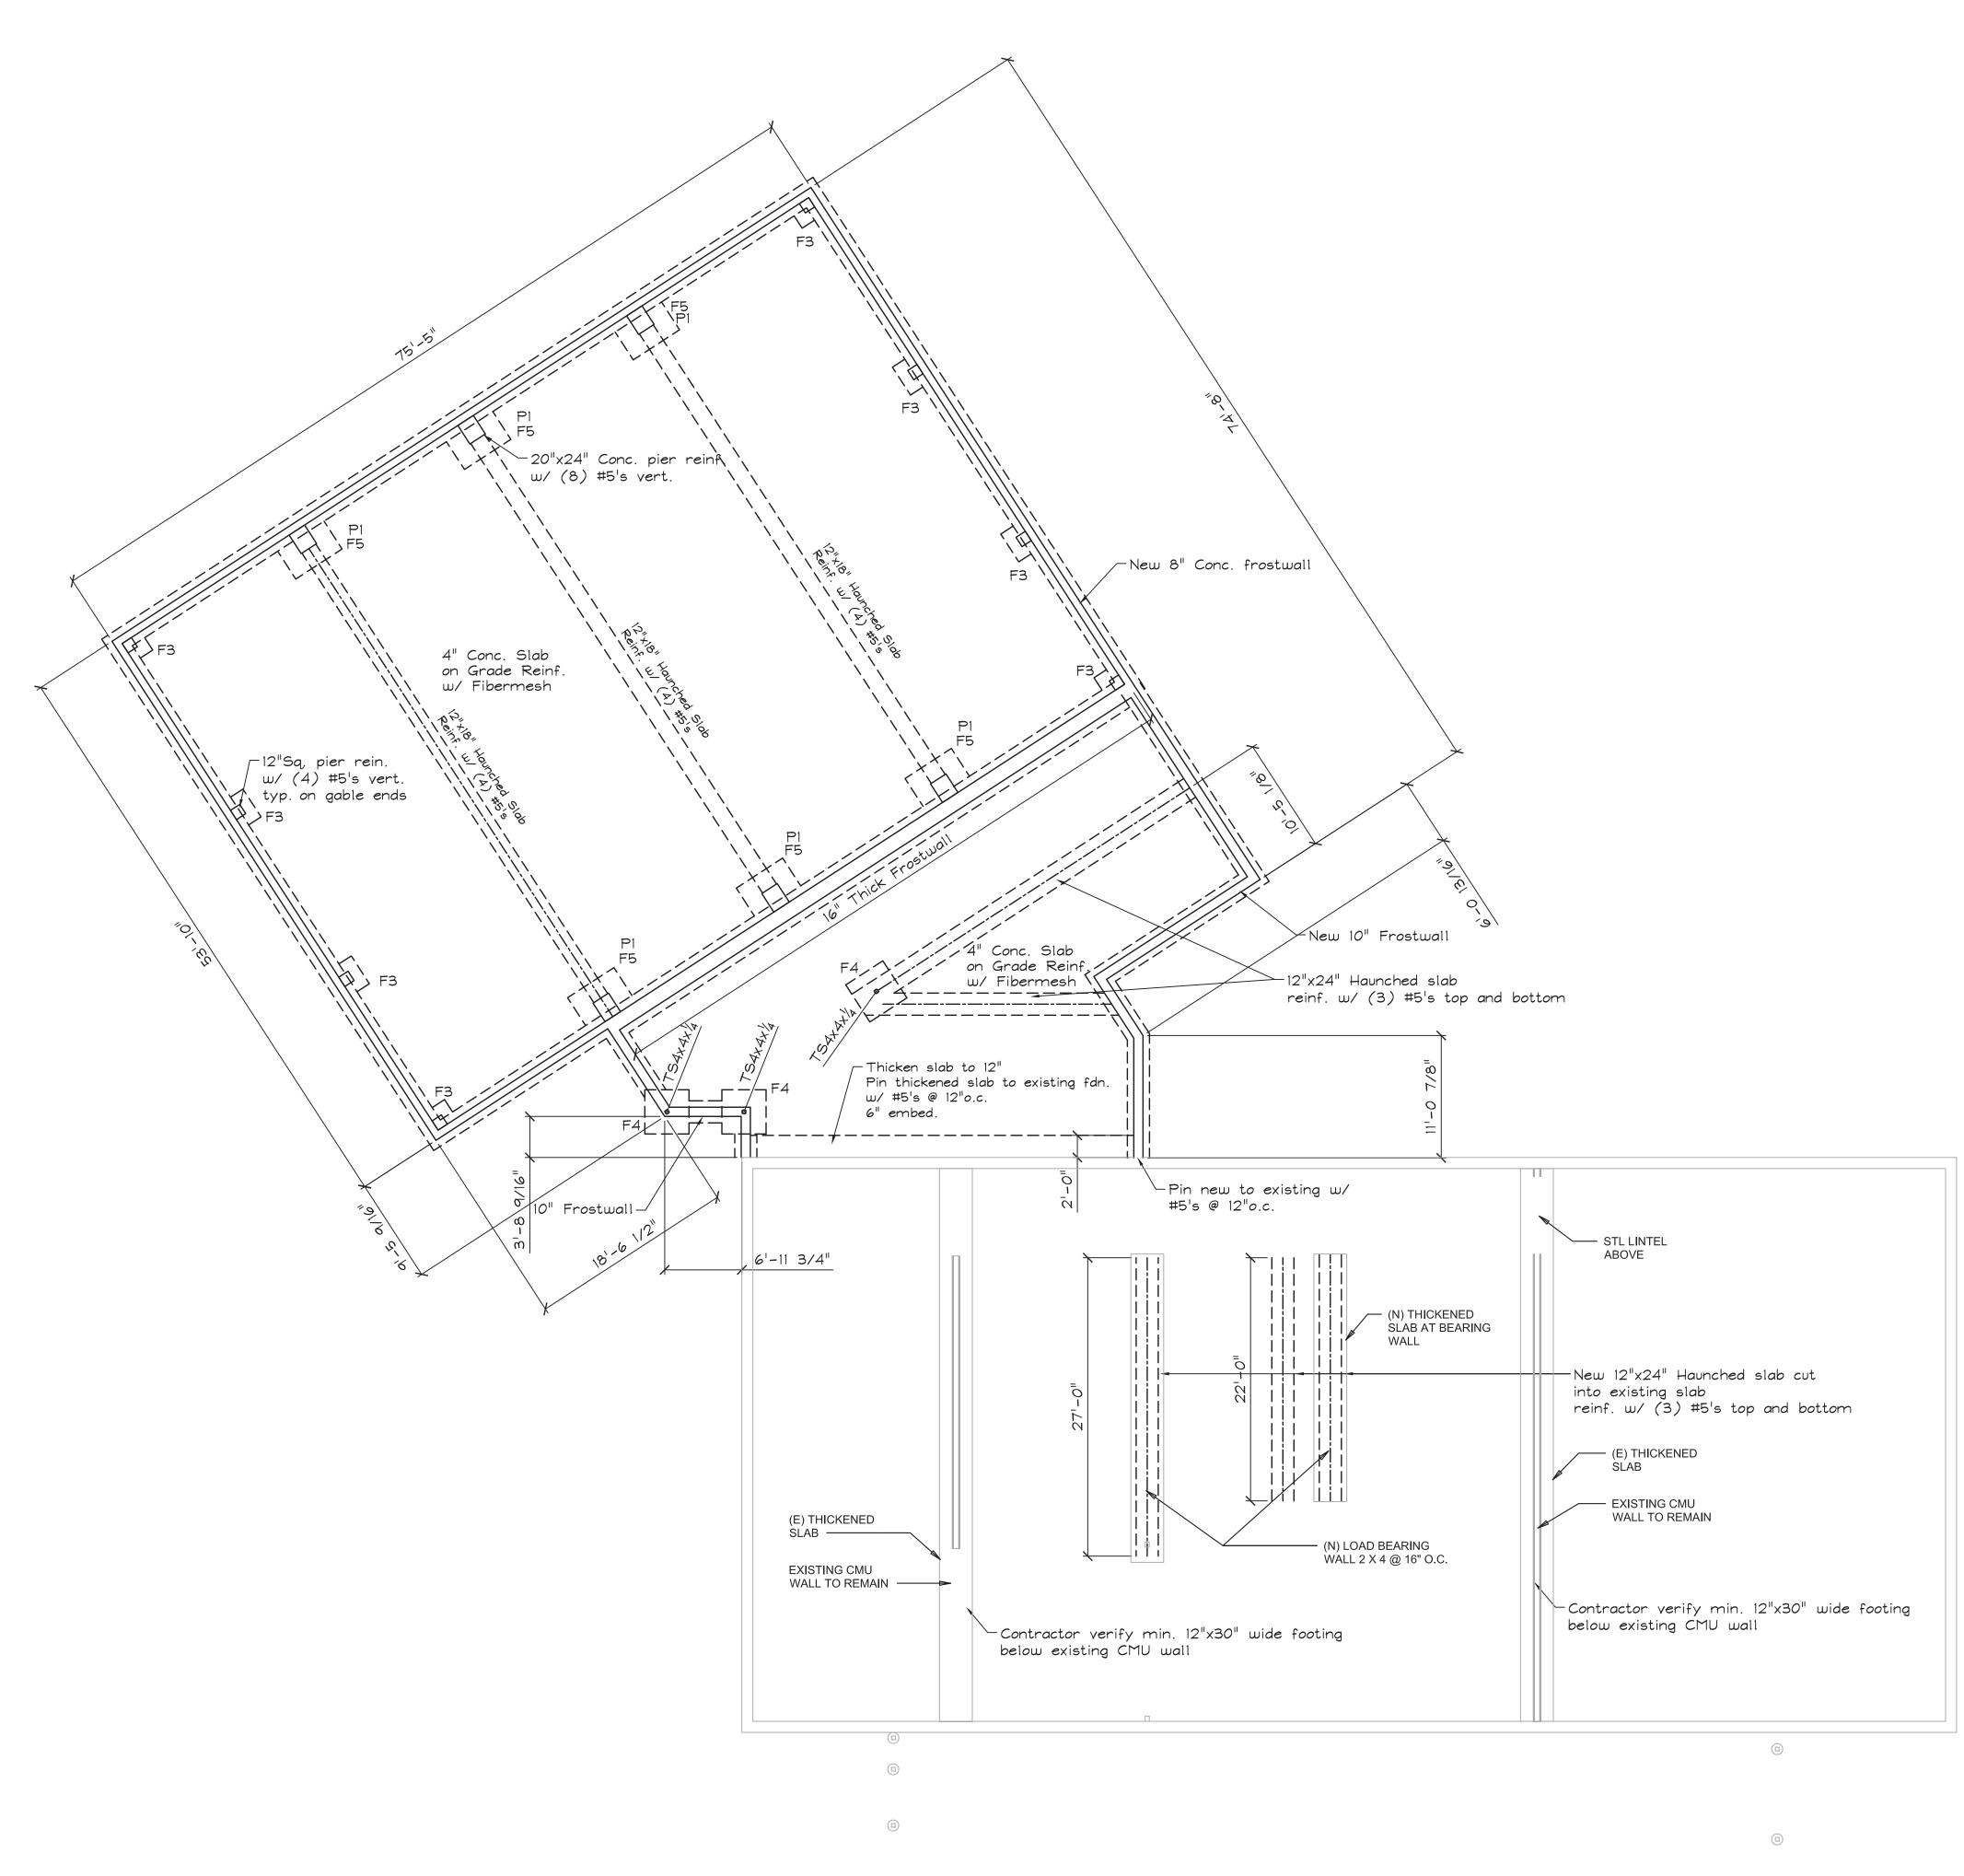

 FOOTING SCHEDULE

 Reinforcement
 Dimensions

 Length
 Width
 Thickness

 F3
 (5) #4's Each Way @ Bottom
 3'
 3'
 12"

 F4
 (5) #5's Each Way @ Bottom
 4'
 4'
 14"

 F5
 (6) #6's Each Way @ Bottom
 5'
 5'
 14"

 Notes:

FOUNDATION PLAN

Scale: 1/8" = 1'-0"

-SEI
SHELLEY ENGINEERING, INC.
STRUCTURAL CONSULTANTS

PO Box 1030 Gray, Maine 04039 Phone (207) 657-8031 www.ShelleyEngineering.com

STRUCTURAL ENGINEER:
Shelley Engineering
MEP ENGINEER:
BLW Engineers
INTERIOR DESIGNER:

Newburyport Youth Services
59 Low Street
Newburyport, MA 01950

Issued For: Date:


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Building Key:

Sheet Title: FOUNDATION PLAN

S-1



SHELLEY ENGINEERING, INC.
STRUCTURAL CONSULTANTS

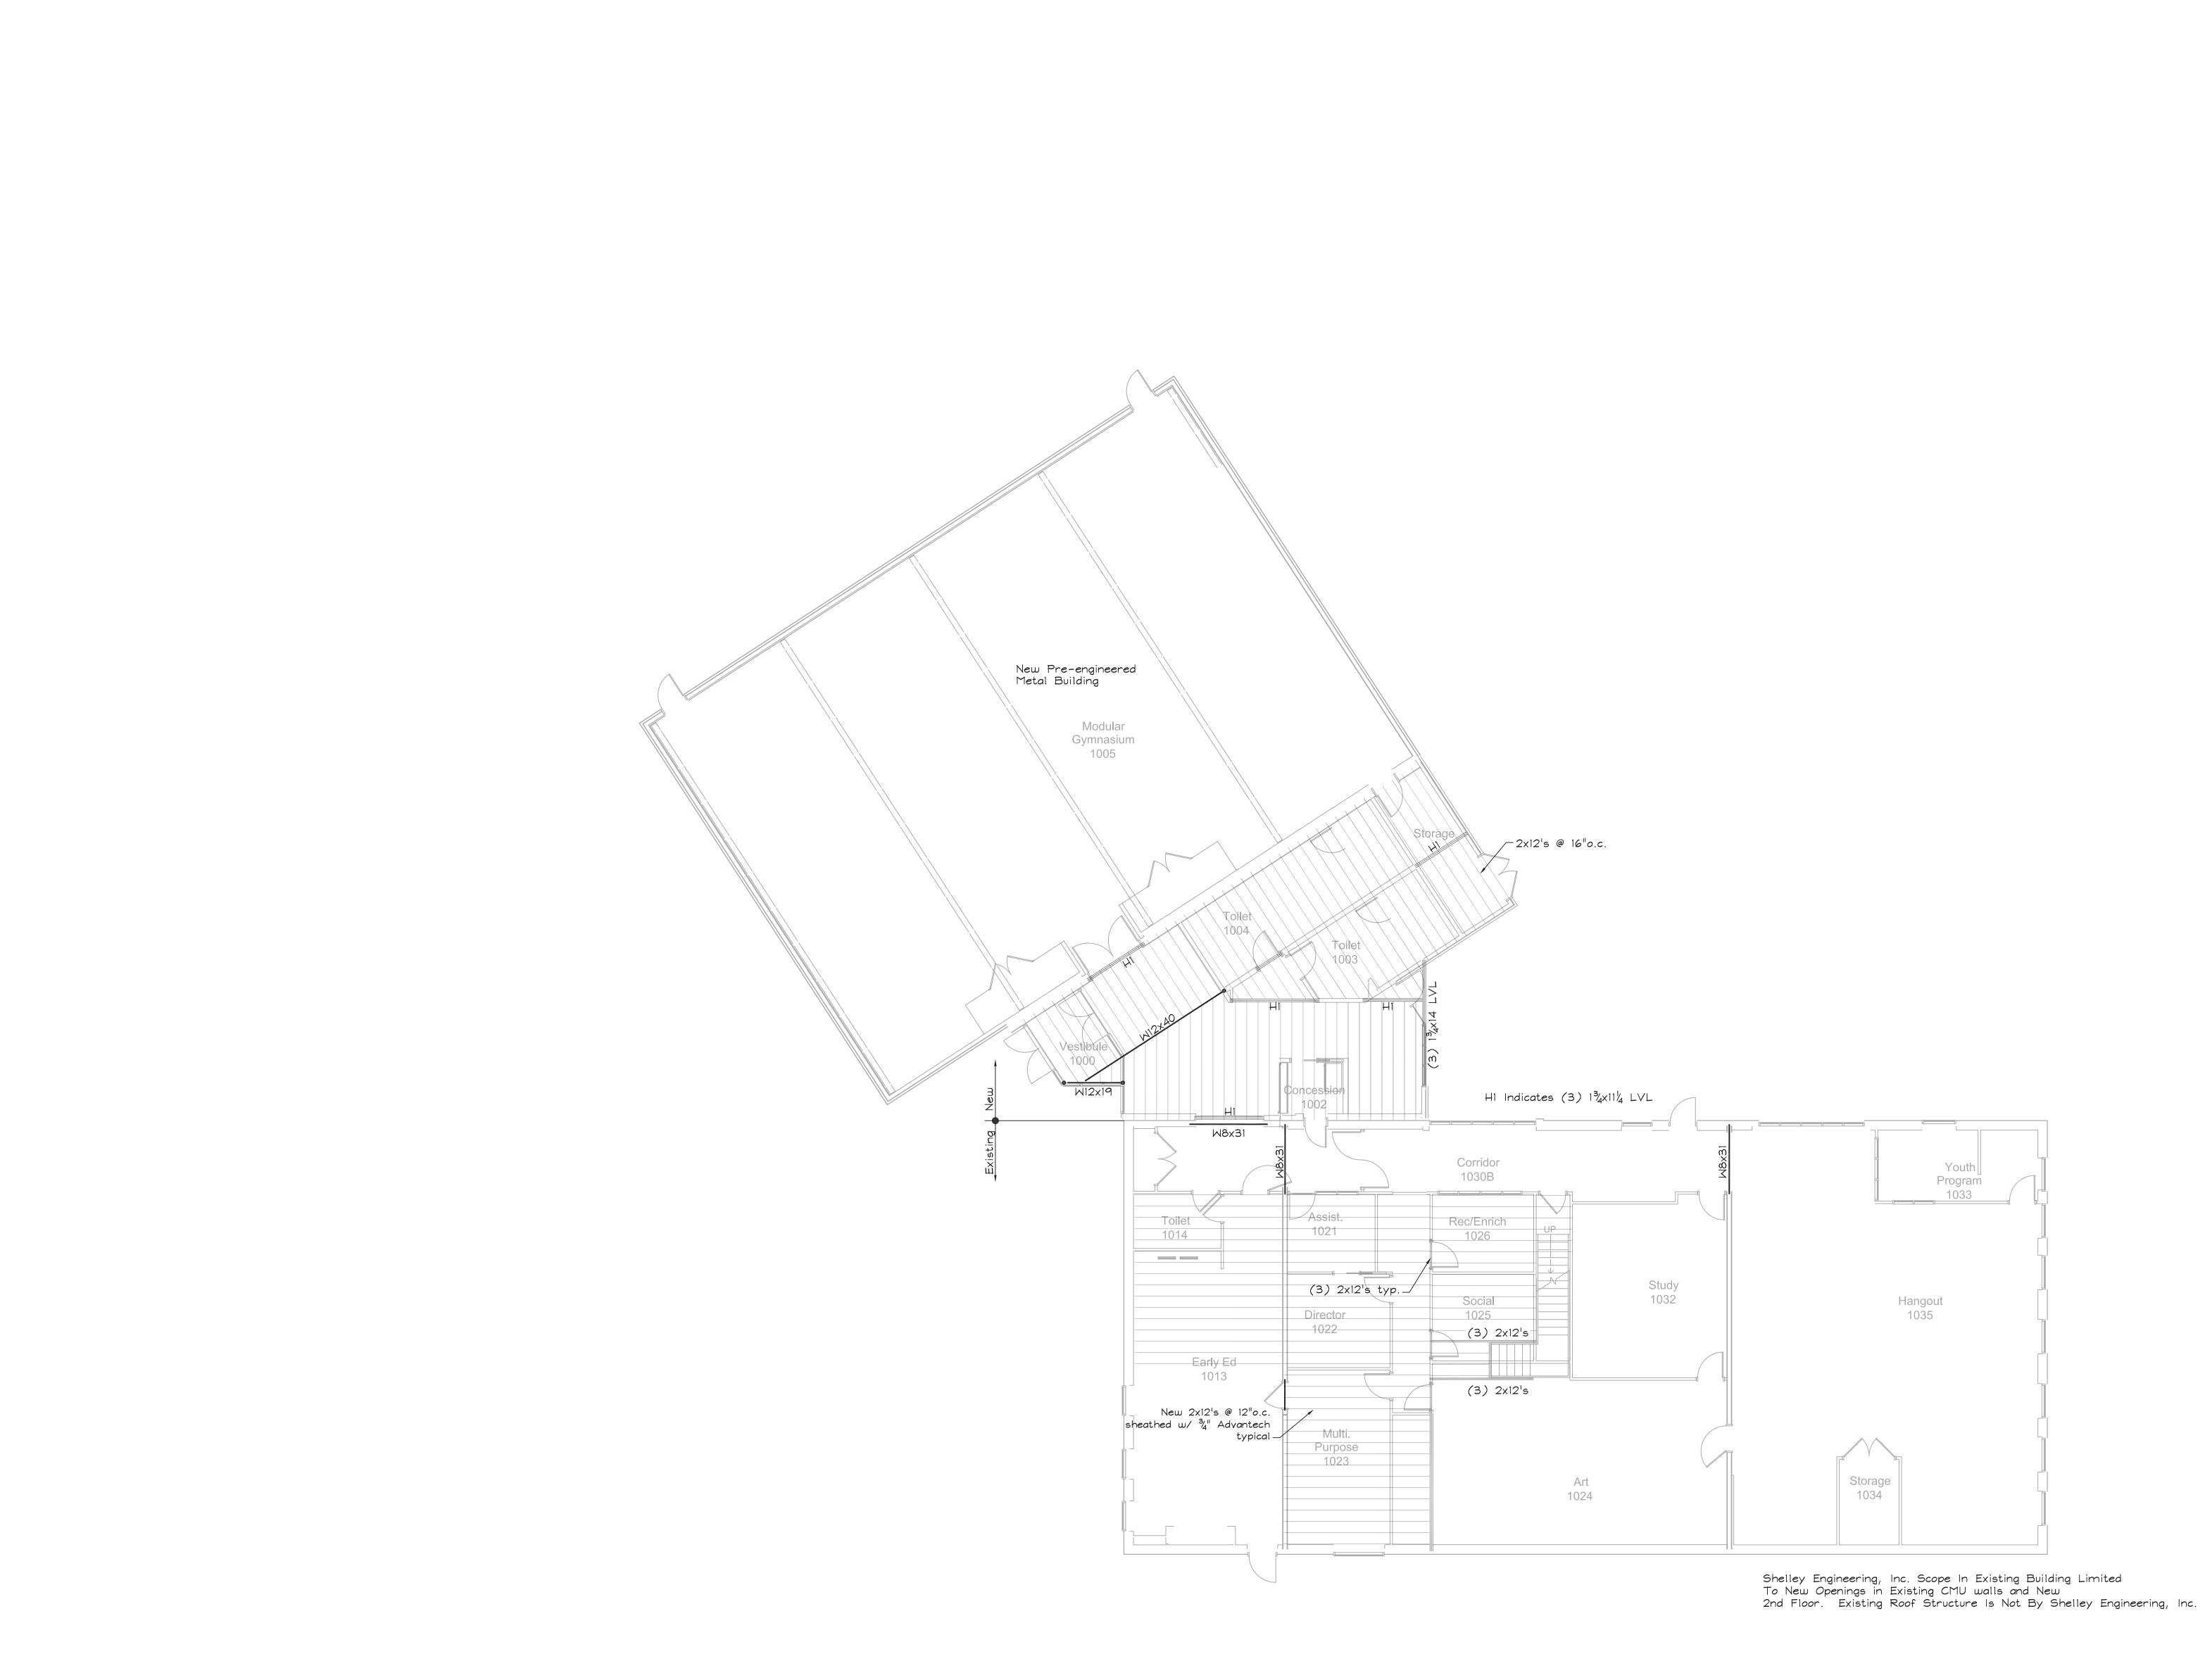PO Box 1030 Gray, Maine 04039 Phone (207) 657-8031 www.ShelleyEngineering.com

STRUCTURAL ENGINEER:
Shelley Engineering
MEP ENGINEER:
BLW Engineers
INTERIOR DESIGNER:

Newburyport Youth Services 59 Low Street Newburyport, MA 01950

Issued For: Date:

DD PRICING 9/7/2023

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Building Key:


Sheet Title:
2ND FLOOR/LOW
ROOF FRAMING
PLAN

Sheet Number:

S-2

2ND FLOOR/LOW ROOF FRAMING PLAN

Scale: 1/8" = 1'-0"

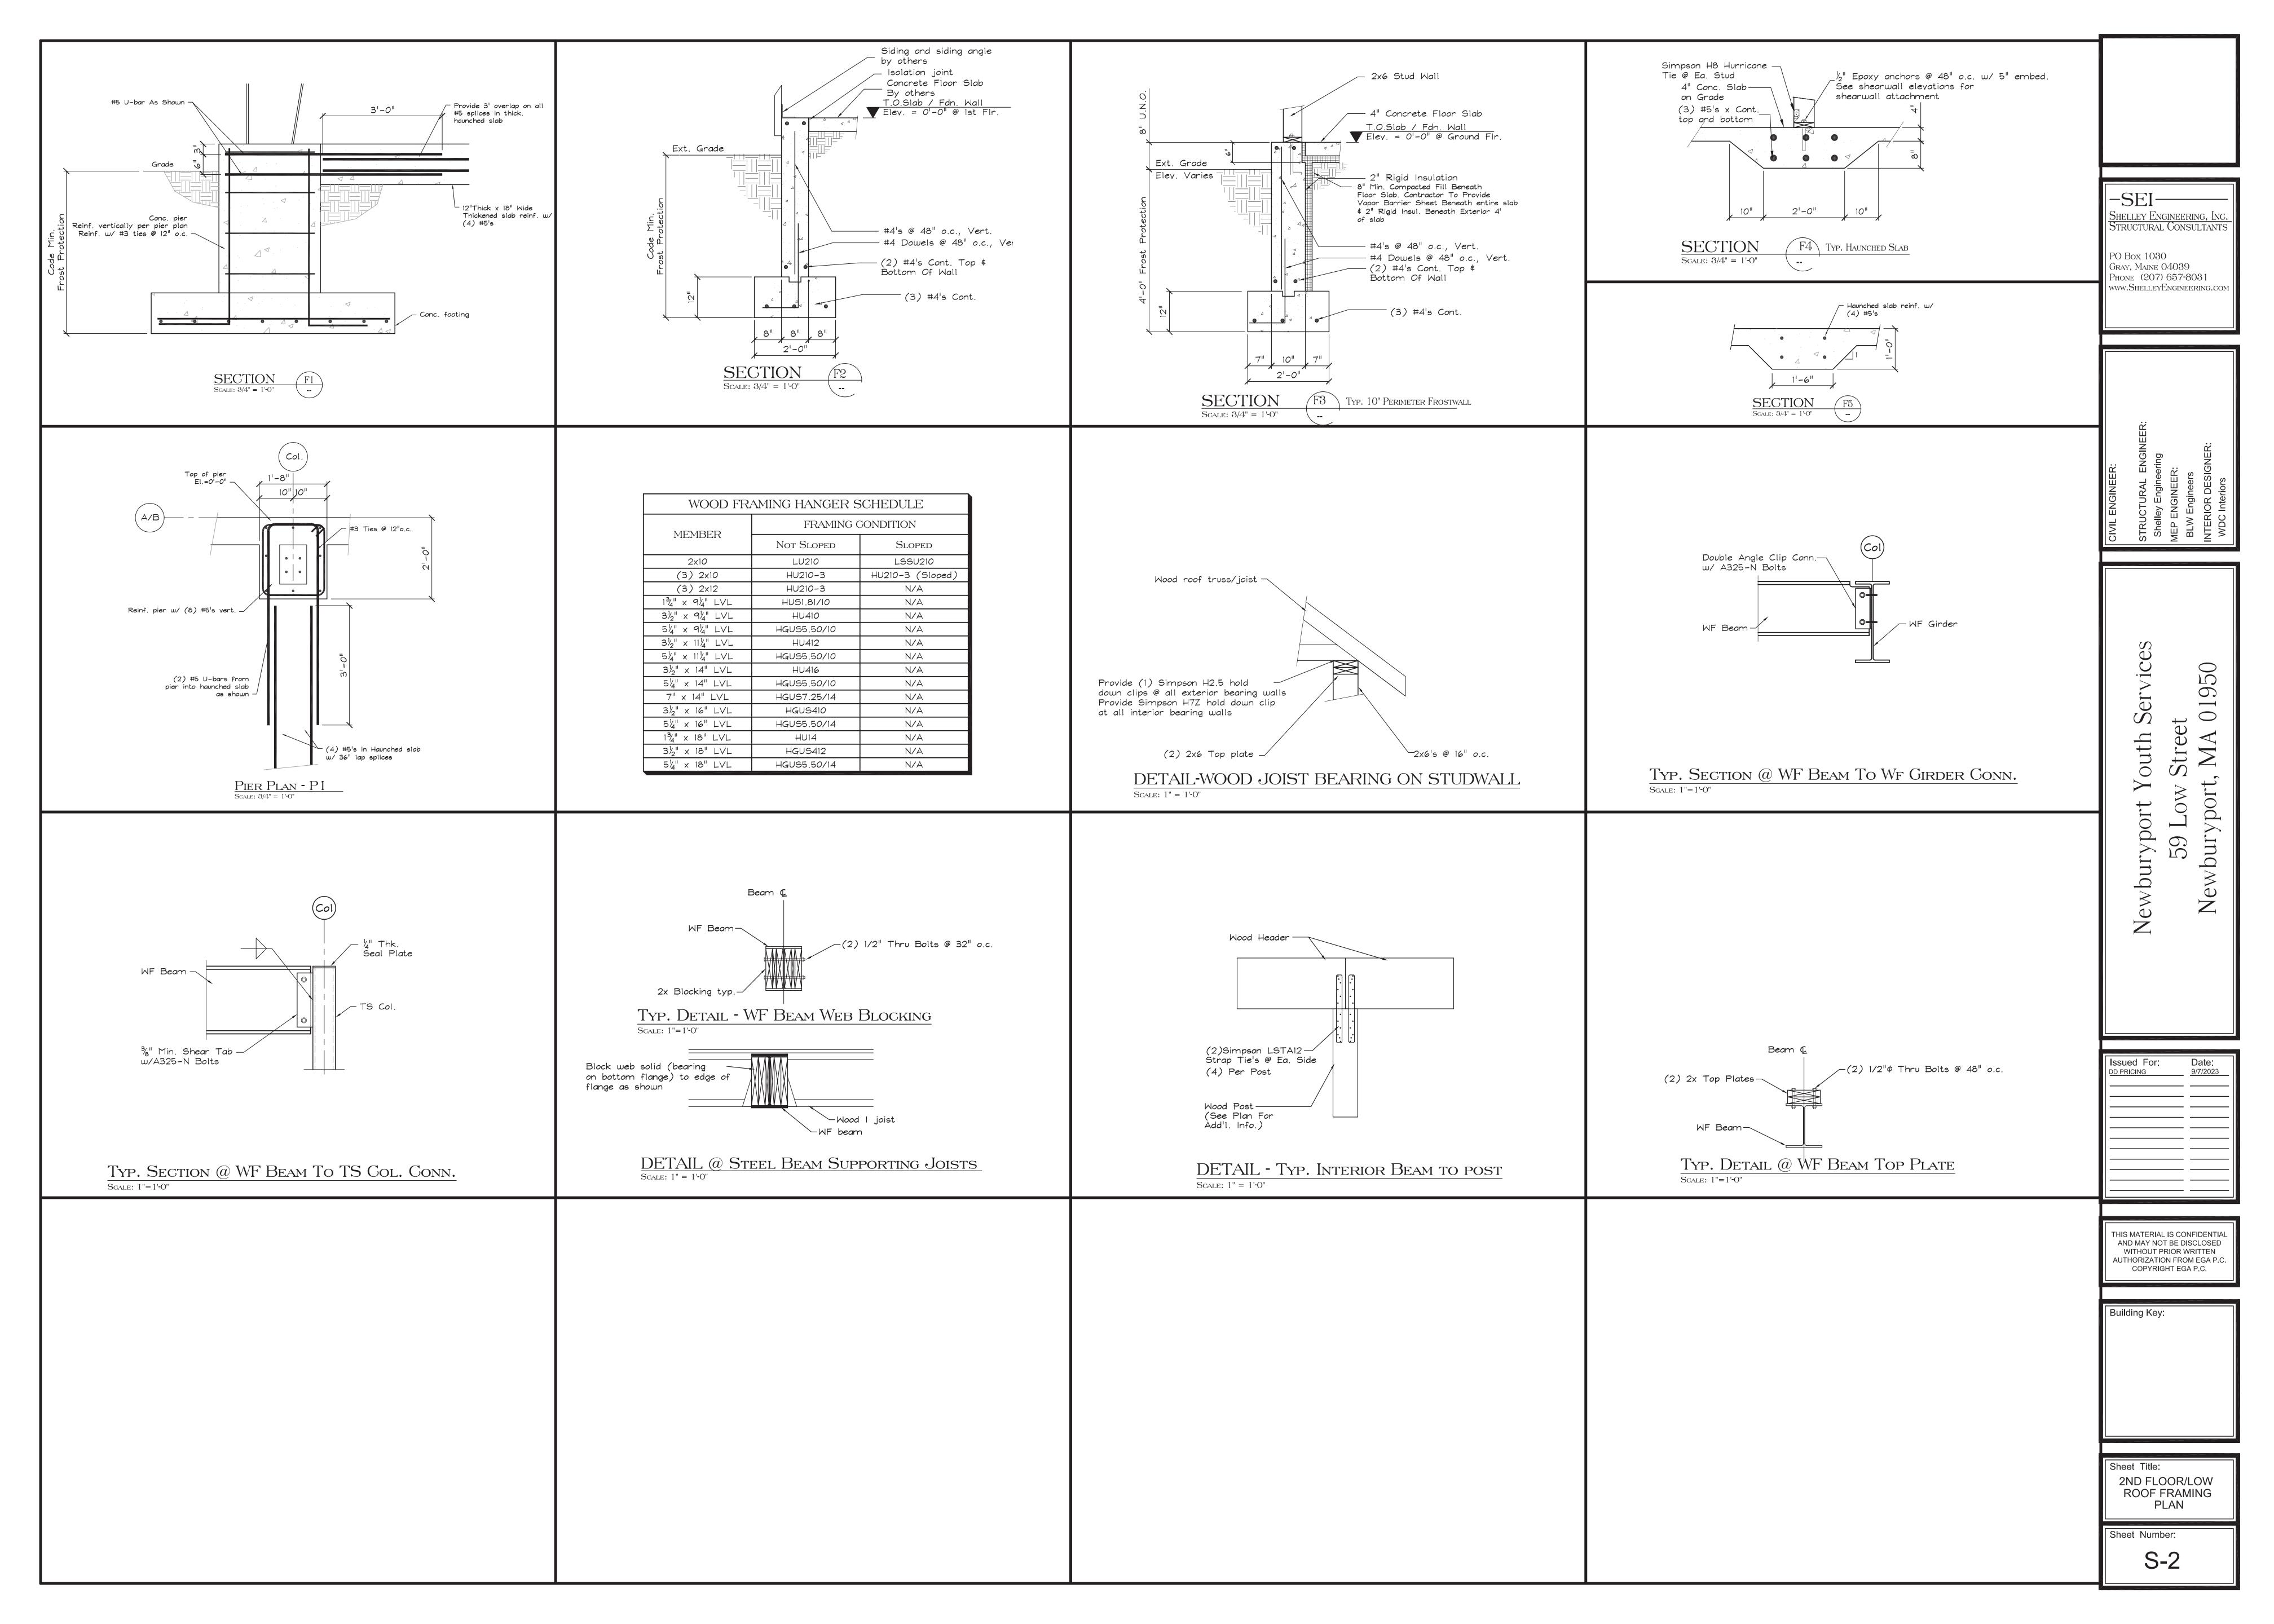

```
STRUCTURAL DESIGN CRITERIA:
1. BUILDING CODE: 9TH EDITION OF THE MASSACHUSETTS
                 BUILDING CODE
2. DESIGN WIND LOADS - MAIN WIND FORCE RESISTING SYSTEM:
   BUILDING EXPOSURE CATEGORY
   RISK CAT. 3 BASIC WIND SPEED (Vuit) = 138 MPH
    DESIGN WIND PRESSURE, ROOF:
      NORMAL TO RIDGE:
         WINDWARD
         LEEWARD
      PARALLEL TO RIDGE:
                                   PER 9TH EDITION OF THE
         WINDWARD
                                   MASSACHUSETTS BUILDING CODE
         LEEWARD
    DESIGN WIND PRESSURE, WALLS:
         WINDWARD
         LEEWARD
         SIDE WALLS
3. DESIGN WIND LOADS - COMPONENTS AND CLADDING:
    EXPOSURE CATEGORY = B
    DESIGN WIND PRESSURE, WALLS
         PRESSURE
         SUCTION
                                 PER 9TH EDITION OF THE
                                  MASSACHUSETTS BUILDING CODE
    DESIGN WIND PRESSURE, ROOF:
         PRESSURE
         SUCTION
4. LIVE:
                           = 40 PSF
         UNITS
                         = 100 PSF
         PUBLIC ROOMS
         EXTERIOR DECK = 100 PSF
         CORRIDORS
                      = 100 PSF
          RESIDENT STORAGE = 100 PSF
5. SNOW:
          GROUND SNOW LOAD
                                         = 50 PSF
         THERMAL FACTOR
                                         = 1.1
          IMPORTANCE FACTOR
                                         = 1.1
         EXPOSURE FACTOR
                                         = 1.0
          DRIFTING AND UNBALANCED SNOW AS REQUIRED BY CODE
6. ROOF DEAD LOAD
                                         = 20 PSF
7. FLOOR DEAD LOADS
         WOOD FRAMED
                                         = 30 PSF
8. DESIGN SEISMIC CRITERIA:
    EQUIVALENT LATERAL FORCE PROCEDURE
    OCCUPANCY CATEGORY
                                         = 0.265
                                         = 0.078
                                         = 4.5(=3 For Vertical Brace)
                                         = 4.0
    SEISMIC RESISTING SYSTEM = WOOD SHEARWALLS
GENERAL NOTES:
```

- 1. STRUCTURAL DRAWINGS SHALL BE USED IN CONJUNCTION WITH JOB SPECIFICATIONS AND ARCHITECTURAL, MECHANICAL, ELECTRICAL, PLUMBING, AND SITE DRAWINGS. CONSULT THESE DRAWINGS FOR LOCATIONS AND DIMENSIONS OF OPENINGS, CHASES, INSERTS, REGLETS, SLEEVES, DEPRESSIONS, AND OTHER DETAILS NOT SHOWN ON THE STRUCTURAL DRAWINGS.
- 2. ALL DIMENSIONS AND CONDITIONS MUST BE VERIFIED IN THE FIELD. ANY DISCREPANCIES SHALL BE BROUGHT TO THE ATTENTION OF THE ENGINEER BEFORE PROCEEDING WITH THE AFFECTED PART OF THE WORK.
- 3. THE STRUCTURE IS DESIGNED TO BE SELF SUPPORTING AND STABLE AFTER THE BUILDING IS COMPLETE. IT IS THE CONTRACTOR'S SOLE RESPONSIBILITY TO DETERMINE ERECTION PROCEDURES AND SEQUENCE TO ENSURE SAFETY OF THE STRUCTURE AND PERSONNEL DURING ERECTION. THIS INCLUDES THE ADDITION OF THE NECESSARY SHORING, SHEETING, TEMPORARY BRACING, GUYS OR TIEDOWNS. SUCH MATERIAL SHALL REMAIN THE PROPERTY OF THE CONTRACTOR AFTER COMPLETION OF THE PROJECT.
- 4. ALL APPLICABLE FEDERAL, STATE, AND MUNICIPAL REGULATIONS SHALL BE FOLLOWED, INCLUDING THE FEDERAL DEPARTMENT OF LABOR OCCUPATIONAL SAFETY AND HEALTH ACT.

FOUNDATION NOTES:

- 1. FOUNDATION DESIGN BASED ON AN ASSUMED MAXIMUM ALLOWABLE BEARING PRESSURE OF 2000 PSF. IT IS THE RESPONSIBILITY OF THE OWNER/CONTRACTOR TO VERIFY THE SOIL BEARING CAPACITY. NOTIFY THE ENGINEER AND STOP WORK IF CLAY, WET SOILS, FILL, OR OTHER DELETERIOUS MATERIALS ARE ENCOUNTERED.
- 2. DESIGN OF EXTERIOR FOUNDATIONS IS BASED ON A FROST DEPTH OF 4'-0" BELOW FINISHED GRADE.
- 3. NO HORIZONTAL JOINT WILL BE PERMITTED IN THE WALLS OR SLABS UNLESS NOTED OTHERWISE.
- 4. FOUNDATION CONTRACTOR SHALL SET COLUMN ANCHOR BOLTS AND LEVELING PLATES, INCLUDING GROUTING, AS PER THE STRUCTURAL STEEL CONTRACTOR'S DRAWINGS.
- 5. EXCAVATING AND BACK FILLING AT NEW AND EXISTING FOUNDATION WALLS SHALL BE DONE SUCH THAT SYMMETRICAL LOADING SHALL BE MAINTAINED ON BOTH SIDES. WHERE DESIGN CONDITIONS REQUIRE DIFFERENT BACK FILL HEIGHTS, WALLS SHALL BE FIRMLY SHORED IN POSITION, AND SHORES SHALL REMAIN UNTIL FLOORS ARE PLACED AND PROPERLY SET, TO ROVIDE FULL SUPPORT.
- 6. CONTRACTOR SHALL BE RESPONSIBLE FOR DESIGN, INSTALLATION, AND FINAL CLEARANCE OF ANY NEEDLING, SHORING, OR BRACING OF EXISTING STRUCTURES.

CONCRETE NOTES:

- 1. ALL CONCRETE WORK SHALL CONFORM TO ACI-318-98.
- 2. CONCRETE COMPRESSIVE STRENGTH AT 28 DAYS SHALL BE 3000 PSI (4000 PSI @ EXT. SLABS AND RETAINING WALL).
- 3. CONCRETE TO REMAIN EXPOSED TO WEATHER SHALL BE AIR ENTRAINED.
- 4. CONCRETE SHALL NOT BE PLACED IN WATER OR ON FROZEN GROUND.
 - 5. REINFORCING BARS SHALL CONFORM TO ASTM A615 GRADE 60. DEFORMED BARS SHALL BE DETAILED AND FABRICATED IN ACCORDANCE TO ACI-315 LATEST EDITION, AND PLACED IN ACCORDANCE WITH ACI-318.
 - 6. WELDED WIRE FABRIC SHALL CONFORM TO ASTM A185 AND BE PROVIDED IN FLAT SHEETS.
 - 7. SPLICES OF REINFORCING BARS SHALL BE IN ACCORDANCE WITH ACI-318-98. SPLICES OF WWF SHALL BE 6" MINIMUM.
 - 8. ANCHOR BOLTS SHALL CONFORM TO ASTM A307.
 - 9. HOOKS NOT DIMENSIONED SHALL BE ACI STANDARD HOOKS.
 - 10. CONCRETE COVER OVER REINFORCEMENT SHALL BE AS FOLLOWS: CONCRETE CAST AGAINST EARTH = 3"

 CONCRETE EXPOSED TO EARTH OR WEATHER $= \frac{3}{2}$ "

 CONCRETE NOT EXPOSED TO EARTH OR WEATHER $= \frac{3}{2}$ "
- 11. SUBMIT COMPLETE REBAR SHOP DRAWINGS AND SCHEDULES SHOWING ALL DETAILS AND ELEVATIONS PRIOR TO ANY FABRICATION.

STRUCTURAL STEEL NOTES - GENERAL

- STRUCTURAL STEEL FABRICATION, ERECTION, AND CONNECTION DESIGN SHALL CONFORM TO AISC "SPECIFICATION FOR THE DESIGN, FABRICATION, AND ERECTION OF STRUCTURAL STEEL" 9th EDITION.
- 2. ALL STEEL WIDE FLANGE SHAPES TO BE A572/A992 50 KSI AND STEEL PLATES TO BE ASTM A36 UNLESS NOTED OTHERWISE.
- 3. STRUCTURAL TUBING SHALL CONFORM TO ASTM A500, GRADE B. STEEL PIPES SHALL BE A53, GRADE B
- 4. THE DESIGN OF CONNECTIONS NOT SHOWN ON THE DRAWINGS SHALL BE PROVIDED BY THE FABRICATOR. CONNECTIONS SHALL BE DESIGNED FOR THE FORCES SHOWN, OR IF NOT SHOWN, EACH CONNECTION SHALL BE CAPABLE OF SUPPORTING ONE HALF THE TOTAL ALLOWABLE UNIFORM LOAD CAPACITY OF THE MEMBER, PER AISC MANUAL OF STEEL CONSTRUCTION.

 SHEAR REACTIONS WILL BE SUPPLIED TO THE FABRICATOR UPON REQUEST.
- 5. ALL BOLTED CONNECTIONS SHALL BE MADE WITH $\frac{3}{4}$ " ϕ ASTM A325 HIGH STRENGTH BOLTS.
- 6. WELDING SHALL BE IN ACCORDANCE WITH AWS D1.1 LATEST EDITION. ALL WELDS SHALL BE MADE WITH E70XX ELECTRODES.
- 7. STEEL BEAMS AND COLUMNS SHALL BE CUT FROM FULL LENGTH STOCK. UNAUTHORIZED SPLICES WILL BE CAUSE FOR REJECTION.
- 8. SUBMIT COMPLETE STRUCTURAL STEEL SHOP DRAWINGS FOR REVIEW PRIOR TO ANY STEEL FABRICATION.

WOOD FRAMING NOTES:

1. STRUCTURAL LUMBER:

No. 2 SPRUCE PINE FIR OR BETTER. Fb = 750 PSI Fv = 70 PSI Fc = 975 PSI E = 1100000 PSI LVL's & TJI'S AS MFG. BY BOISE CASCADE

2. DESIGN CODE: NATIONAL DESIGN SPECIFICATIONS FOR WOOD CONSTRUCTION BY THE NATIONAL FOREST PRODUCTS ASSOCIATION.

- 3. FASTENERS: COMPLY WITH RECOMMENDED FASTENING SCHEDULE
 OF THE APPLICABLE BUILDING CODE, LATEST EDITION,
- UNLESS SHOWN OTHERWISE ON THE DRAWINGS.

 4. NAILING REQUIREMENTS FOR PLYWOOD ROOF DECK:
- PROVIDE 8d NAILS AS FOLLOWS UNLESS SHOWN OTHERWISE; 8d NAILS @ 6" o.c. ALONG PANEL EDGES 8d NAILS @ 12" o.c. ALONG INTERMEDIATE MEMBERS
- 5. SPIKE TOGETHER ALL FRAMING MEMBERS WHICH ARE BUILT-UP USING MULTIPLE 2x LUMBER.
- 6. PROVIDE GALVANIZED METAL TIES EQUAL TO SIMPSON H2.5
 HURRICANE TIES BETWEEN ROOF TRUSSES AND SUPPORTING
 MEMBERS EA. SIDE OF TRUSSES ON OPPOSITE SIDES OF SUPPORTING
 MEMBERS, UNLESS SHOWN OTHERWISE. HOLD DOWN ANCHORS AT ALL
 GIRDER TRUSSES TO BE SPECIFIED DURING WOOD TRUSS
 SHOP DRAWING REVIEW BY ENGINEER OF RECORD.
- 7. PROVIDE PRESSURE TREATED LUMBER FOR ALL LUMBER IN CONTACT WITH MASONRY OR CONCRETE.
- 8. ROOF SHEATHING: 5/8" APA RATED SHEATHING, EXTERIOR OR STRUCTURAL I OR II RATED SHEATHING, SPAN RATING 32/16. INSTALL SHEETS WITH FACE GRAIN DIRECTION PERPENDICULAR TO SUPPORTING MEMBERS.
- 9. HEADER SIZES SUBJECT TO CHANGE BY ENGINEER OF RECORD AFTER WOOD TRUSS SHOP DRAWING REVIEW, DEPENDING ON EXACT LOCATIONS OF GIRDER TRUSSES BY WOOD TRUSS MANUFACTURER.
- 10. ALL SIMPSON POST BASES @ PORCHES SHALL BE STAINLESS STEEL.
 ALL OTHER SIMPSON HANGERS SHALL BE Z-MAX GALVANIZED (G185).

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S-3

GENERAL SPECIFICATION

- 1. DIELECTRIC INSULATING FITTINGS SHALL BE USED WHERE PIPES OF DISSIMILAR METALS ARE CONNECTED.
- 2. ALL PIPING SHALL BE NEW, INSTALLED PARALLEL TO BUILDING LINES AND PITCHED TO LOW POINTS
- 3. PLUMBING CONTRACTOR SHALL VISIT THE SITE AND VERIFY ALL CONDITION AND COORDINATE THE BEST ROUTE OF NEW PIPING AND LOCATIONS OF NEW EQUIPMENT IN COORDINATION WITH THE WORK OF ALL OTHER TRADES, AND ALL CONDITION TO INSURE THAT ALL WILL FIT IN THE SPACE WITH NO INTERFERENCES.
- THAT ALL WILL FIT IN THE SPACE WITH NO INTERFERENCES.

 4. ALL NEW SYSTEM SHALL BE TESTED, BALANCED AND ADJUSTED TO INSURE PROPER OPERATION AND CODE COMPLIANT INSTALLATION. PIPING AND EQUIPMENT SHALL BE

TESTED IN ACCORDANCE WITH THE STATE PLUMBING CODE.

- BAND HANGERS SHALL BE USED TO SUPPORT PIPING. PIPE SHIELDS SHALL BE INSTALLED TO PROTECT AGAINST DAMAGE TO THE PIPE INSULATION. 3/8" RODS SHALL BE USED.
- 6. ALL COLD WATER, HOT WATER, HOT WATER RETURN, TEMPERED WATER SUPPLY AND RETURN, CHILLED WATER SUPPLY AND RETURN PIPING SHALL BE INSULATED WITH 1 ½" FIBERGLASS INSULATION WITH FACTORY APPLIED JACKET. ALL FITTINGS AND VALVES SHALL BE PROVIDED WITH INSULATION AND WHITE PREMOLDED PVC INSULATION COVERS. ALL COLD WATER PIPING MAINS AND BRANCH RUNOUTS THAT ARE EXPOSED SHALL BE COVERED WITH WHITE PVC PIPE COVERS. THIS SHALL INCLUDE ALL FITTINGS AND VALVES. ALL FITTINGS AND VALVES SHALL BE PROVIDED WITH INSULATION AND WHITE PROMOLDED PVC INSULATION COVERS.
- 7. ABOVE GROUND WATER PIPING SHALL BE TYPE "L" COPPER WITH SOLDER JOINTS USING 95/5 SOLDER. BELOW GROUND WATER PIPING SHALL BE TYPE "K" COPPER WITH SILVER SOLDER JOINTS, FLARED END JOINTS OR OTHER FITTINGS AS APPROVED BY THE STATE PLUMBING
- 8. DRAIN AND VENT PIPING 2" AND SMALLER SHALL BE TYPE "L" COPPER WITH SOLDER JOINTS AND DRAINAGE PATTERN FITTINGS.
- 9. DRAIN AND VENT PIPING ABOVE GROUND LARGER THAN 2" SHALL BE SERVICE WEIGHT CAST IRON WITH STAINLESS NO-HUB FITTINGS AND COUPLINGS WITH NEOPRENE GASKET. DRAIN PIPING BELOW GROUND SHALL BE AS ABOVE, EXCEPT FOR MECHANICAL JOINT WITH PUSH ON FITTINGS AND RESILIENT GASKET.
- 10. ALL VALVES INSTALLED ON PIPING INTENDED FOR POTABLE WATER AND/OR CONSUMPTION SHALL BE LEAD FREE.
- 11. BALL VALVES SHALL BE LEAD FREE, FULL PORT WITH STAINLESS STEEL BALL AND STEM WITH SOLDER OR THREADED FITTINGS AS APPLICABLE.
- 12. THE PLUMBING CONTRACTOR SHALL BE RESPONSIBLE FOR ALL CUTTING AND PATCHING OF WALLS AND FLOORS TO ACCOMMODATE INSTALLATION OF NEW PIPING AND EQUIPMENT. THE PLUMBING CONTRACTOR SHALL PATCH ALL SURFACE TO MATCH EXISTING CONDITION, AND TO THE SATISFACTION OF THE OWNER/ARCHITECT.
- 13. ALL VALVES INDICATED SHALL BE BY APOLLO, CONBRACO, WATTS, OR APPROVED EQUAL.
- 14. ALL CLEANOUTS SHALL BE BY J.R. SMITH, ZURN, WATTS, OR APPROVED EQUAL. CLEANOUT SHALL BE WITH BRONZE PLUGS.
- 15. ALL SHOCK ABSORBERS SHALL BE BY J.R. SMITH, WATTS, SIOUX CHIEF OR APPROVED EQUAL.
 16. ALL VALVES SHALL BE PROVIDED WITH TAGS, ALL PIPING SHALL BE LABELED WITH ADHESIVE
- DECALS PER ASME AND STATE PLUMBING CODE STANDARDS.

 17. PROVIDE ACCESS PANELS BY MILACRON. ACCESS PANELS SHALL BE 18"X18" AND SHALL BE WITH A PRIMED FINISH FOR PAINTING BY OTHERS. ACCESS PANELS SHALL BE TO THE G.C. FOR INSTALLATION. ALL ACCESS PANEL SHALL BE APPROVED BY THE OWNER/ARCHITECT
- 18. PROVIDE "P" TRAP FOR ALL FLOOR DRAINS, AND WHERE REQUIRED.

PRIOR TO PURCHASE.

- 19. THE DRAWINGS ARE DIAGRAMMATIC ONLY. THE PLUMBING CONTRACTOR SHALL BE RESPONSIBLE FOR DETERMINING THE EXACT ROUTE OF ALL PIPING IN THE FIELD AND IN CONJUNCTION WITH COORDINATION OF ALL EXISTING CONDITIONS, NEW CONSTRUCTION, AND COORDINATION WITH ALL OTHER TRADE TO INSURE ALL OF THE PLUMBING SYSTEM WILL FIT INTO THE SPACE WITH NO INTERFERENCE BETWEEN ANY EXISTING OR NEW CONDITION AND ANY OTHER TRADE.
- 20. THE PLUMBING CONTRACTOR SHALL BE RESPONSIBLE FOR THE INSTALLATION OF ALL EQUIPMENT REQUIRING PLUMBING CONNECTION.
- 21. ALL WATER PIPING SHALL BE TESTED FOR COLIFORM BY A LICENSED TESTING LAB. A CERTIFIED REPORT FROM THE LAB SHALL BE SUBMITTED TO THE PLUMBING INSPECTOR FOR REVIEW AND APPROVAL. THIS SHALL BE DONE AND APPROVAL SHALL BE OBTAINED FROM THE INSPECTOR PRIOR TO FINAL ACCEPTANCE OF THE PLUMBING WORK.
- 22. THE PLUMBING CONTRACTOR SHALL SUBMIT MANUFACTURERS' SHOP DRAWINGS FOR ALL PROPOSED MATERIAL, VALVE, AND EQUIPMENT TO THE PLUMBING ENGINEER FOR APPROVAL. WRITTEN APPROVAL OF ALL PROPOSED MATERIAL, VALVE, AND EQUIPMENT SHALL BE RECEIVED FROM THE PLUMBING ENGINEER PRIOR TO THE COMMENCEMENT OF ANY PLUMBING WORK.

GENERAL NOTES

- 1. ALL PLUMBING WORK SHALL BE DONE IN ACCORDANCE WITH THE MASSACHUSETTS STATE PLUMBING CODE, LATEST EDITION.
 - CAREFULLY COORDINATE LOCATION OF PIPING WITH ALL OTHER TRADES.
 - ALL PIPING SHOWN DIAGRAMMATICALLY AND EXACT LOCATION SHALL BE DETERMINED IN THE FIELD.
 ALL PIPING SHALL BE RUN CONCEALED ABOVE CEILINGS, IN WALLS AND IN CHASES, UNLESS
 - 4. ALL PIPING SHALL BE RUN CONCEALED ABOVE CEILINGS, IN WALLS AND IN CHASES, UNLESS OTHERWISE NOTED.
 - 6. ALL PIPING SHALL BE SUPPORTED FROM BUILDING STRUCTURE.
 - 7. THE TERM "PROVIDE" SHALL MEAN FURNISH AND INSTALL.
 - 8. RUN WATER PIPE ON THE WARM SIDE OF BUILDING INSULATION. NO WATER PIPING SHALL BE RUN ON EXTERIOR WALLS.

5. NO STRUCTURAL MEMBERS SHALL BE CUT WITHOUT THE APPROVAL OF THE STRUCTURE ENGINEER.

- 9. PROVIDE DRAWOFFS WITH BALL VALVE, HOSE END VACUUM BREAKER, CAP & CHAIN AT ALL DOMESTIC WATER LOW POINTS AND PITCH PIPING TO DRAIN.
- 10. ALL SANITARY WASTE PIPING SHALL PITCH A MIN OF $\frac{1}{8}$ " PER FT. FOR PIPING 4" & LARGER, AND $\frac{1}{4}$ " PER FT FOR
- 11. PROVIDE SHOCK ABSORBERS ON ALL PIPING SERVICING FLUSH VALVE FIXTURES.

DERRICKS, ETC., NECESSARY FOR INSTALLATION OF WORK

- 12. ALL PIPING SHALL BE NEW, INSTALLED PARALLEL TO BUILDING LINES AND PITCHED TO LOW POINTS.
 13. PLUMBING CONTRACTOR SHALL PROVIDE FIRESTOPPING FOR ALL PENETRATIONS THRU FIRE WALLS AND
- FIRE RATED SEPARATIONS. COORDINATE WITH ARCHITECTURAL DRAWINGS FOR THESE AREAS.

 14. PLUMBING CONTRACTOR SHALL FURNISH, INSTALL AND MAINTAIN ALL SCAFFOLDING, HOISTING EQUIPMENT
- 15. ALL PLUMBING PIPING AND DRAINS SHALL BE KEPT CLEAR OF BLOCKAGE WHILE CONSTRUCTION IS UNDERWAY. ALL PLUMBING PIPING SHALL BE DEBURRED BEFORE JOINTS ARE MADE
- 16. THE PLUMBING CONTRACTOR SHALL PROVIDE ALL CUTTING AND PATCHING IN ORDER TO ACCOMMODATE THE PLUMBING WORK
- 17. WHERE PLUMBING DROPS ONLY ARE SHOWN TO FIXTURES OR GROUPS OF FIXTURES, THE PLUMBING CONTRACTOR SHALL MAKE ALL FINAL CONNECTIONS OF WATER, SANITARY AND VENT TO EACH FIXTURE. PLUMBING CONNECTIONS TO FIXTURES SHALL BE IN ACCORDANCE WITH THE PLUMBING FIXTURE SCHEDULE. PROVIDE SERVICE STOP AT EACH FIXTURE
- 18. ALL ISOLATION VALVES AND BUTTERFLY VALVES INSTALLED IN WALLS OR ABOVE CEILINGS SHALL BE PROVIDED WITH ACCESS PANELS . WHERE REMOVABLE SUSPENDED CEILING TILES ARE USED, NO ACCESS PANELS ARE REQUIRED.
- 19. ALL PIPING RISER PENETRATIONS THRU FLOORS SHALL BE SEALED WATER TIGHT
- 20. ALL EXISTING CONDITIONS SHOWN ARE APPROXIMATE ONLY AND ARE NOT INTENDED TO SHOW EXACT EXISTING CONDITIONS. ALL EXISTING CONDITIONS SHALL BE VERIFIED BY THE PLUMBING CONTRACTOR IN THE FIELD. ALL POINTS OF CONNECTION TO EXISTING SYSTEMS SHALL BE DETERMINED IN THE FIELD BY THE PLUMBING CONTRACTOR.
- 21. PRIOR TO BID, THE CONTRACTOR SHALL VISIT THE SITE AND FAMILIARIZE THEMSELVES WITH ALL ASPECTS OF THE WORK AND ALL CONDITIONS TO WHICH THE WORK WILL BE INSTALLED. ANY DISCREPANCY BETWEEN THE WORK SHOWN ON THE DRAWINGS AND ANY CONDITIONS, EXISTING OR PROPOSED, SHALL BE SUBMITTED TO THE ARCHITECT IN WRITING. FAILURE OF THE CONTRACTOR TO FAMILIARIZE THEMSELVES WITH ALL EXISTING CONDITIONS AND THEIR RELATION TO THE NEW WORK AND FAILURE TO SUBMIT DISCREPANCIES IN WRITING TO THE ARCHITECT PRIOR TO THE COMMENCEMENT OF ANY PLUMBING WORK SHALL NOT BE ACCEPTED AS A CAUSE FOR ANY EXTRA CHARGE TO THE CONTRACT.
- 22. CONTRACTOR SHALL COORDINATE ALL SHUT DOWNS OF EXISTING SYSTEMS WITH OWNER. ALL SHUT DOWNS SHALL BE PERFORMED AS REQUESTED BY OWNER. NO SHUT DOWNS SHALL BE PERFORMED DURING NORMAL BUSINESS UNLESS AUTHORIZED BY OWNER

BUILDING UTILITY PLUMBING FIXTURE NOTES NOTES

1. ALL UNDERGROUND SANITARY, STORM, DOMESTIC WATER & FIRE PROTECTION LOCATIONS MAY VARY FROM WHERE SHOWN ON DRAWINGS WITH THE ACTUAL BUILDING. THE LOCATIONS SHOWN ON THE PLUMBING DRAWINGS ARE INTENDED TO SHOW APPROXIMATE LOCATIONS ONLY AND ARE NOT INTENDED TO BE USED FOR THE BUILDING AT THE SITE. THE PLUMBING CONTRACTOR SHALL CAREFULLY COORDINATE THE LOCATIONS AND SIZES OF ALL UNDERGROUND SANITARY, STORM, DOMESTIC WATER, PROPANE AND FIRE PROTECTION MAINS THAT ENTER AND EXIT THE BUILDING WITH THE CIVIL DRAWINGS, THE SITE CONTRACTOR, THE FIRE PROTECTION CONTRACTOR AND THE ARCHITECT IN ORDER TO ESTABLISH EXACT LOCATIONS AND INVERT ELEVATIONS FOR THE BUILDING AT THE SITE. NO WORK SHOWN ON THE PLUMBING DRAWINGS SHALL BE INSTALLED UNTIL THIS

COORDINATION HAS BEEN COMPLETED AND EXACT LOCATIONS, SIZES AND INVERT ELEVATIONS HAVE BEEN APPROVED BY THE SITE CONTRACTOR, THE FIRE PROTECTION CONTRACTOR AND THE ARCHITECT.

2. ANY PLUMBING WORK THAT HAS BEEN INSTALLED AT THE SITE WITHOUT THIS COORDINATION BEING PERFORMED BY THE PLUMBING CONTRACTOR WILL

RESULT IN PLUMBING WORK BEING REMOVED AND

REPLACED BY THE PLUMBING CONTRACTOR AT NO

ADDITIONAL COST TO THE CONTRACT.

1. PLUMBING FIXTURES ARE TO BE PURCHASED BY THE PLUMBING CONTRACTOR UNDER OWNER/GENERAL CONTRACTOR DIRECTION OR AS PROVIDED ON THE ARCHITECTURAL SET OF PLANS. PLUMBING CONTRACTOR IS TO COORDINATE WITH MANUFACTURER ON FIXTURE CODE COMPLIANCE AND MA APPROVAL PRIOR TO PURCHASE. COORDINATE ALL FIXTURE INSTALLATION DIMENSIONS WITH THE DETAILS ON THE ARCHITECTURAL DRAWINGS AND PER MAAB

2. ALL PLUMBING FIXTURES, FAUCETS, AND FLUSH VALVES SHALL BE FIELD ADJUSTED TO ENSURE PROPER CODE COMPLIANT OPERATION FOR TEMPERATURE AND FLOW.

REQUIREMENTS.

3. ALL HANDWASHING FIXTURES SHALL BE FIELD ADJUSTED TO LIMIT THE HOT WATER TEMPERATURE TO 110°F AS REQUIRED.

4. PROVIDE SERVICE STOPS FOR ALL NEW FIXTURES. ALL EXPOSED WATER & WASTE PIPING

ASSOCIATED WITH FIXTURES SHALL BE CHROME FINISH. PROVIDE ALL SUPPLIES, SERVICE STOPS, TAILPIECES, AND TRAPS FOR FIXTURES AS REQUIRED. PROVIDE ALL FINAL CONNECTIONS.

5. PROVIDE CONCEALED WALL CARRIERS FOR ALL WALL MOUNTED FIXTURES. CARRIERS SHALL BE BY

6. PROVIDE PRE-MOLDED INSULATION KITS ON ALL WASTE & WATER PIPING, VALVES & FITTINGS DIRECTLY BELOW ACCESSIBLE FIXTURES. INSULATION KIT TO BE BY IPS TRUEBRO.

ZURN OR APPROVED EQUAL.

PLUMBING LEGEND & ABBREVIATIONS

ARCH

СО

CONN

CONT

CTE

ELEC

RE

ETR

FCO

MAX MAXIMUM

NIC NOT IN CONTRACT

NTS NOT TO SCALE

RD ROOF DRAIN

SH SHOWER

TYP TYPICAL

UR URINAL

TP TRAP PRIMER

VTR VENT THRU ROOF

WC WATER CLOSET

WH WALL HYDRANT

OED OPEN-END DRAIN

P-# PLUMBING FIXTURE DESIGNATION

PC PLUMBING CONTRACTOR

REMOVE EXISTING

SOLIDS INTERCEPTOR

	CW	COLD WATER
	HW	HOT WATER
	HWR	HOT WATER RETURN
=======================================	CW	COLD WATER BELOW FLOOR
===	HW	HOT WATER BELOW FLOOR
======	HWR	HOT WATER RETURN BELOW FLOOR
	SAN OR W	SANITARY WASTE
	SAN OR W	SANITARY WASTE BELOW FLOOR
	V	VENT
= = = = = = = = = = = = = = = = = = =	V	VENT BELOW FLOOR
G	G	NATURAL GAS LINE
TP	TP	TRAP PRIMER SUPPLY
TP=	TP	TRAP PRIMER SUPPLY BELOW FLOOR
	FCO	FLOOR CLEANOUT
	GCO	GRADE CLEANOUT
——————————————————————————————————————	CO	CLEANOUT
—	WCO	WALL CLEANOUT - PROVIDE ACCESS PANEL
—		CAPPED PIPE
─		PIPE BREAK
		WATERTIGHT SLEEVE
		BALL VALVE
——————————————————————————————————————	TMV	THERMOSTATIC MIXING VALVE
		BALANCING VALVE
— <u>—</u> —	PRV	PRESSURE REGULATING VALVE
	RPBFP	REDUCED PRESSURE ZONE BACKFLOW PREVENTER
	SA / WHA	SHOCK ABSORBER, WATER HAMMER ARRESTOR
	TP	TRAP PRIMER VALVE
O		ELBOW UP/RISE
 >		ELBOW DOWN/DROP
—∞		OPEN-END DRAIN/P-TRAP
	НВ	HOSE BIBB
\rightarrow	WH	WALL HYDRANT
	FD	FLOOR DRAIN
#		DETAIL DESIGNATION NUMBER

DETAIL DESIGNATION NUMBER
DRAWING NUMBER

ABOVE FINISHED FLOOR
ARCHITECT
BACKWATER VALVE
CUBIC FEET PER HOUR
CEILING
CLEANOUT
CONNECTION
CONTINUATION
CONNECT TO EXISTING
DRINKING FOUNTAIN
DRAWING
ELECTRICAL CONTRACTOR
ELECTRICAL
REMOVE EXISTING
EXISTING TO REMAIN
FLOOR CLEANOUT
FLOOR DRAIN
FINISHED FLOOR ELEVATION
FOOT/FEET
GENERAL CONTRACTOR
GREASE INTERCEPTOR
GALLON PER FLUSH
GALLON PER MINUTE
GAS-FIRED WATER HEATER
HOSE BIBB
INVERT ELEVATION
LAVATORY
LIMIT OF PLUMBING CONTRACT
MINIMUM
NAA VIINI INA

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LEGEND, NOTES AND ABBREVIATIONS

Sheet Number: P-001

									PLU	JMBING FIXTUR	E SCHEDULE					
				2.2-	000 (5) 1000 (5)	NPCW NF	HW S	SAN	N (;)			FIT	TINGS			
TAG NO	TYPE	MANUFACTURER	MODEL	SIZE	CW (in) HW (in)	NPCW NF (in) (HW s	(in)	V (in) FLOW RATE	SUPPLIES	TYPE	MANUFACTURER	MODEL	TRAP	CARRIER	REMARKS
WC-1	WATER CLOSET, ADULT	KOHLER	K-96057	-	1" -	-	-	4"	2" 1.28 GPF	FLUSH VALVE	SELF-POWERED, SENSOR-OPERATED	SLOAN	111 SFSM-1.28	INTEGRAL	FLOOR MOUNTED	PROVIDE TOILET FLANGE, WAX RING AND TOILET FLANGE BOLTS. WAX RING AND BOLT SET AS MANUFACTURED BY HARVEY MFG. SEAT SHALL BE ELONGATED EQUAL TO KOHLER K-4731-GC.
WC-2	WATER CLOSET, TODDLER HEIGHT	KOHLER	K-96064-SS	-	1" -			4"	2" 1.28 GPF	FLUSH VALVE	SELF-POWERED, SENSOR-OPERATED	SLOAN	111 SFSM-1.28	INTEGRAL	FLOOR MOUNTED	PROVIDE TOILET FLANGE, WAX RING AND TOILET FLANGE BOLTS. WAX RING AND BOLT SET AS MANUFACTURED BY HARVEY MFG.
L-1	LAVATORY	KOHLER	K-2031-0	20 ³ ⁄ ₄ " X 18 ¹ ⁄ ₄ "	1/2" 1/2"	-	-	2"	2" 0.50 GPM	½"SWEAT X ¾"COMP. EQUAL TO MCGUIRE LFH170LK	TOUCHLESS, SENSOR OPERATED (AAA BATTERIES)	KOHLER	K-13467-CP	1 ½" x 1 ½" 17GA CAST BRASS CHROME PLATED P-TRAP W/ CO PLUG, EQUAL TO MCGUIRE B8902	WALL MOUNTED	WATER SUPPLY TO FAUCET SHALL NOT EXCEED 110°F, ADJUST THERMOSTATIC MIXING VALVE ACCORDINGLY. PROVIDE PIPE COVERING EQUAL TO TRU BRO LAV GUARD.
L-2	LAVATORY, MAIN BATHROOMS	KOHLER	K-2210	19 1/4"	1/2" 1/2"	-	-	2"	2" 0.50 GPM	½"SWEAT X ¾"COMP. EQUAL TO MCGUIRE LFH170LK	SELF-POWERED, SENSOR-OPERATED	тото	TEL105	1½" x 1½" 17GA CAST BRASS CHROME PLATED P-TRAP W/ CO PLUG, EQUAL TO MCGUIRE B8902	UNDERMOUNTED	WATER SUPPLY TO FAUCET SHALL NOT EXCEED 110°F, ADJUST THERMOSTATIC MIXING VALVE ACCORDINGLY. PROVIDE PIPE COVERING EQUAL TO TRU BRO LAV GUARD.
SK-1	KITCHEN SINK	ELKAY	EAQDUH3118	32 ½" X 18 ½" X 8"	1/2" 1/2"	-	-	2"	2" 1.50 GPM	½"SWEAT X ¾"COMP. EQUAL TO MCGUIRE LFH170LK	SINGLE HANDLE	KOHLER	K-596	1 ½" x 1 ½" 17GA CAST BRASS CHROME PLATED P-TRAP W/ CO PLUG, EQUAL TO MCGUIRE B8902	UNDERMOUNTED	WATER SUPPLY TO FAUCET SHALL NOT EXCEED 110°F, ADJUST THERMOSTATIC MIXING VALVE ACCORDINGLY. PROVIDE PIPE COVERING EQUAL TO TRU BRO LAV GUARD.
DF-1	DRINKING FOUNTAIN	ELKAY	LZS8WSSP	18 ¾" X 19" X 39 ½ ₆ "	1/2" -	-	-	2"	2" -	-	-	-	-	-	-	COORDINATE ELECTRICAL CONNECTION WITH E.C.
MSB-1	MOP SINK	MUSTEE	63M	24" X 24"	3/4" 3/4"	-	-	3"	2" -	-	DUAL HANDLE	MUSTEE	63.600A, 65.700, 65.600	3"DRAIN	FLOOR MOUNTED	PROVIDE WATTS LF009 RPBP ON HW & CW TO SERVE DETERGENT SYSTEM. PROVIDE BUMPER GUARDS AND WALL GUARDS

NOTES: FIXTURE SELECTION SHALL BE CAREFULLY COORDINATED WITH OWNER, AND ARCHITECT. COORDINATE ALL FIXTURE LOCATIONS AND MOUNTING HEIGHTS WITH ARCHITECT AND INTERIOR DESIGNER, PRIOR TO PURCHASE AND INSTALLATION. WATER SUPPLY TO LAVATORY& HAND WASHING FIXTURES SHALL NOT EXCEED 110°F, PROVIDE MIXING VALVE ACCORDINGLY.

					ELECTRIC	C WATER H	HEATER					
		SERVICE /			NUMBER OF	TEMPERATURE		RECOVERY	ELECTR	ICAL REQUI	REMENTS	
TAG NO	TYPE	LOCATION	MANUFACTURER	MODEL	ELEMENTS	SETTING (°F)	STORAGE (GAL)	AT 100°F (GPH)	KW	VOLTS	PH	REMARKS
EWH-1	STORAGE	SECOND FLOOR MECHANICAL ROOM.	A.O. SMITH	DEn-52	2	140	52	24	6.1	208	1	PROVIDE W/ LEAK DETECTION SYSTEM. PROVIDE NON-SIMULTANEOUS OPERATION.
NOTES: WATER	R HEATER SHALL BE B	Y A.O. SMITH, BRADFO	RD WHITE, RHEEM, EEMAX (OR APPROVED EQUAL.								


				Р	UMP SC	HEDULE					
TAG	LOCATION	MANUFACTURER	MODEL	TYPE	FLOW (GPM)	HEAD (FT)		ELEC	TRICAL		COMMENTS
					(01 111)	(11)	VOLT	HP	PHASE	hZ	
CP-1	SECOND FLOOR MECHANICAL ROOM.	GRUNDFOS	MAGNA3	IN-LINE	3	-	115	1/4	1	60	DOMESTIC WATER RECIRCULATION WITH IMMERSION AQUASTAT

TAG NO	MANUFACTURER	MODEL	CAPACITY (GAL.)	REMARKS
ET-1	WATTS	PLT-5		PROVIDE W/ VALVE AND UNION ON INLET. PROVIDI REQUIRED SUPPORT/STRAP AND SECURE TO WALL. SHALL VERIFY EACH UNIT'S WATER SUPPLY PRESSU AND ADJUST EXPANSION TANK ACCORDINGLY PER MANUFACTURER'S INSTRUCTIONS

		FLOOR	DRAINAGE SCH	IEDULE	
TAG	DESIGNATION	MANUFACTURER	MODEL	OUTLET	COMMENTS
FD-A	FLOOR DRAIN	WATTS	FD-100-A-6	3"	LOCATED IN TOILET ROOMS. PROVIDE TRAP PRIMER CONNECTION, VANDAL ROOF. LOCATE BENEATH PARTITIONS OUTSIDE OF WALKING PATHS.
FD-B	FLOOR DRAIN	J.R SMITH	2120-P050-U-B	3"	PROVIDE TRAP PRIMER, SEDIMENT BUCKET, VANDAL ROOF. LOCATED IN WATER ROOM

TAG	DESIGNATION	MANUFACTURER	MODEL	COMMENTS
TP-1	UNDER SINK TRAP PRIMER	PRECISION PLUMBING PRODUCTS	PRO1-ULP500	MOUNT ON COLD WATER SUPPLY TO LAVATORY
TP-2	MECHANICAL TRAP PRIMER	PRECISION PLUMBING PRODUCTS	PRO1-500	PROVIDE DISTRIBUTION UNIT AS NECESSARY
TP-3	MECHANICAL TRAP PRIMER	PRECISION PLUMBING PRODUCTS	P2-500	-

		HOSE	BIBB SCH	EDULE
TAG	LOCATION	MANUFACTURER	MODEL	COMMENTS
<u>HB</u>	INTERIOR	ZURN	Z1341-BFP	EXPOSED, ANTI-SIPHON WALL FAUCET WITH BACKFLOW PREVENTER

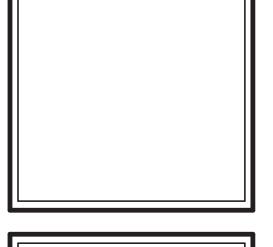



STRUCTURAL ENGINEER:
Shelley Engineering
MEP ENGINEER:
BLW Engineers
INTERIOR DESIGNER:


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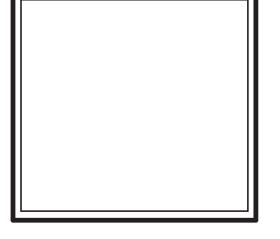
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Shelley Engineering
MEP ENGINEER:
BLW Engineers
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Services
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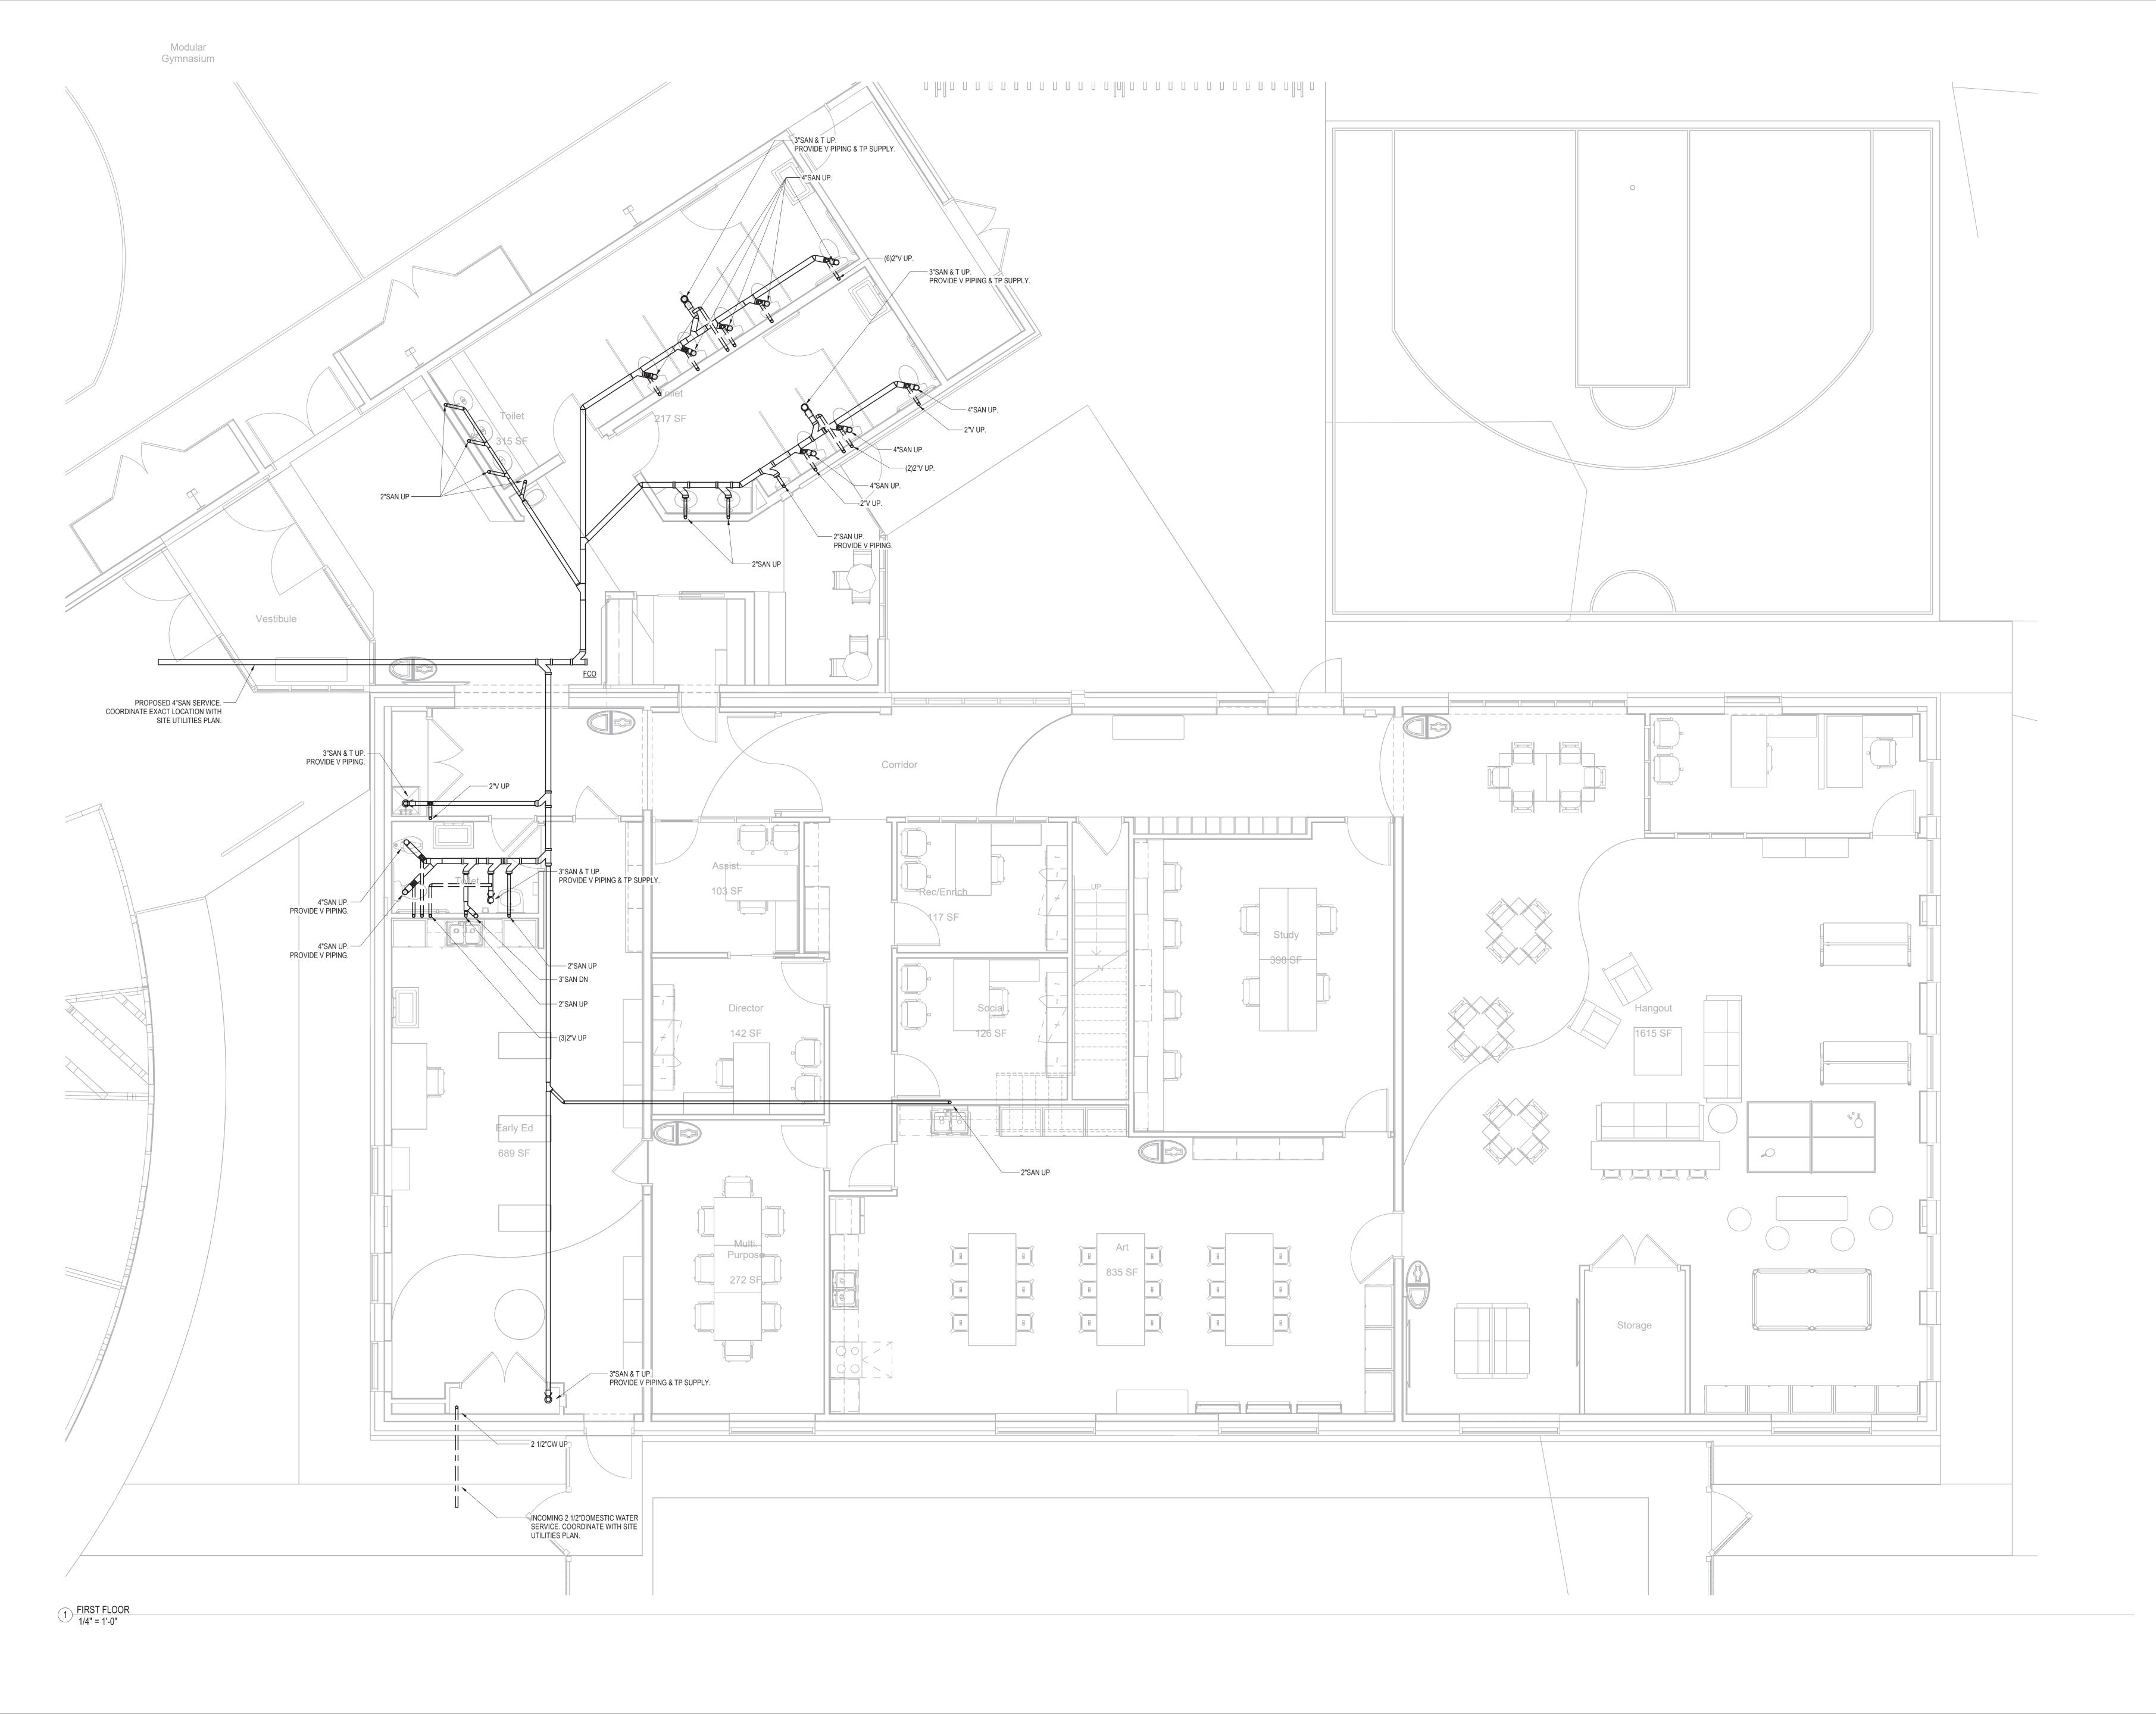
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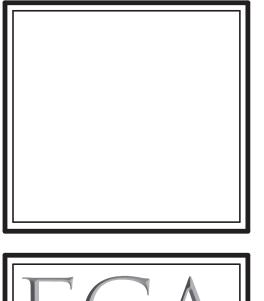
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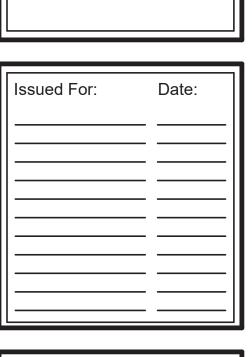








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MEP ENGINEER:
BLW Engineers
INTERIOR DESIGNER:
WDC Interiors


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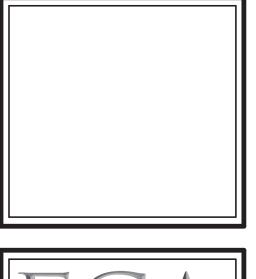


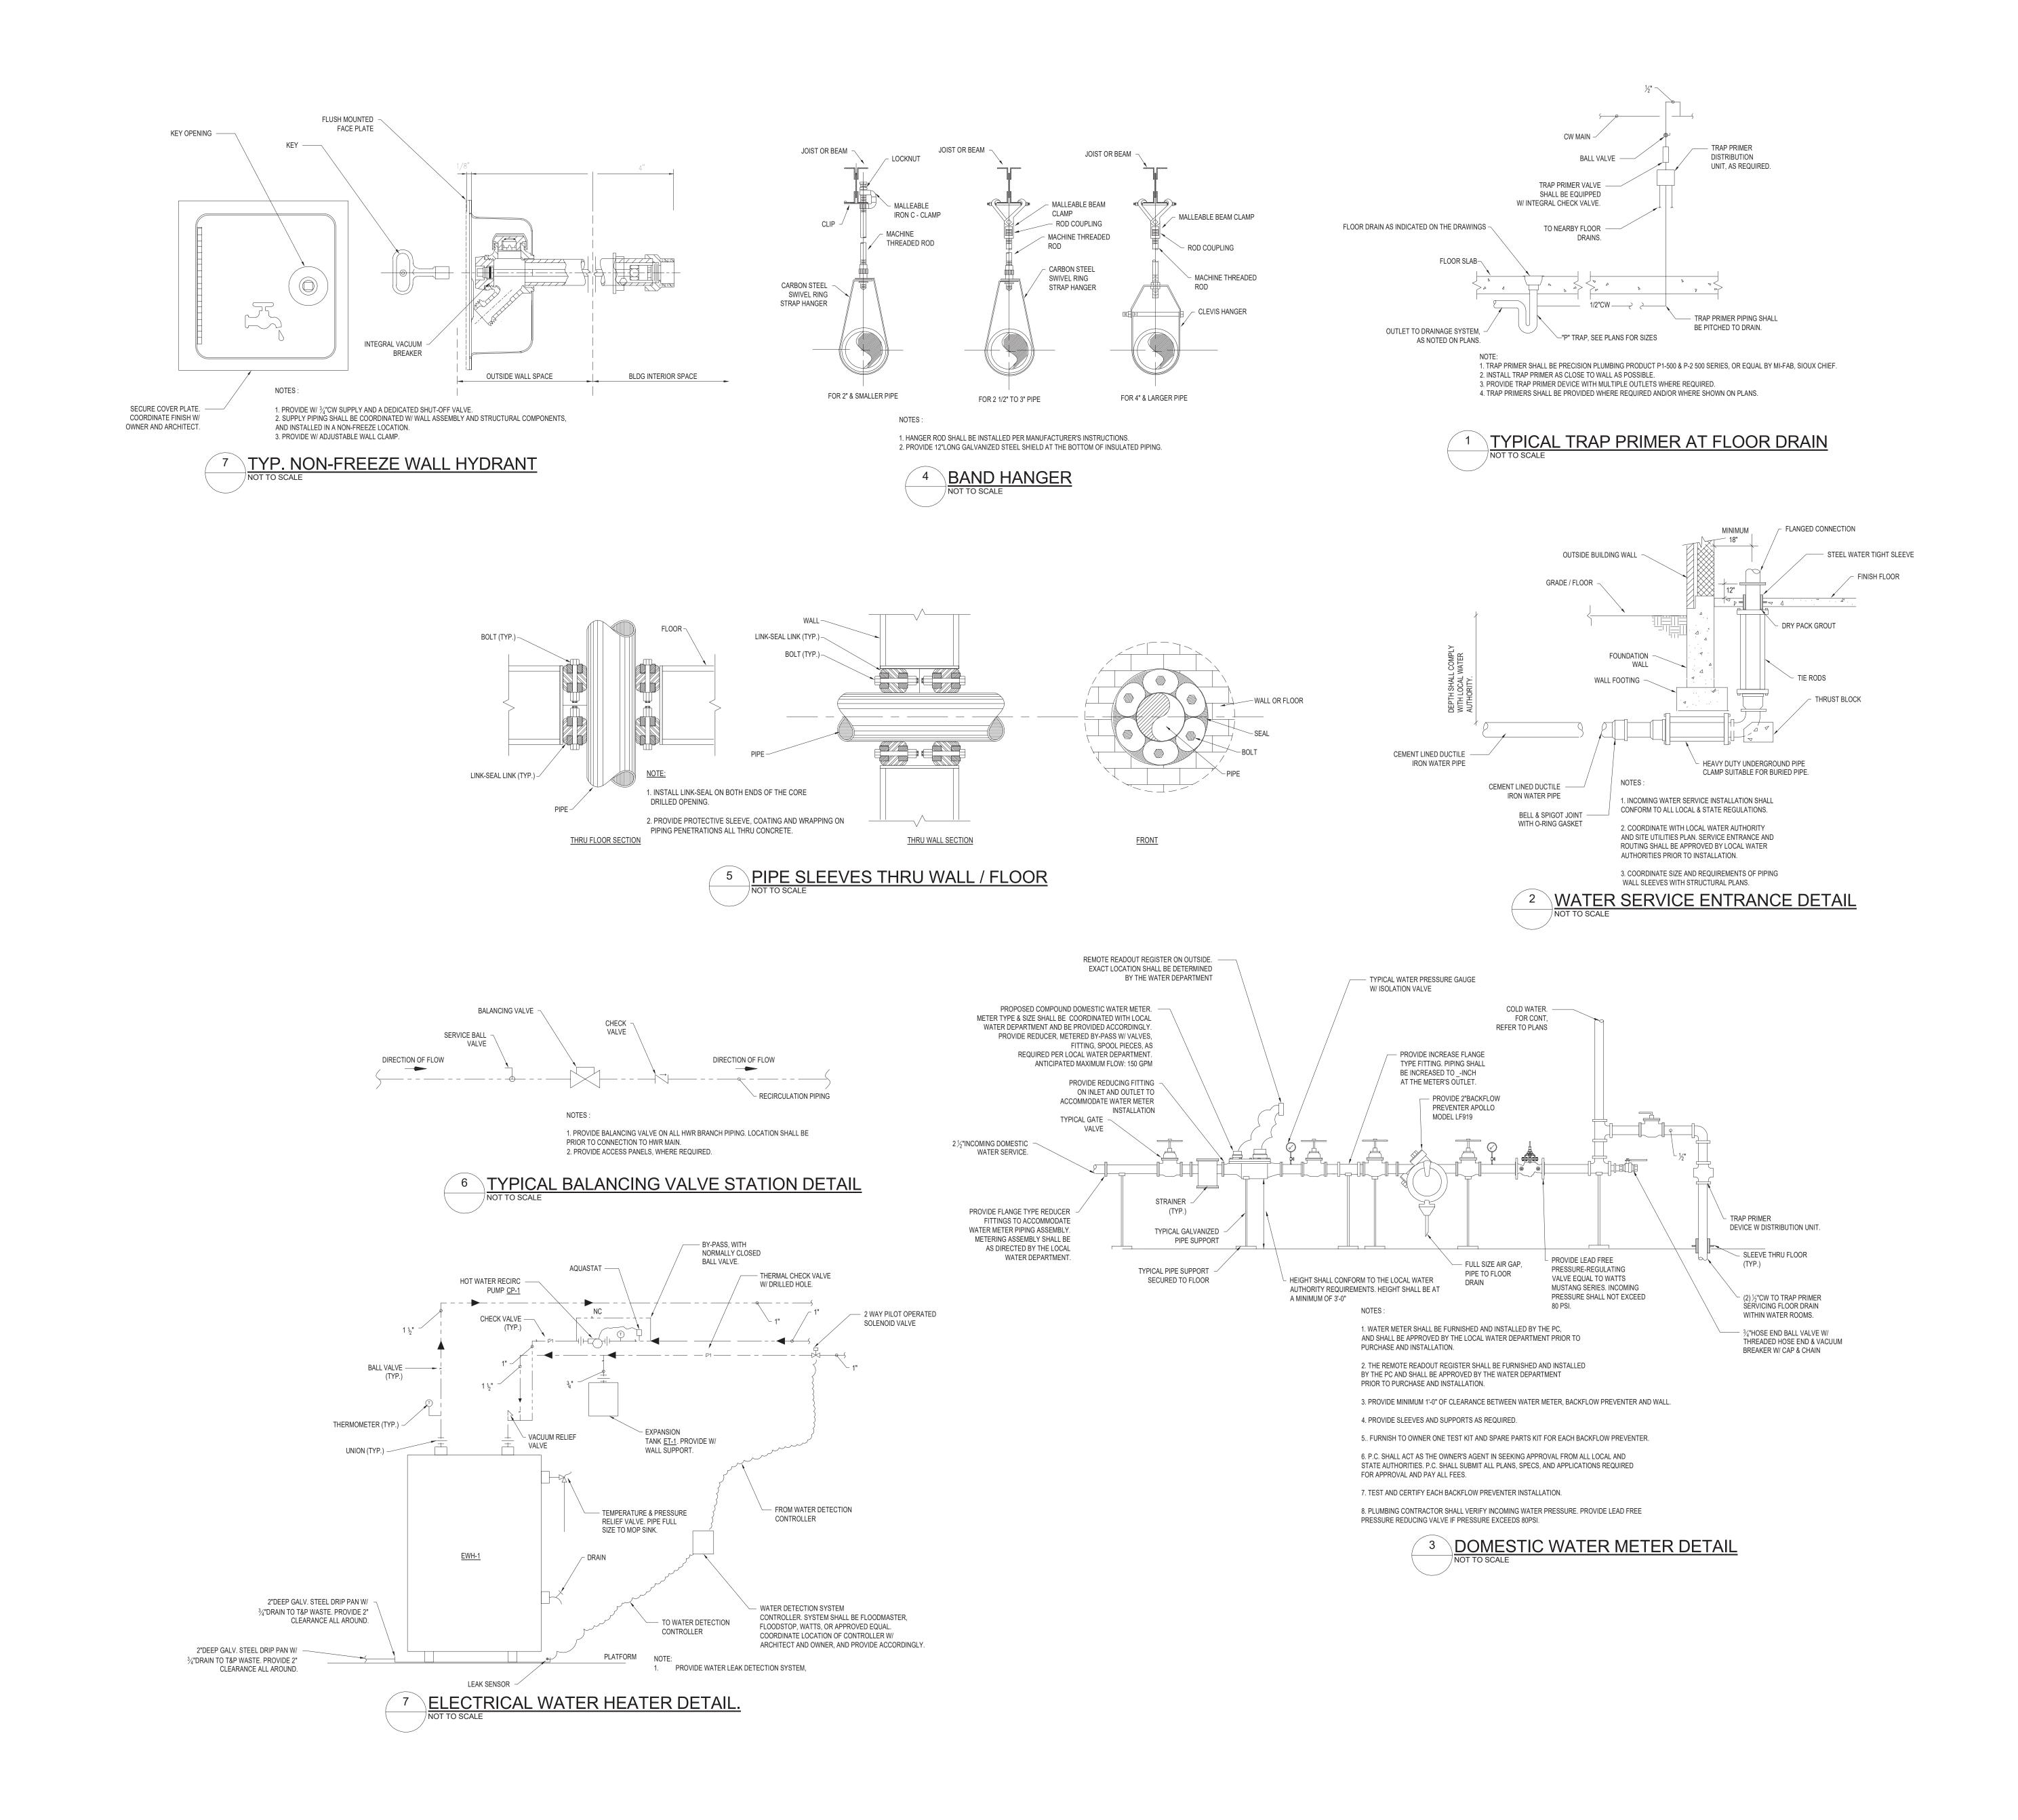

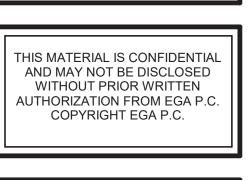
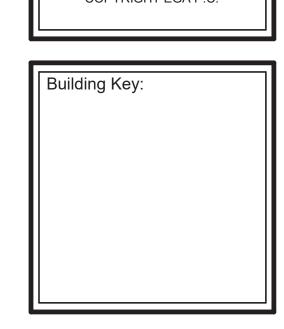
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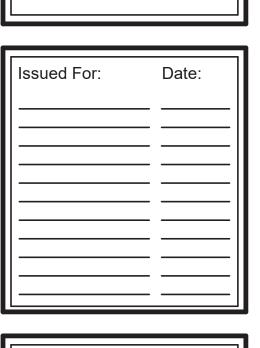





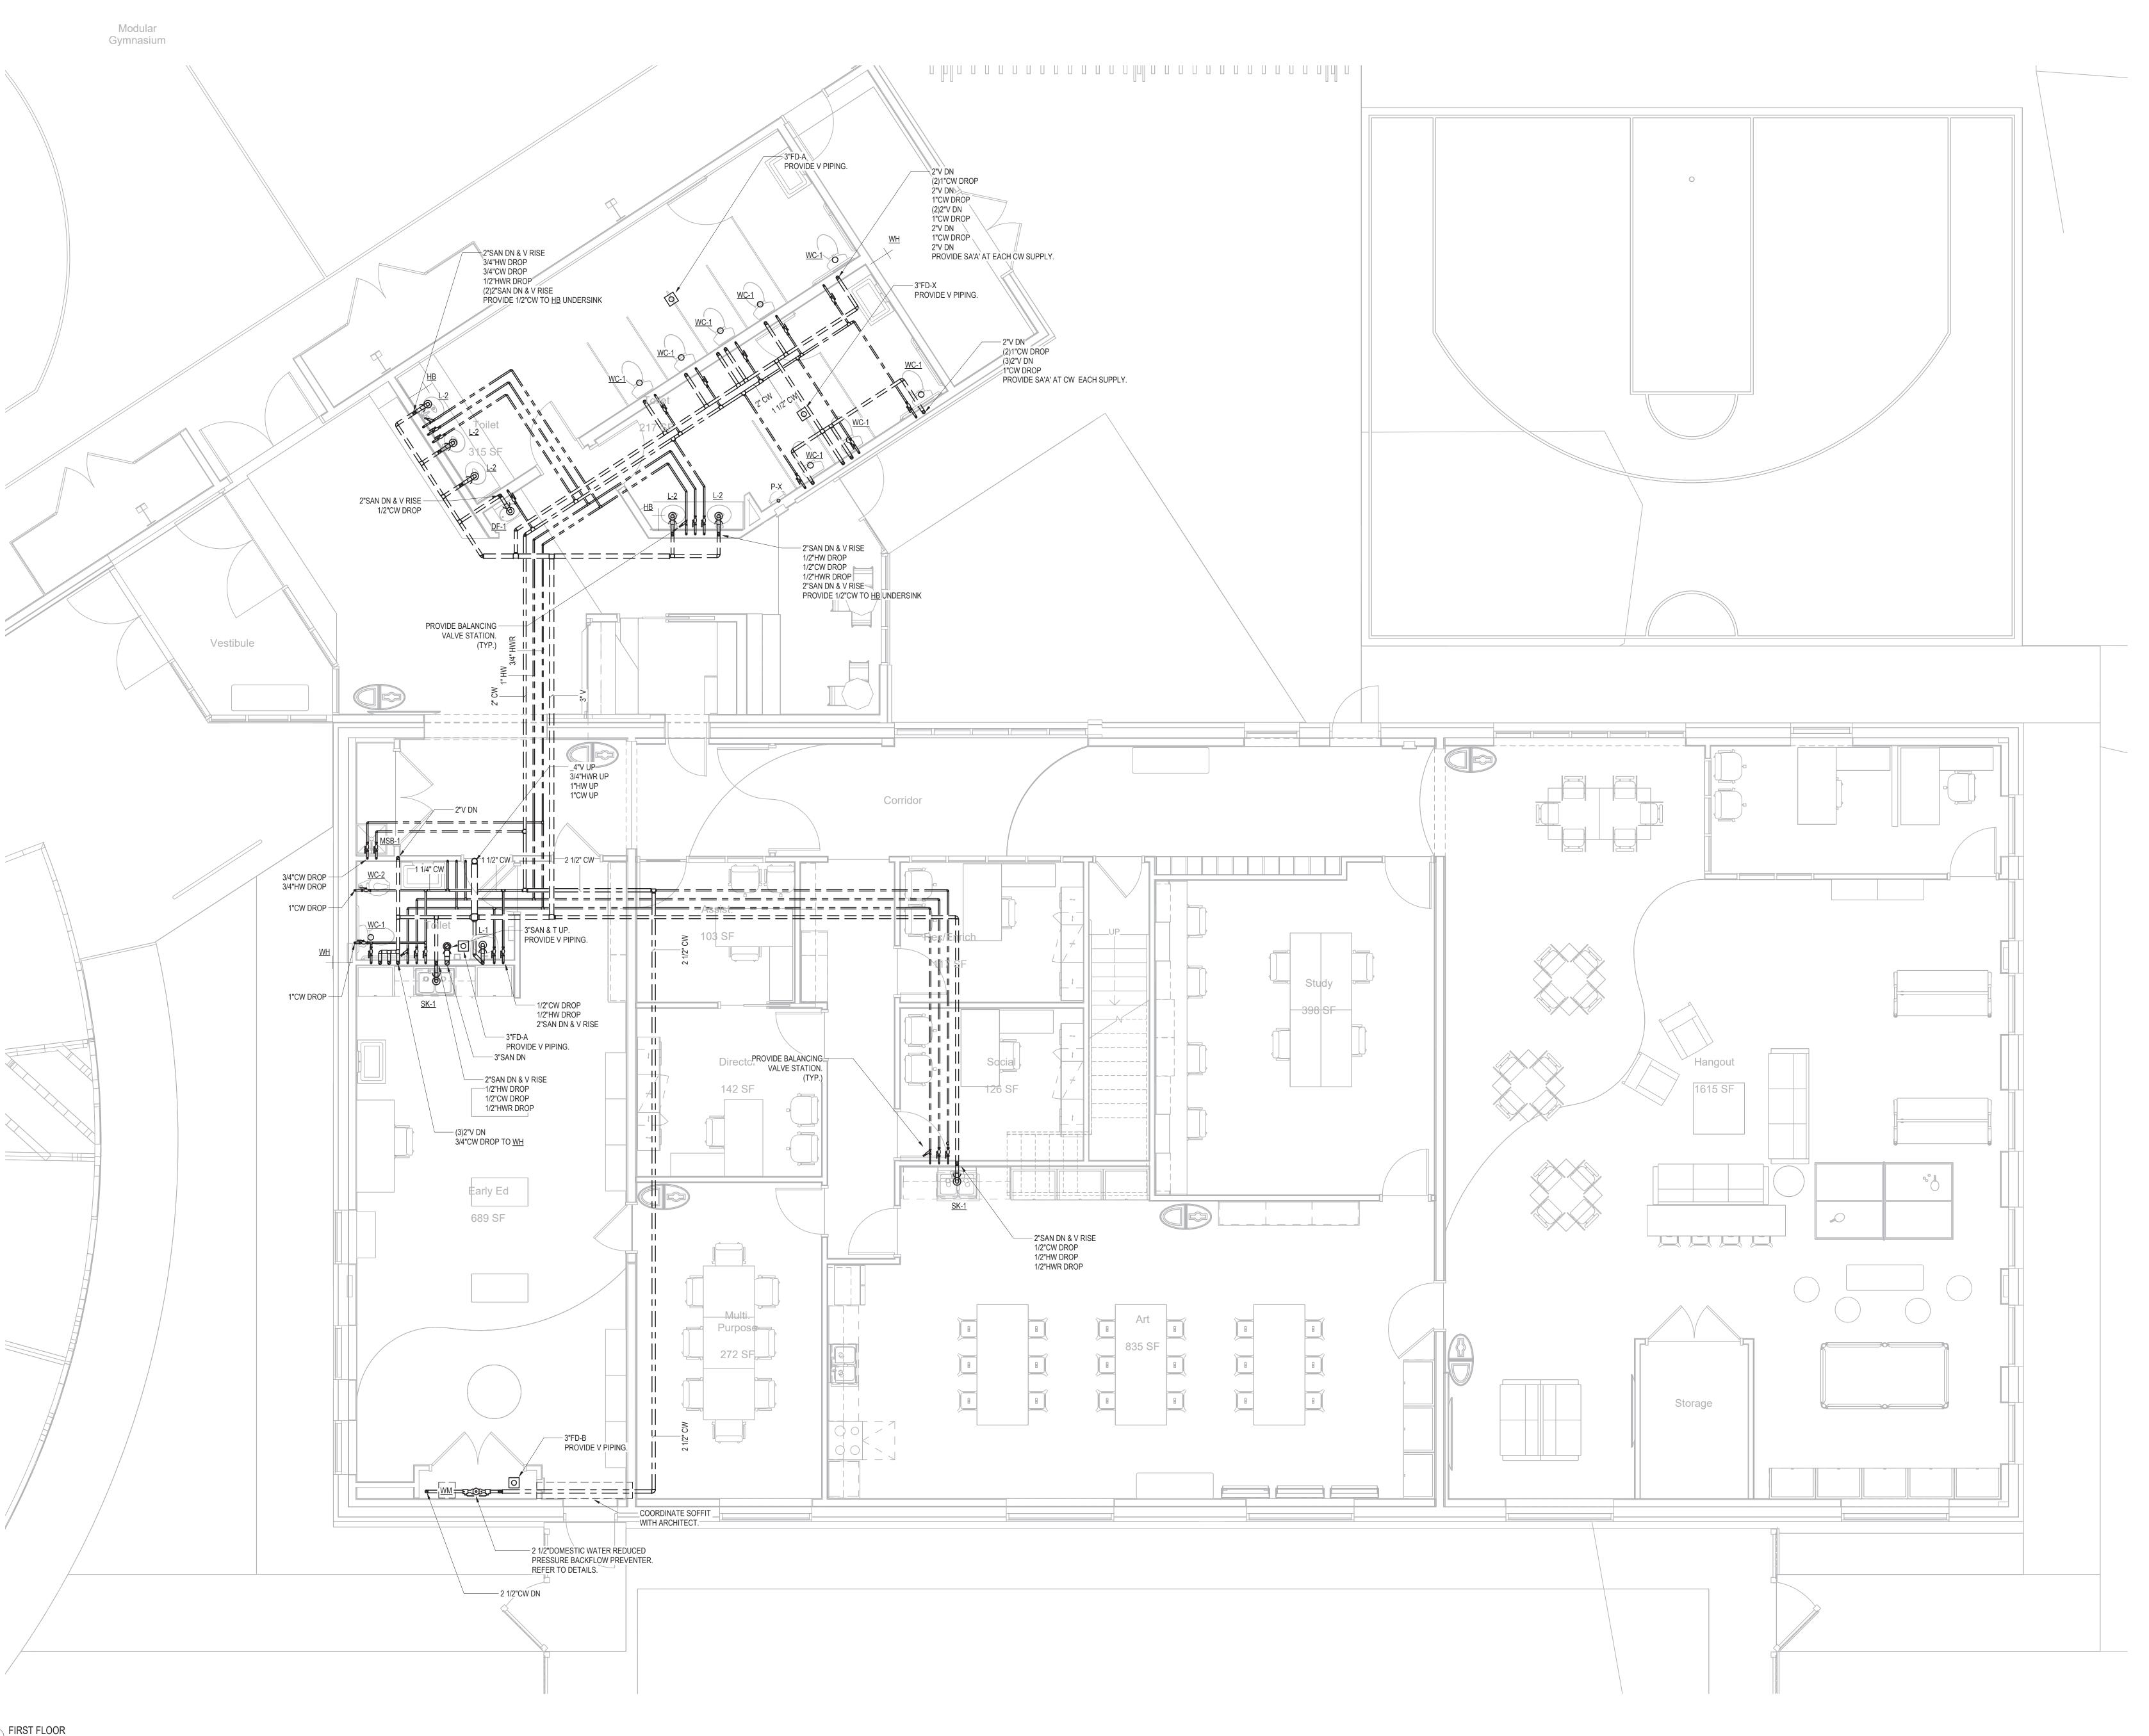


STRUCTURAL ENGINEER:
Shelley Engineering
MEP ENGINEER:
BLW Engineers
INTERIOR DESIGNER:

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Newburyport, MA 01950



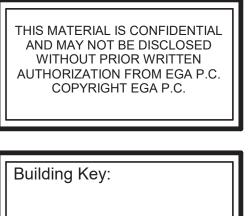

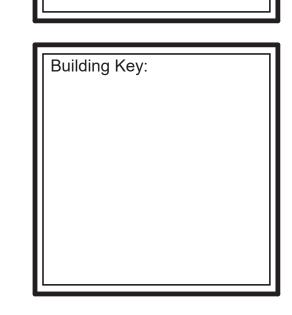



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FIRST FLOOR
PLAN

Sheet Number:


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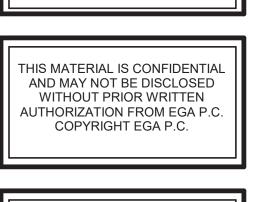



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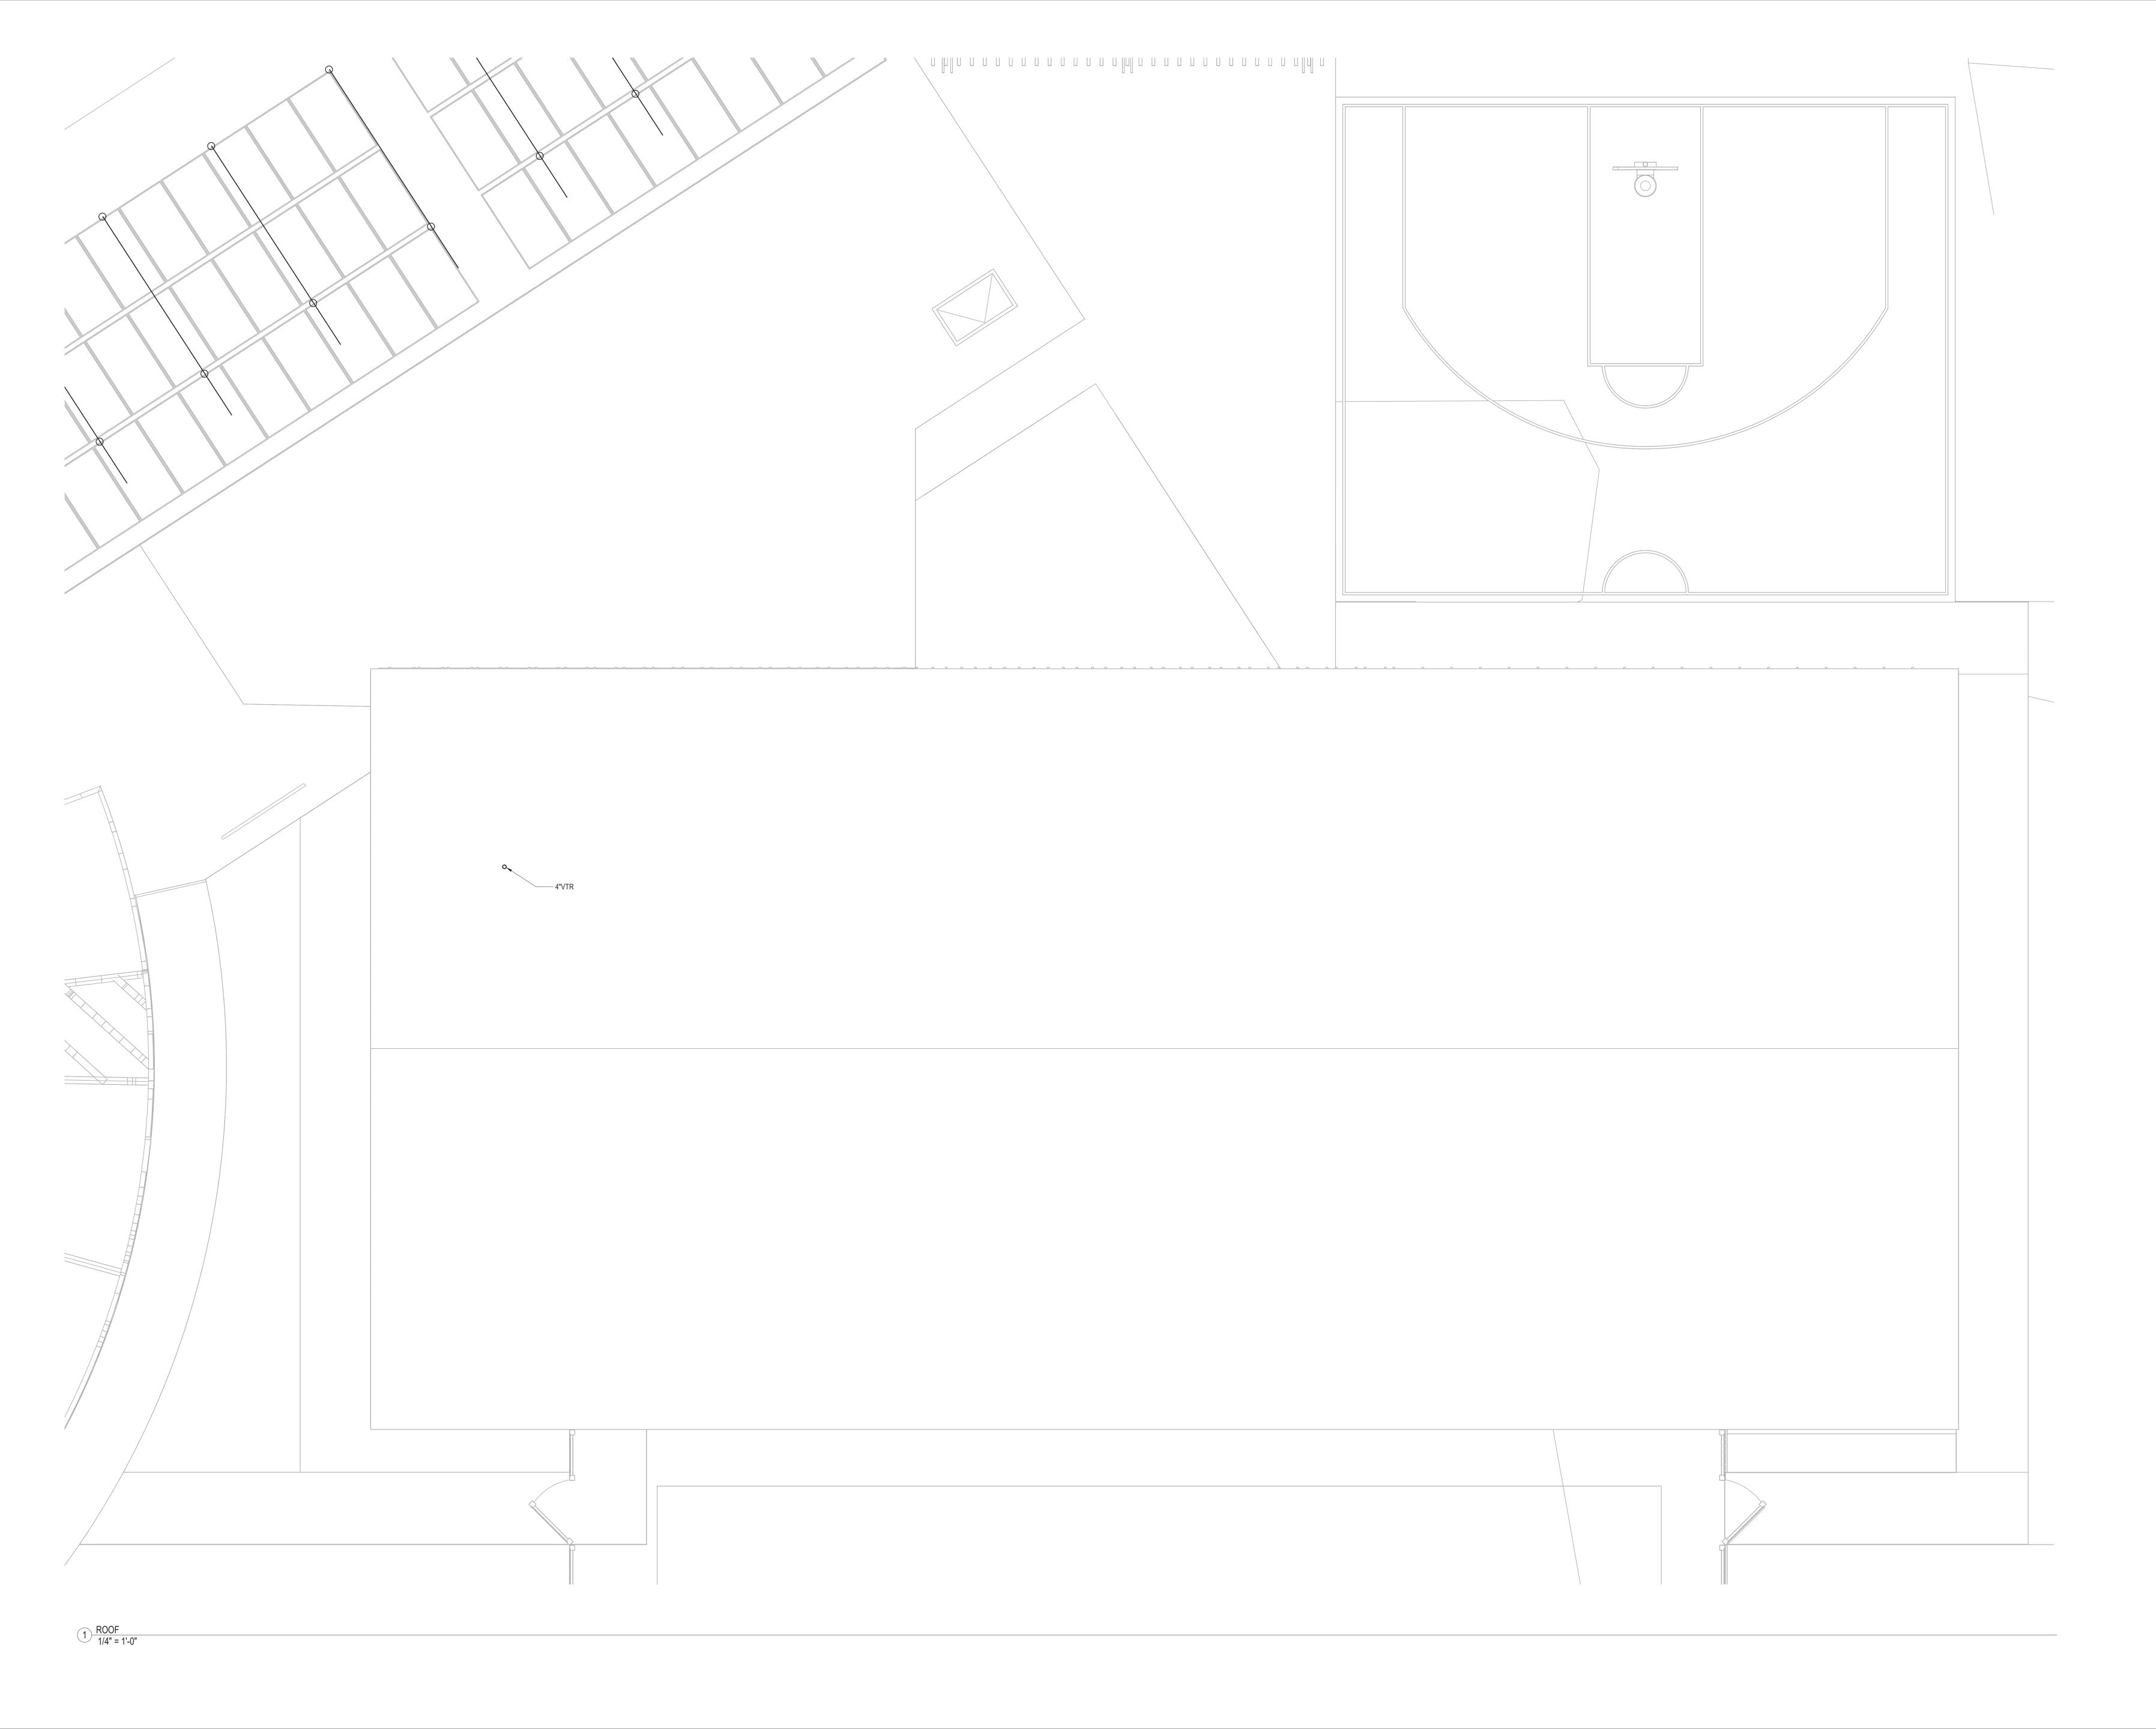

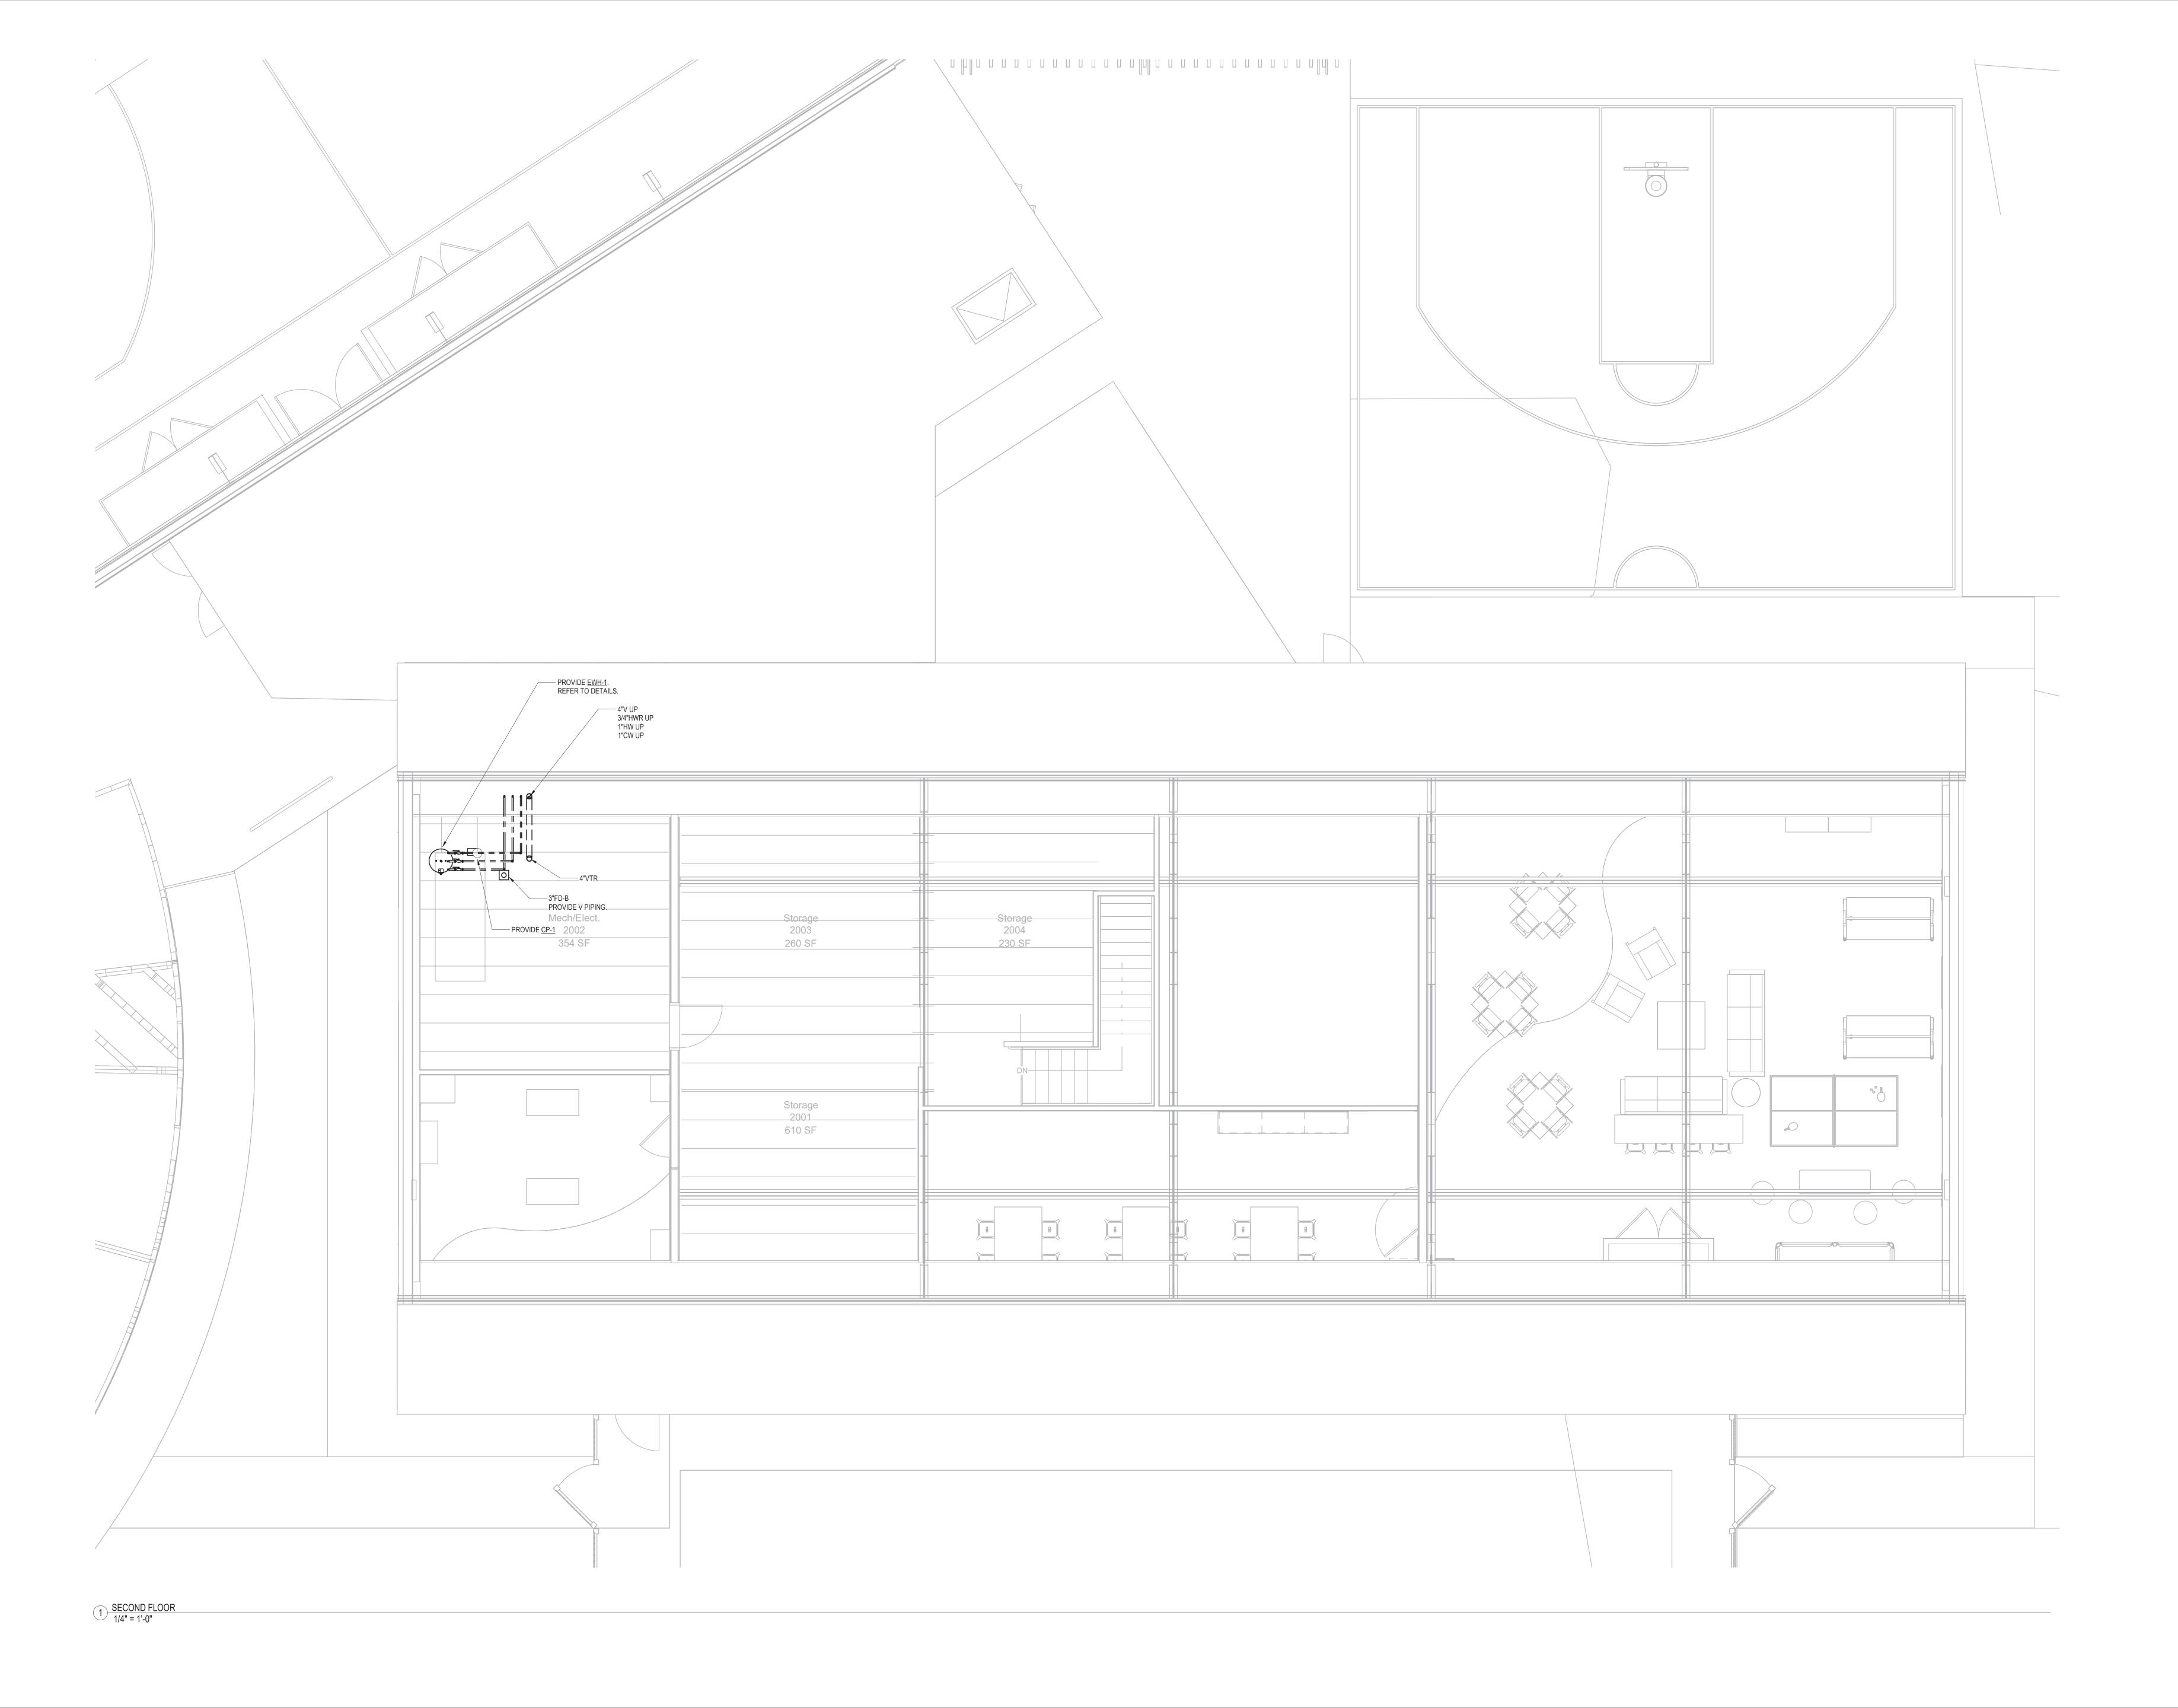
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	SECOND FLOOR PLAN
	Sheet Number: P-103

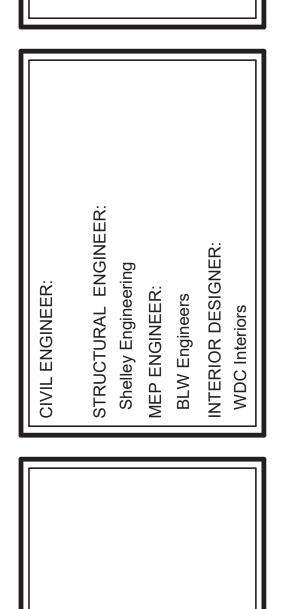

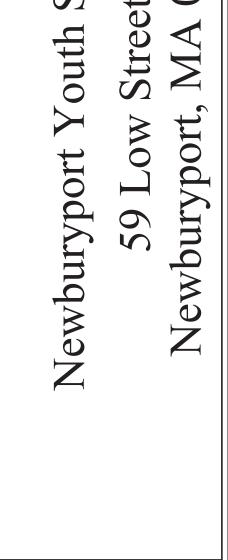

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ROOF PLAN	
heet Number:	
P-104	

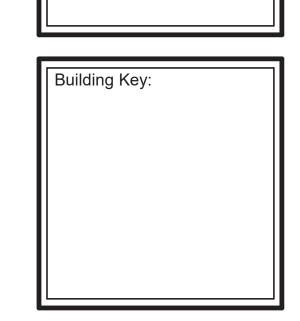- ALL FIRE PROTECTION SYSTEMS SHALL BE SEISMICALLY BRACED ACCORDING
 TO THE APPLICABLE SECTIONS OF THE MASSACHUSETTS STATE BUILDING CODE LATEST EDITION AND
- 2. ALL FIRE PROTECTION SYSTEMS, EQUIPMENT AND PIPING SHALL BE DESIGNED, INSTALLED AND TESTED BY A SPRINKLER CONTRACTOR LICENSED AND EXPERIENCED IN THE STATE OF MASSACHUSETTS
- 3. ALL WORK PERFORMED SHALL CONFORM TO THE APPLICABLE SECTIONS OF THE MASSACHUSETTS STATE BUILDING CODE AND NFPA 13 LATEST ACCEPTED EDITIONS AS
- WELL AS ALL RULES AND REGULATIONS OF THE AUTHORITY HAVING JURISDICTION.
- 4. ALL PIPING IN EXPOSED AREAS SHALL BE OF A TYPE SUITABLE FOR PAINTING ALL PIPING SHALL BE RUN CONCEALED WHEREVER POSSIBLE

IN THE DESIGN, INSTALLATION AND TESTING OF STANDARD SPRINKLER SYSTEMS.

- 5. CONTRACTOR SHALL PROVIDE FIRESTOPPING FOR ALL PENETRATIONS THRU FIRE WALLS AND FIRE RATED SEPARATIONS.
- 6. ALL SPRINKLER PIPING AND HEADS ARE SHOWN DIAGRAMMATICALY. CONTRACTOR SHALL COORDINATE WITH ALL OTHER TRADES BEFORE WORK BEGINS TO INSURE THAT NO INTERFERENCE'S
- EXIST AND THAT ALL COMPONENTS OF THE SPRINKLER SYSTEM WILL FIT INTO THE SPACE. 7. CONTRACTOR SHALL COORDINATE WITH THE MECHANICAL AND ELECTRICAL DRAWINGS FOR LOCATIONS OF DUCTWORK, DIFFUSERS AND LIGHT FIXTURES. CONTRACTOR SHALL
- COORDINATE WITH THE ARCHITECTURAL DRAWINGS FOR CEILINGS, CEILING SPACES AND ROOMS.
- 8. CONTRACTOR SHALL FURNISH, INSTALL AND MAINTAIN ALL SCAFFOLDING, HOISTING EQUIPMENT AND DERRICKS NECESSARY FOR INSTALLATION OF WORK
- 9. THE DRAWINGS SHALL NOT BE USED BY THE CONTRACTOR AS SPRINKLER SYSTEM SHOP DRAWINGS. THE CONTRACTOR SHALL PRODUCE A COMPLETE SET OF WORKING FIRE PROTECTION SYSTEM SHOP DRAWINGS IN ACCORDANCE WITH NFPA 13. THE SYSTEM SHALL BE HYDRAULICALLY CALCULATED PER THE DESIGN CRITERIA PROVIDED AND REQUIRED. ALL DRAWINGS
- AND CALCULATIONS SHALL BE STAMPED AND SIGNED BY THE CONTRACTORS REGISTERED FIRE PROTECTION ENGINEER AND SHALL BE SUBMITTED TO THE LOCAL FIRE DEPARTMENT FOR APPROVAL AND PERMIT. THIS SHALL BE DONE PRIOR TO THE COMMENCEMENT OF ANY SPRINKLER WORK. AN ADDITIONAL SET OF PLANS AND
- CALCULATIONS AS DESCRIBED ABOVE SHALL BE SUBMITTED TO THE LOCAL BUILDING DEPARTMENT FOR APPROVAL PRIOR TO THE COMMENCEMENT OF ANY SPRINKLER WORK.
- PLANS AND HYDRAULIC CALCULATIONS AS DESCRIBED ABOVE SHALL ALSO BE SUBMITTED TO THE OWNERS INSURANCE AUTHORITY AND THE ARCHITECT FOR APPROVAL PRIOR TO THE COMMENCEMENT OF ANY SPRINKLER WORK.
- ALL DRAWING SUBMITTALS SHALL INCLUDE COMPLETE SYSTEM RISER DIAGRAMS. ALL SUBMITTALS SHALL INCLUDE MANUFACTURERS ORIGINAL CATALOG DATA AND DESCRIPTIVE INFORMATION FOR ALL MAJOR COMPONENTS OF THE EQUIPMENT TO BE SUPPLIED.
- ALL DRAWING SUBMITTALS SHALL INDICATE ALL CONTROL VALVES, SUPERVISORY AND ALARM SWITCHES, ALL TEST AND DRAIN VALVES.
- NO FIRE PROTECTION SYSTEMS PIPE FABRICATION OR ANY INSTALLATION WORK AT THE SITE SHALL BEGIN UNTIL THE SPRINKLER CONTRACTOR HAS SUBMITTED THE SPRINKLER CONTRACTORS ENGINEERED SHOP DRAWINGS AND HYDRAULIC CALCULATIONS AND ALL SUPPORTING MATERIAL, ALL AS DESCRIBED ABOVE, TO THE LOCAL FIRE DEPARTMENT AUTHORITY FOR PERMIT, THE BUILDING DEPARTMENT AND THE OWNERS INSURANCE AUTHORITY FOR APPROVAL. THE SPRINKLER CONTRACTOR SHALL OBTAIN THE PERMIT AND WRITTEN APPROVALS FROM THE ABOVE LISTED AUTHORITIES PRIOR TO THE COMMENCEMENT OF ANY WORK ASSOCIATED WITH THE FIRE PROTECTION SYSTEMS.
- 10. PROVIDE WIRE CAGE GUARD PROTECTION FOR ALL SPRINKLER HEADS INSTALLED IN MECHANICAL ROOMS AND UTILITY CLOSETS UNLESS CONCEALED TYPE HEADS ARE USED
- 11. THE DRAWINGS ARE NOT INTENDED TO SHOW EXACT SPRINKLER HEADS LOCATIONS, NUMBER OF SPRINKLER HEADS, OR THE EXACT ROUTING OF PIPING. THIS SHALL BE THE RESPONSIBILITY OF THE CONTRACTOR. THE CONTRACTOR SHALL COORDINATE WITH THE ARCHITECTURAL DRAWINGS FOR ALL CEILING TYPES
- 12. CONTRACTOR SHALL PROVIDE A KNOX BOX IN AN ACCESSIBLE AND VISIBLE LOCATION. TYPE AND LOCATION OF THE
- 13. SPRINKLER CONTRACTOR SHALL PROVIDE ALL CUTTING AND PATCHING IN ORDER TO ACCOMMODATE THE SPRINKLER WORK.
- 14. THE CONTRACTOR SHALL MAKE REASONABLE CHANGES TO THE SPRINKLER HEAD LOCATIONS AS A RESULT OF THE COORDINATION WITH THE MECHANICAL AND ELECTRICAL DRAWINGS AND AT NO EXTRA COST TO THE CONTRACT.
- 15. THE TERM "CONTRACTOR" SHALL MEAN "SPRINKLER CONTRACTOR"

KNOX BOX SHALL BE APPROVED BY THE LOCAL FIRE DEPARTMENT.

- 16. THE CONTRACTOR SHALL PROVIDE A FIRE DEPARTMENT PERSONNEL STAFFED "FIRE WATCH" DURING ALL WELDING OPERATIONS.
- 17. THE FIRE DEPARTMENT CONNECTION TYPE AND LOCATION SHALL BE APPROVED BY THE LOCAL FIRE DEPARTMENT PRIOR TO PURCHASE AND INSTALLATION
- 18. ALL ABOVE AND BELOW GROUND PIPING SYSTEMS SHALL BE FLUSHED IN ACCORDANCE WITH NFPA-13 AND NFPA-24. NO CONNECTION OF THE ABOVE GROUND PIPING SYSTEMS SHALL BE MADE UNTIL ALL BELOW GROUND PIPING HAS BEEN FLUSHED AND FLUSHING REPORTS HAVE BEEN FILLED OUT AND SIGNED. FLUSHING REPORTS OF THE SITE WATER MAINS SHALL BE OBTAINED BY THE SPRINKLER CONTRACTOR FROM THE SITE CONTRACTOR SHOWING FLUSHING OF THE SITE WATER MAINS BEFORE ANY CONNECTIONS TO THE BUILDING FIRE
- 19. THE SPRINKLER CONTRACTOR SHALL PROVIDE A MINIMUM OF 48 HOURS ADVANCE NOTICE TO THE LOCAL FIRE DEPARTMENT PRIOR TO THE FINAL SPRINKLER SYSTEMS ACCEPTANCE TEST. THE FINAL ACCEPTANCE TEST SHALL BE WITNESSED BY THE LOCAL FIRE DEPARTMENT. ANY DEFECTS FOUND DURING THE ACCEPTANCE TEST SHALL BE REPAIRED BY THE SPRINKLER CONTRACTOR AND THE ENTIRE SPRINKLER SYSTEM RETESTED AS DESCRIBED ABOVE. THIS SHALL BE REPEATED UNTIL THE SPRINKLER SYSTEM IS FREE OF ALL DEFECTS AND THE ENTIRE SPRINKLER SYSTEM IS ACCEPTED BY THE LOCAL FIRE DEPARTMENT.
- 20. THE SPRINKLER CONTRACTOR SHALL COORDINATE WITH THE LOCAL FIRE DEPARTMENT FOR A MINIMUM OF TWO SPRINKLER SYSTEMS INSPECTIONS, ONE PRIOR TO THE CEILING ROUGH INSTALLATION AND ONE AFTER FINISH CEILINGS HAVE BEEN INSTALLED
- 21. THE SPRINKLER CONTRACTOR SHALL PROVIDE THE LOCAL FIRE DEPARTMENT WITH A COPY OF THE SPRINKLER SYSTEMS TEST RESULTS
- 22. THE SPRINKLER CONTRACTOR SHALL COORDINATE WITH THE LOCAL FIRE DEPARTMENT FOR ALL REQUIREMENTS FOR APPROVAL AND ACCEPTANCE OF THE SPRINKLER SYSTEMS AND DESIGN DRAWINGS, PRIOR TO THE COMMENCEMENT OF ANY SPRINKLER DESIGN OR INSTALLATION WORK
- 23. THE SPRINKLER CONTRACTOR SHALL CAREFULLY COORDINATE THE INSTALLATION OF ALL PIPING, VALVES AND EQUIPMENT IN THE SPRINKLER ROOM WITH THE PLUMBING CONTRACTOR TO INSURE THAT BOTH TRADES FIT INTO THE SPACE WITHOUT INTERFERENCE.
- 24. THE SPRINKLER CONTRACTOR SHALL PROVIDE ALL SPRINKLER HEADS WITH FACTORY APPLIED COLOR FINISHES TO MATCH THAT OF THE FINISH OF THE CEILING OR WALL THAT THE SPRINKLER HEAD IS BEING INSTALLED INTO. THE SPRINKLER CONTRACTOR SHALL COORDINATE WITH THE ARCHITECT FOR ALL CEILING TYPES AND FINISHES PRIOR TO PURCHASE AND INSTALLATION OF THE SPRINKLER HEADS.
- 25. ALL SPRINKLER HEADS WITHIN DWELLING AREAS SHALL BE LISTED RESIDENTIAL SPRINKLERS. ALL SPRINKLER HEADS OUTSIDE OF DWELLING AREAS SHALL BE LISTED QUICK RESPONSE TYPES.
- 26. ALL FIRE DEPARTMENT CONNECTIONS AND FIRE DEPARTMENT HOSE VALVES SHALL BE APPROVED BY THE FIRE DEPARTMENT PRIOR TO PURCHASE
- 27. THE SPRINKLER CONTRACTOR SHALL PROVIDE SIGNAGE AT ALL FIRE DEPARTMENT CONNECTIONS. THE CONTRACTOR SHALL COORDINATE WITH THE FIRE DEPARTMENT FOR ACCEPTABLE SIGNAGE TYPES AND TERMINOLOGIES.
- 28. THE SPRINKLER CONTRACTOR SHALL PROVIDE ALL SPRINKLER HEAD SUPPLY DROPS OR SPRIG UP RISERS TO AND INCLUDING FINAL CONNECTION OF ALL SPRINKLER HEADS


29. THE CONTRACTOR SHALL BE RESPONSIBLE FOR DETERMINING ALL AREAS OF HYDRAULIC CALCULATIONS BASED ON NFPA-13 AS APPLICABLE

- 30. REMOTE DESIGN AREAS ARE NOT SHOWN ON THE DRAWINGS. IT SHALL BE THE RESPONSIBILITY OF THE SPRINKLER CONTRACTOR TO SELECT ALL DESIGN AREAS AND
- DESIGN DENSITIES AS WELL AS THE NUMBER OF SPRINKLER HEADS IN ALL AREAS OF OPERATION THAT WILL BE USED TO CREATE THE SPRINKLER CONTRACTORS SHOP DRAWINGS AND HYDRAULIC CALCULATIONS. ALL DESIGN AREAS, DESIGN DENSITIES AND THE NUMBER OF OPERATING SPRINKLER HEADS SHALL BE SELECTED BY THE SPRINKLER CONTRACTOR IN ACCORDANCE WITH NFPA-13. HYDRAULIC CALCULATIONS SHALL BE PERFORMED FOR EVERY BUILDING REQUIRING SPRINKLER COVERAGE.
- 31. THE DRAWINGS ARE NOT INTENDED TO SHOW ALL FIRE RATED SEALS THRU RATED FLOORS AND WALLS. THE SPRINKLER CONTRACTOR SHALL BE RESPONSIBLE FOR COORDINATING WITH THE ARCHITECTURAL DRAWINGS FOR ALL FIRE RATED FLOORS AND WALL AND SHALL PROVIDE A FIRE RATED SEAL FOR EACH AND EVERY PIPE PENETRATION THRU EACH AND EVERY FIRE RATED FLOOR OR WALL.
- 32. PRIOR TO THE SPRINKLER SYSTEMS DESIGN, THE SPRINKLER CONTRACTOR SHALL CONDUCT A HYDRANT FLOW TEST IN ORDER TO OBTAIN CURRENT FLOW AND PRESSURE DATA AND SHALL USE THIS NEWLY OBTAINED DATA TO PERFORM HIS HYDRAULIC CALCULATIONS FOR THE SPRINKLER SYSTEM SHOP DRAWINGS DESCRIBED IN NOTE 9 ABOVE. THE HYDRANT FLOW TEST SHALL BE CONDUCTED IN ACCORDANCE WITH NFPA-13. THE CONTRACTOR SHALL COORDINATE WITH THE LOCAL WATER AUTHORITY FOR THE FLOW TEST.
- THE SPRINKLER CONTRACTOR SHALL PROVIDE ALL LABOR, EQUIPMENT, MATERIALS, PAY ALL FEES AND PERFORM ALL COORDINATION WITH THE LOCAL WATER AUTHORITY FOR THE HYDRANT FLOW TEST. 33. THE FIRE PROTECTION CONTRACTOR SHALL CREATE A SCALE DRAWING FOR THE BUILDING SHOWING THE LOCATIONS OF ALL BACKFLOW PREVENTION DEVICES AND DETAILS OF EACH OF THEIR INSTALLATION METHODS. THE FIRE PROTECTION CONTRACTOR SHALL ALSO OBTAIN MANUFACTURER CUT SHEETS OF ALL BACKFLOW
- PREVENTION DEVICES AND SHALL INDICATE THE SIZES AND MODEL NUMBERS BEING USED. THE FIRE PROTECTION CONTRACTOR SHALL SUBMIT THESE DRAWINGS AND CUT SHEETS TO THE LOCAL WATER DEPARTMENT AUTHORITY FOR APPROVAL. NO BACKFLOW PREVENTION DEVICE SHALL BE INSTALLED UNTIL WRITTEN APPROVAL OF ALL BACKFLOW PREVENTION DEVICES HAS BEEN OBTAINED BY THE FIRE PROTECTION CONTRACTOR FROM THE LOCAL WATER DEPARTMENT AUTHORITY. THE FIRE PROTECTION CONTRACTOR SHALL BE RESPONSIBLE FOR REGISTERING ALL BACKFLOW PREVENTION DEVICES WITH THE LOCAL WATER DEPARTMENT AS WELL AS THE MASSACHUSETTS D.E.P.
- 34. THE FIRE PROTECTION DRAWINGS ARE NOT INTENDED TO SHOW ANY CEILING CONDITIONS, LIGHT FIXTURES, HVAC DIFFUSERS OR ANY EQUIPMENT OR DEVICES LOCATED IN THE CEILINGS. I'HE SPRINKLER CONTRACTOR SHALL OBTAIN ARCHITECTURAL CEILING PLANS, ELECTRICAL PLANS AND HVA'C PLANS AND SHALL COORDINATE THE SPRINKLER HEAD LOCATIONS WITH ALL CEILING TYPES, LIGHT FIXTURES, HVAC DIFFUSERS AND ALL DEVICES AND EQUIPMENT THAT WILL BE LOCATED IN THE CEILINGS. THE SPRINKLER CONTRACTOR SHALL ADJUST THE LOCATIONS OF THE SPRINKLER HEADS SHOWN ON THE FIRE PROTECTION DRAWINGS AS REQUIRED TO COORDINATE WITH THE CEILING CONDITIONS. THESE ADJUSTMENTS SHALL BE MADE AT NO EXTRA
- 35. ALL SPRINKLER HEADS SHALL BE LOCATED IN THE CENTER OF CEILING TILES UNLESS OTHERWISE DIRECTED BY THE ARCHITECT.
- 36. THE FIRE PROTECTION DRAWINGS ARE NOT INTENDED TO SHOW ANY CEILING CONDITIONS, CEILING GRIDS, CEILING TILES, LIGHT FIXTURES, HVAC DIFFUSERS OR ANY OTHER CEILING DETAILS. THE SPRINKLER CONTRACTOR SHALL OBTAIN THE CEILING PLANS, THE LIGHT FIXTURE LOCATIONS AND HVAC DIFFUSER LOCATIONS FROM THE ARCHITECT. THE SPRINKLER CONTRACTOR SHALL USED THIS INFORMATION TO LAYOUT THE LOCATIONS OF ALL SPRINKLER HEADS AND SHALL MAKE WHATEVER ADJUSTMENTS TO THE FIRE PROTECTION DRAWINGS NECESSARY TO ACCOMMODATE THE THE ACTUAL CEILING CONDITIONS. THESE ADJUSTMENTS SHALL BE MADE AT NO EXTRA COST TO THE CONTRACT.


SPECIFICATIONS

- 1. CONCEALED PENDENT AND UPRIGHT SPRINKLER HEADS SHALL BE QUICK RESPONSE, BRASS/CHROME FINISH, 1/2" ORIFICE, 5.6K FACTOR. TEMPERATURE RATINGS OF THE SPRINKLER HEADS SHALL BE IN ACCORDANCE WITH NFPA-13.
- 2. ALL NEW SPRINKLER HEADS, PIPING AND FITTINGS SHALL BE UL LISTED AND FM APPROVED, AND SHALL BE RATED AT 175 PSI WORKING PRESSURE. SPRINKLER HEADS SHALL BE BY VIKING, TYCO, RELIABLE, OR
- 3. ALL ABOVE GROUND PIPING 1-INCH AND SMALLER SHALL BE SCHEDULE 40 BLACK STEEL WITH THREADED FITTINGS. ALL ABOVE GROUND PIPING LARGER THAN 1 1/4-INCH SHALL BE SCHEDULE 10 OR 40 BLACK STEEL WITH GROOVED OR THREADED FITTINGS. ALL DRAIN PIPING SHALL BE SCHEDULE 40 HOT DIPPED GALVANIZED WITH THREADED FITTINGS. CPVC PIPE AND FITTINGS ARE APPROVED FOR LIGHT HAZARD AND RESIDENTIAL
- 4. THE CONTRACTOR SHALL BE RESPONSIBLE FOR CUTTING AND PATCHING ALL CEILINGS AND WALL AS REQUIRED FOR INSTALLATION OF SPRINKLER SYSTEMS. ALL CEILINGS AND WALLS SHALL BE PATCHED TO THE OWNER / ARCHITECT'S SATISFACTION.
- 5. ALL HANGERS SHALL BE SUPPORTED FROM THE BUILDING STRUCTURE. ALL HANGERS AND RODS SHALL BE HOT DIPPED GALVANIZED. BAND TYPE HANGERS SHALL BE USED FOR SIZES 3-INCH AND SMALLER. CLEVIS TYPE HANGERS SHALL BE USED FOR PIPE SIZES 4-INCH AND LARGER. RODS SIZES SHALL CONFORM TO
- 6. ALL SPRINKLER WORK SHALL BE TESTED IN ACCORDANCE WITH NFPA 13 LATEST ACCEPTED EDITION. THE TEST SHALL BE WITNESSED BY THE LOCAL FIRE DEPARTMENT, THE OWNER REPRESENTATIVE, THE OWNER'S INSURANCE AUTHORITY. THE CONTRACTOR SHALL PROVIDE THE EQUIPMENT, COORDINATION AND
- NOTIFICATION OF ALL APPLICABLE AUTHORITIES FOR THE SPRINKLER PIPING TEST. 7. ALL FIRE PROTECTION SYSTEMS AND EQUIPMENT SHALL BE BY VIKING, GRINNEL OR VICTAULIC.
- 8. ALL WATERTIGHT SLEEVES, AND FIRE RATED SLEEVES SHALL BE BY LINKSEAL. ALL SLEEVES SHALL BE GALVANIZED STEEL FOR OUTDOOR OR UNDERGROUND APPLICATIONS, AND BLACK STEEL FOR INDOOR
- 9. ALL SPRINKLER SYSTEMS SHALL BE DESIGNED, INSTALLED IN ACCORDANCE WITH NFPA-13 LATEST ACCEPTED
- 10. ALL SPRINKLER HEADS SHALL BE LOCATED IN THE CENTER OF THE CEILING TILES WHERE TILES ARE USED. COORDINATE WITH ARCHITECTURAL PLANS, FOR ALL CEILING TYPES AND CONDITIONS, AND OTHER TRADES.

		FLOW DATA
HYDRAULIC CALCULATIONS I ON THE FOLLOWING MINIMUI		IS BEEN BASED
STATIC PRESSURE	XXX	PSI
RESIDUAL PRESSURE	XXX	PSI
FLOW	XXX	GPM
SHALL PERFORM A NEW HYE SHALL USE HIS NEWLY OBTA SYSTEMS DESIGN. THE HYDI CONTRACTOR SHALL PROVII	ORANT FLOW TEST TO NINED FLOW AND PRE RANT FLOW TEST SH. DE ALL LABOR, MATE	ED BY THE SPRINKLER CONTRACTOR AND THE SPRINKLER CONTRACTOR O OBTAIN CURRENT FLOW AND PRESSURE DATA. THE SPRINKLER CONTRACTOR ESSURE DATA TO PERFORM HIS HYDRAULIC CALCULATIONS FOR THE SPRINKLER ALL BE PERFORMED IN ACCORDANCE WITH NFPA-13. THE SPRINKLER RIALS, EQUIPMENT, PAY ALL FEES AND PERFORM ALL COORDINATION R TO PERFORM THE HYDRANT FLOW TEST.
	GENER	AL DESIGN CRITERIA
OFFICES, CLASSROOMS, GY LIGHT HAZARD .10 GPM/SQFT PER 1,500 SQ 100 GPM HOSE STREAM ALL ALL SPRINKLER HEADS USE	UARE FEET OWANCE	QUICK RESPONSE TYPE

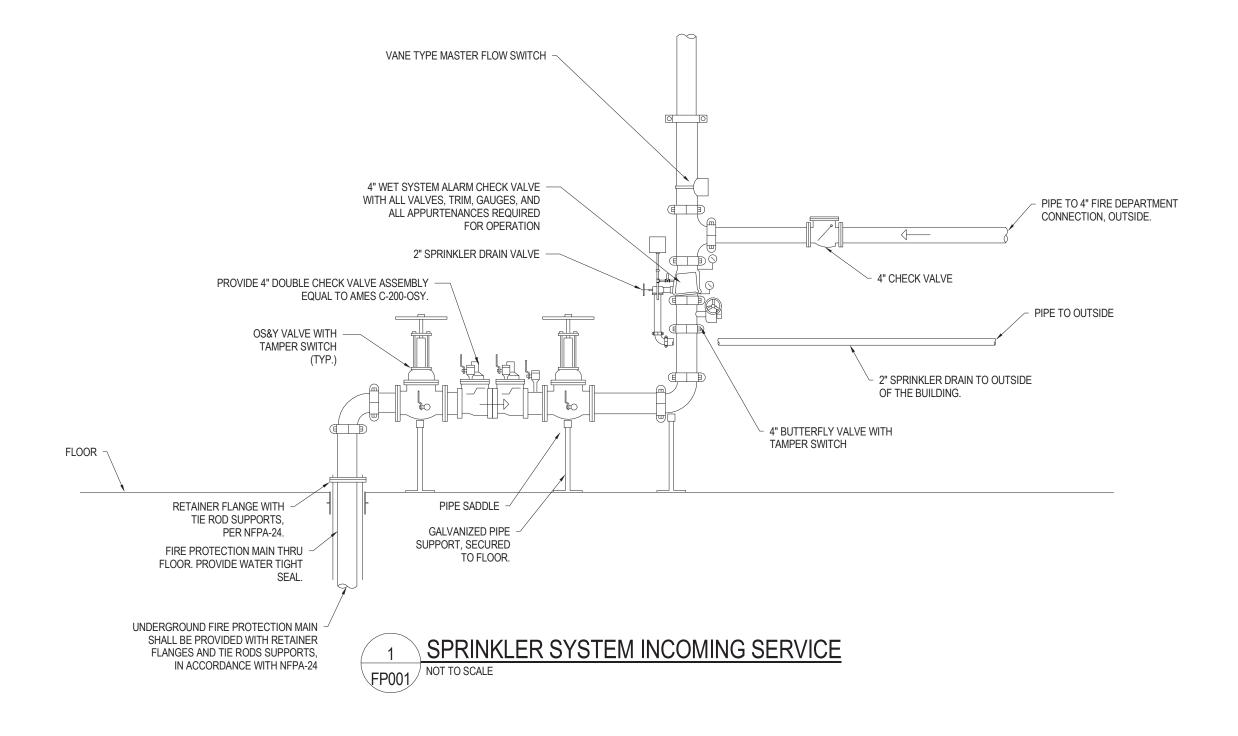



		WET SYSTEM ALARM CHECK VALVE AND RISER
F		UNDERGROUND FIRE PROTECTION MAIN - BUILDING SERVICE
		WET PIPE SYSTEM SPRINKLER PIPING ABOVE FLOOR
——— FDC ———	FDC	FIRE DEPARTMENT CONNECTION PIPING
DCBP	DCBP	DOUBLE CHECK VALVE BACKFLOW PREVENTER
\leftrightarrow	FDC	FIRE DEPARTMENT CONNECTION. TYPE AND LOCATION AS DIRECTED BY THE LOCAL FIRE DEPARTMENT
		ELECTRIC ALARM BELL
0		SPRINKLER HEAD - BRASS UPRIGHT - ORDINARY TEMPERATURE - QUICK RESPONSE TYPE
•		SPRINKLER HEAD - CONCEALED PENDENT- ORDINARY TEMPERATURE - QUICK RESPONSE TYPE
FCVA	FCVA	FLOOR CONTROL VALVE ASSEMBLY
		CHECK VALVE
		ELBOW UP OR RISE
		ELBOW DOWN OR DROP

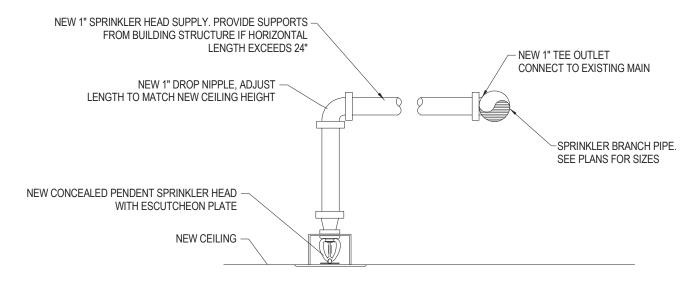

- 1. ALL CONCEALED SPRINKLER HEAD COVER PLATES SHALL COME COMPLETE WITH FACTORY APPLIED FINISH TO MATCH THAT OF THE CEILINGS TO WHICH THE SPRINKLER HEADS ARE BEING INSTALLED. THE SPRINKLER CONTRACTOR SHALL COORDINATE WITH THE ARCHITECTURAL DRAWINGS FOR ALL CEILING FINISHES AND SHALL ORDER THE SPRINKLER HEADS ACCORDINGLY
- 2. THE SPRINKLER CONTRACTOR SHALL SUBMIT ALL CONCEALED SPRINKLER HEAD COVER PLATE FINISHES TO THE ARCHITECT FOR APPROVAL PRIOR TO PURCHASE AND INSTALLATION OF ANY SPRINKLER HEADS




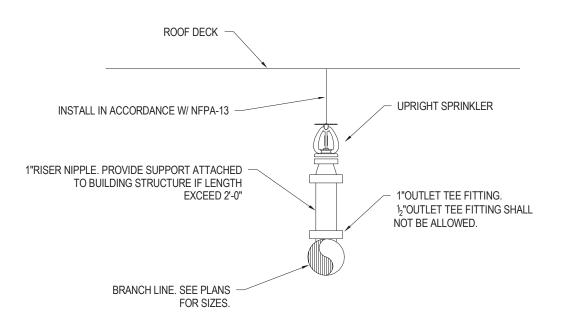

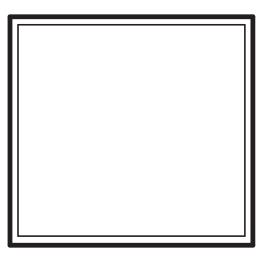



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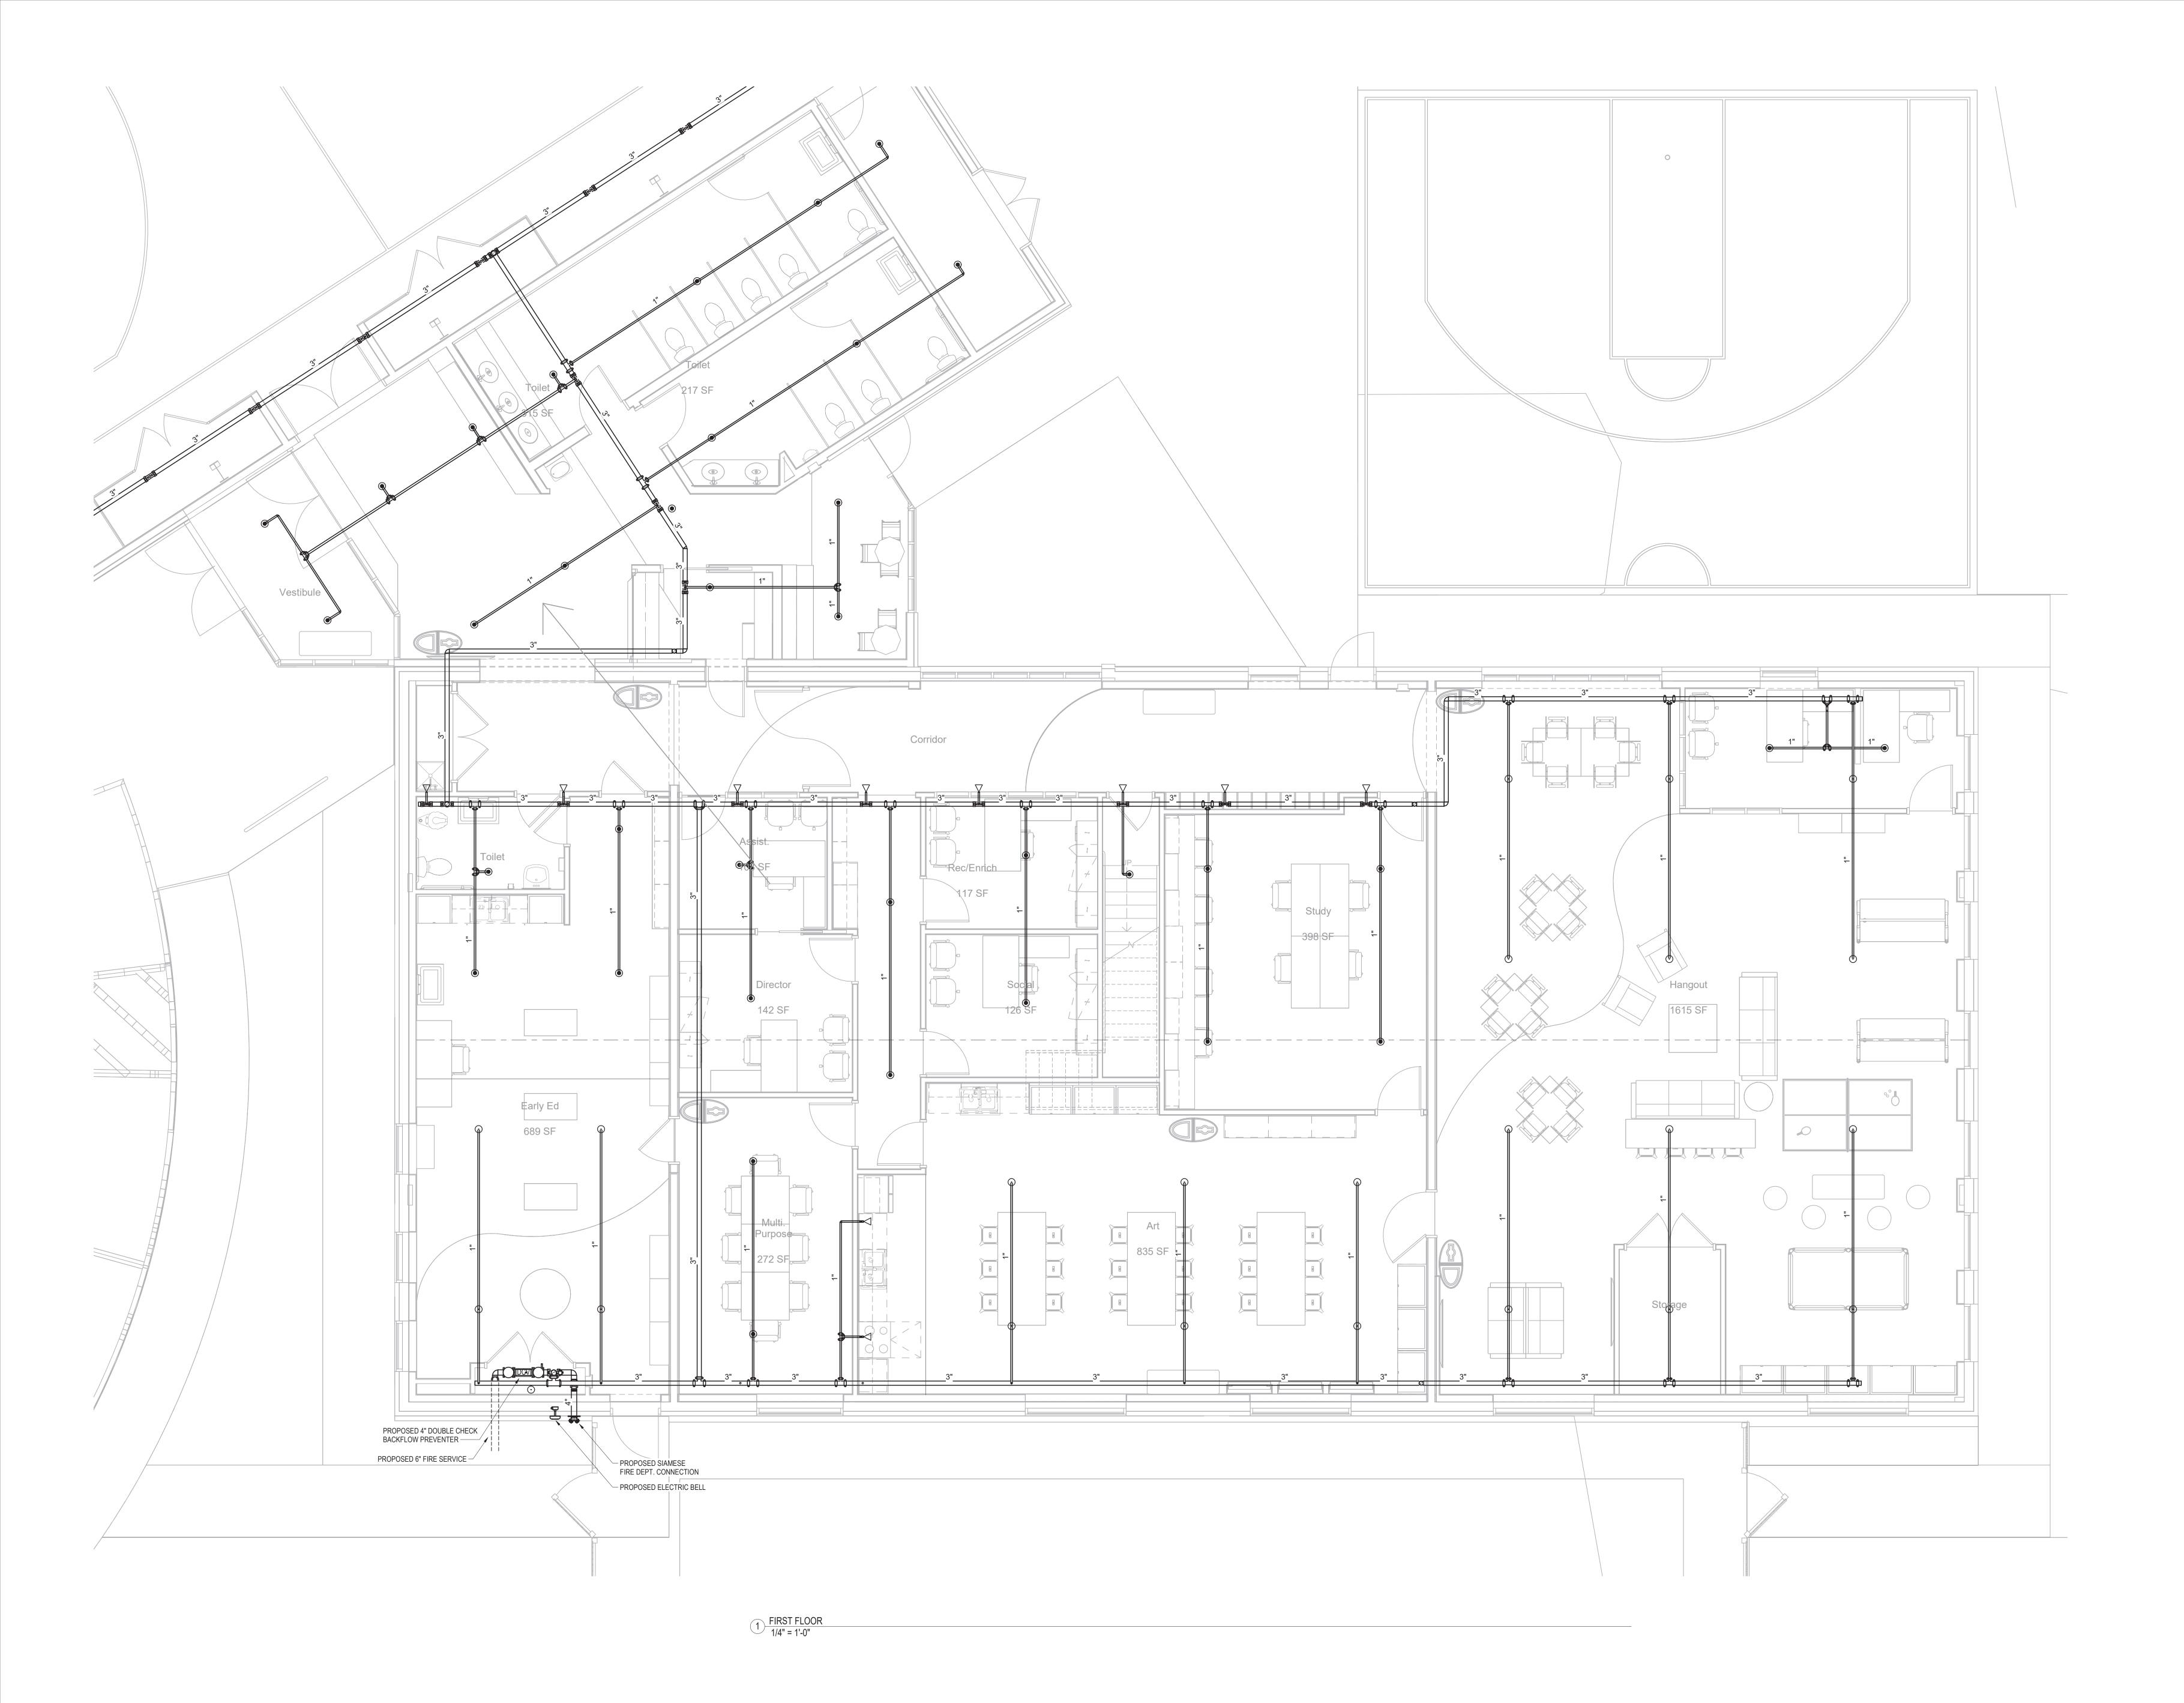


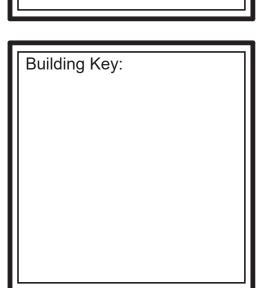
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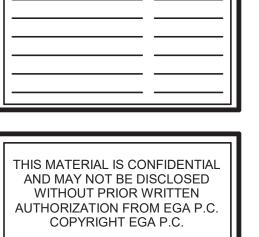







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Structural Shelley Engine MEP ENGINEE
BLW Enginee BLW Enginee MDC Interiors


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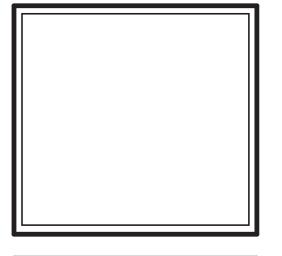


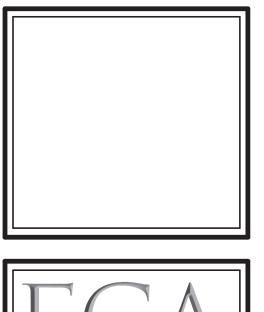

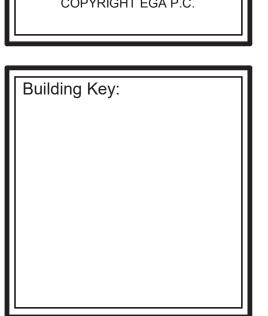Sheet Title:
FIRE PROTECTION
FIRST FLOOR PLAN

Sheet Number:
FP-101



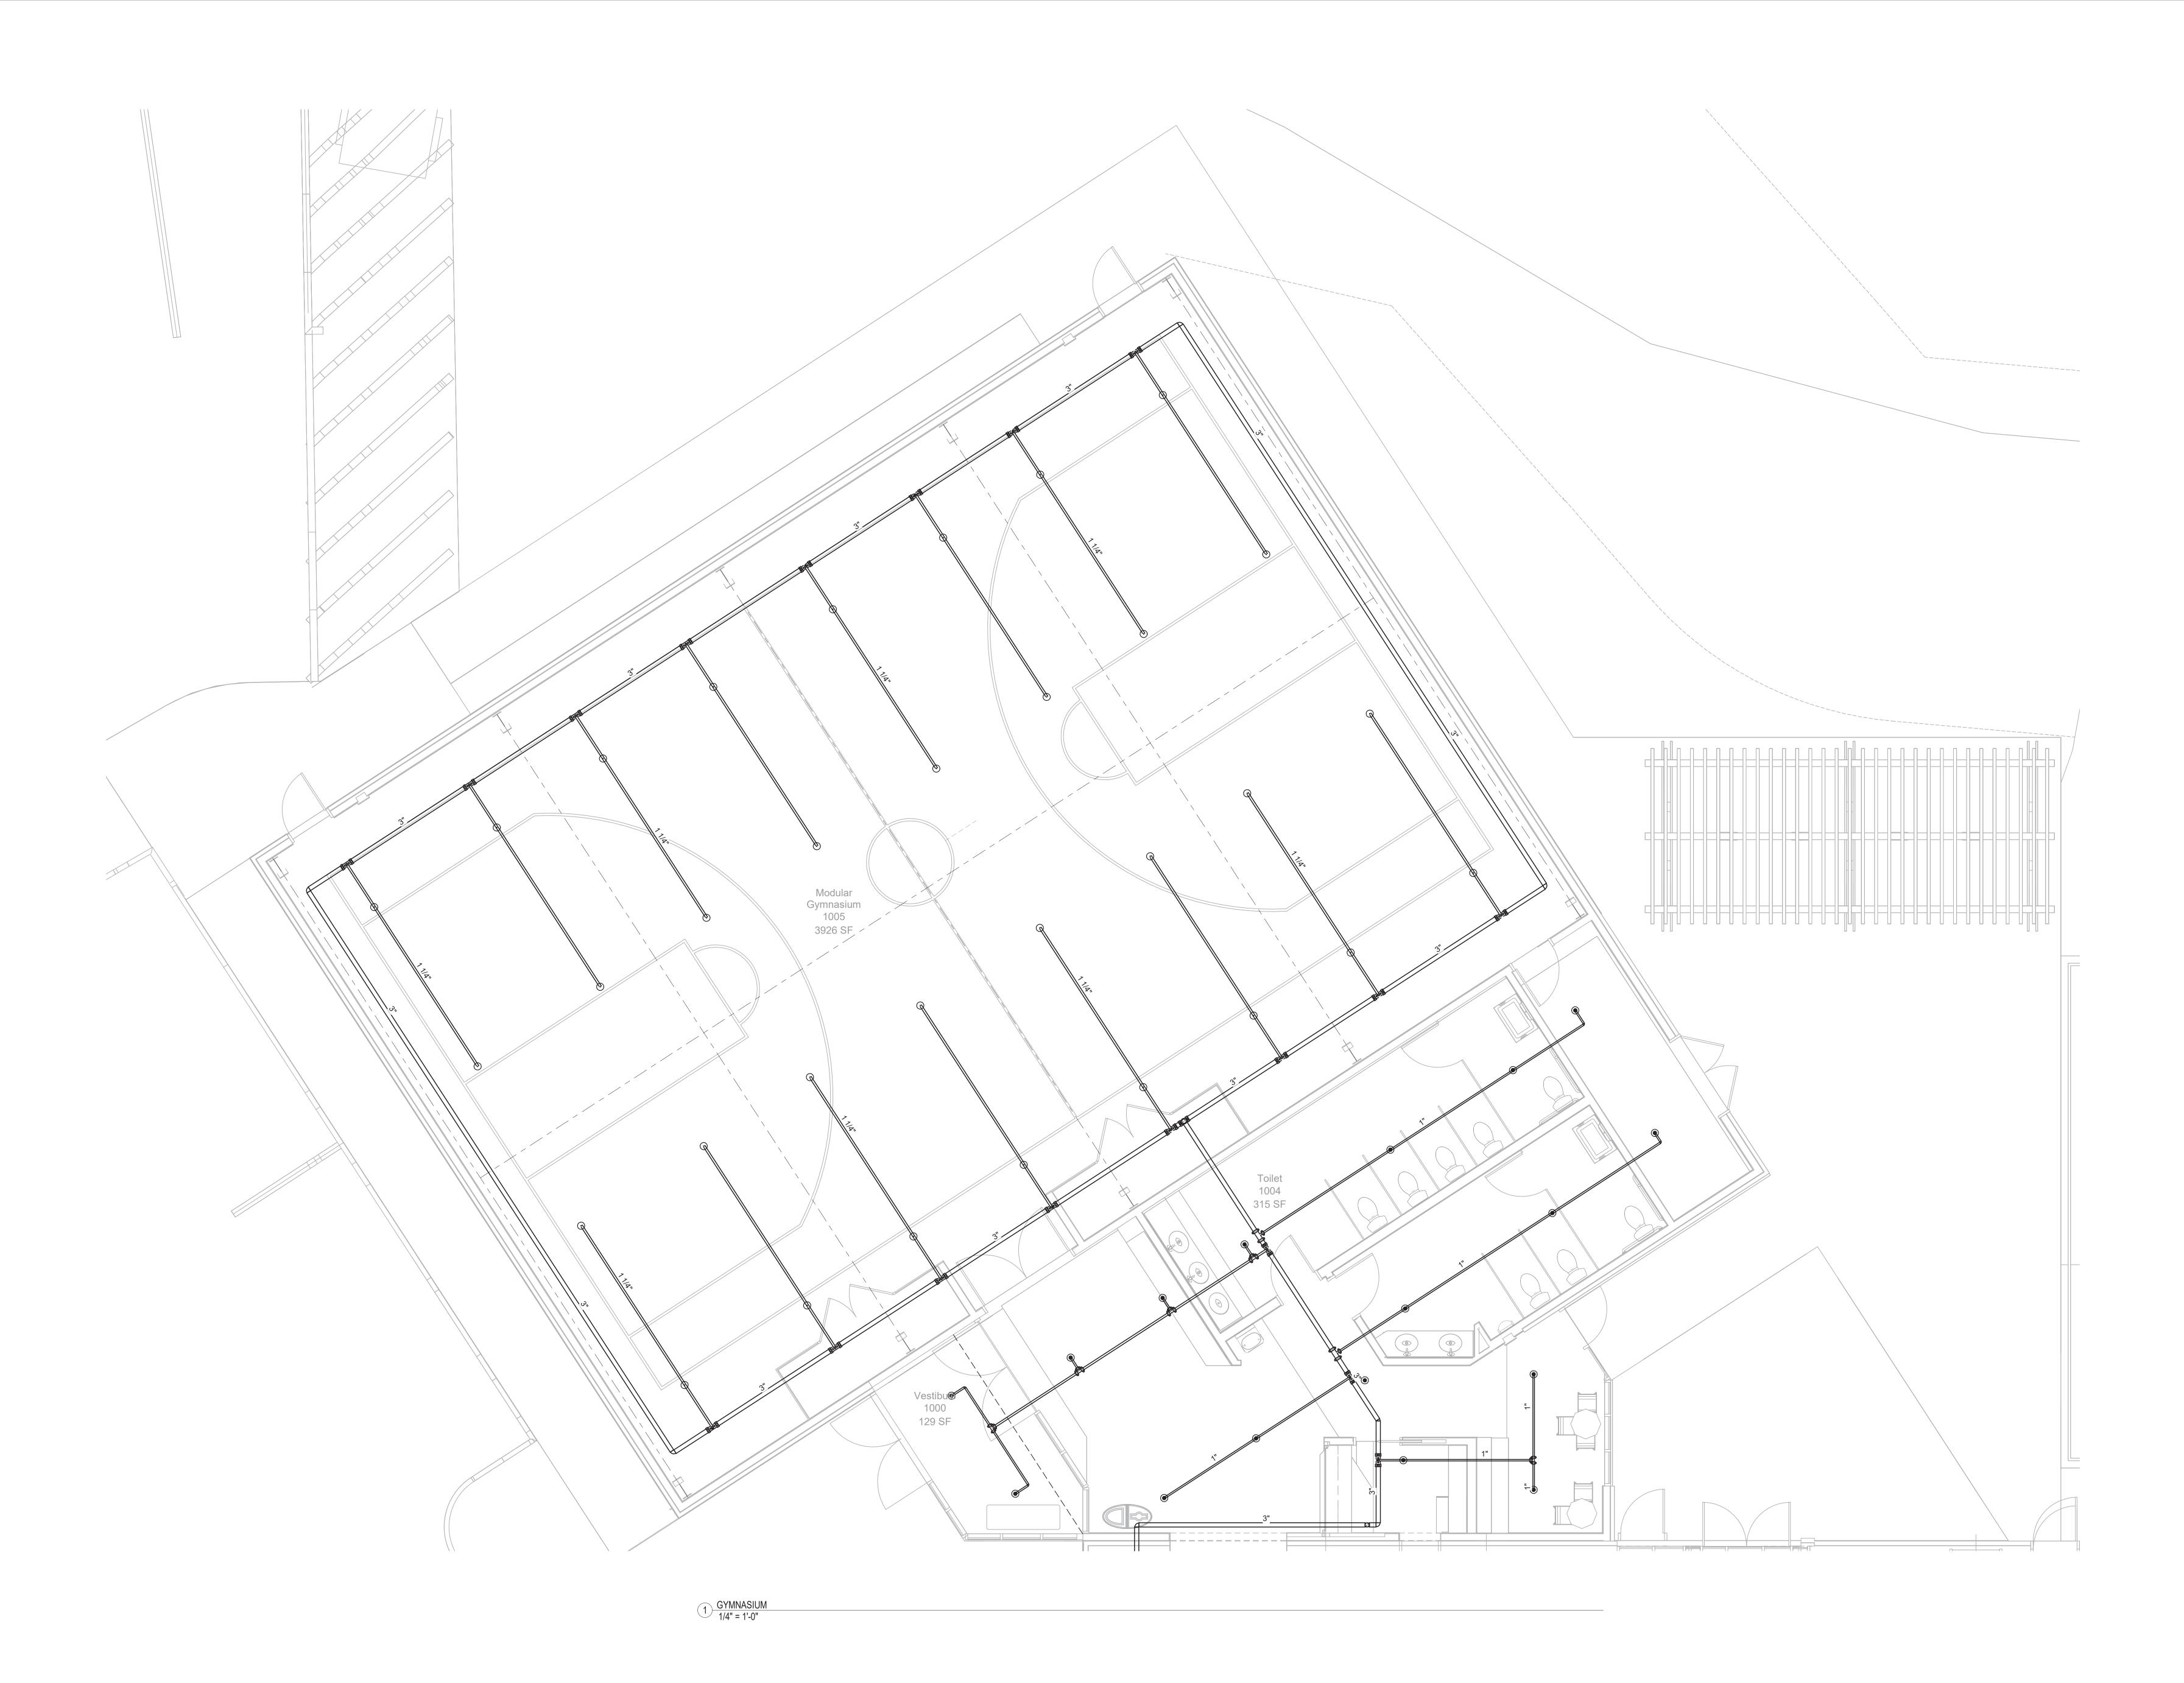



STRUCTURAL ENGINEER:
Shelley Engineering
MEP ENGINEER:
BLW Engineers
INTERIOR DESIGNER:
WDC Interiors

Newburyport Youth Service 59 Low Street Newburyport, MA 01950

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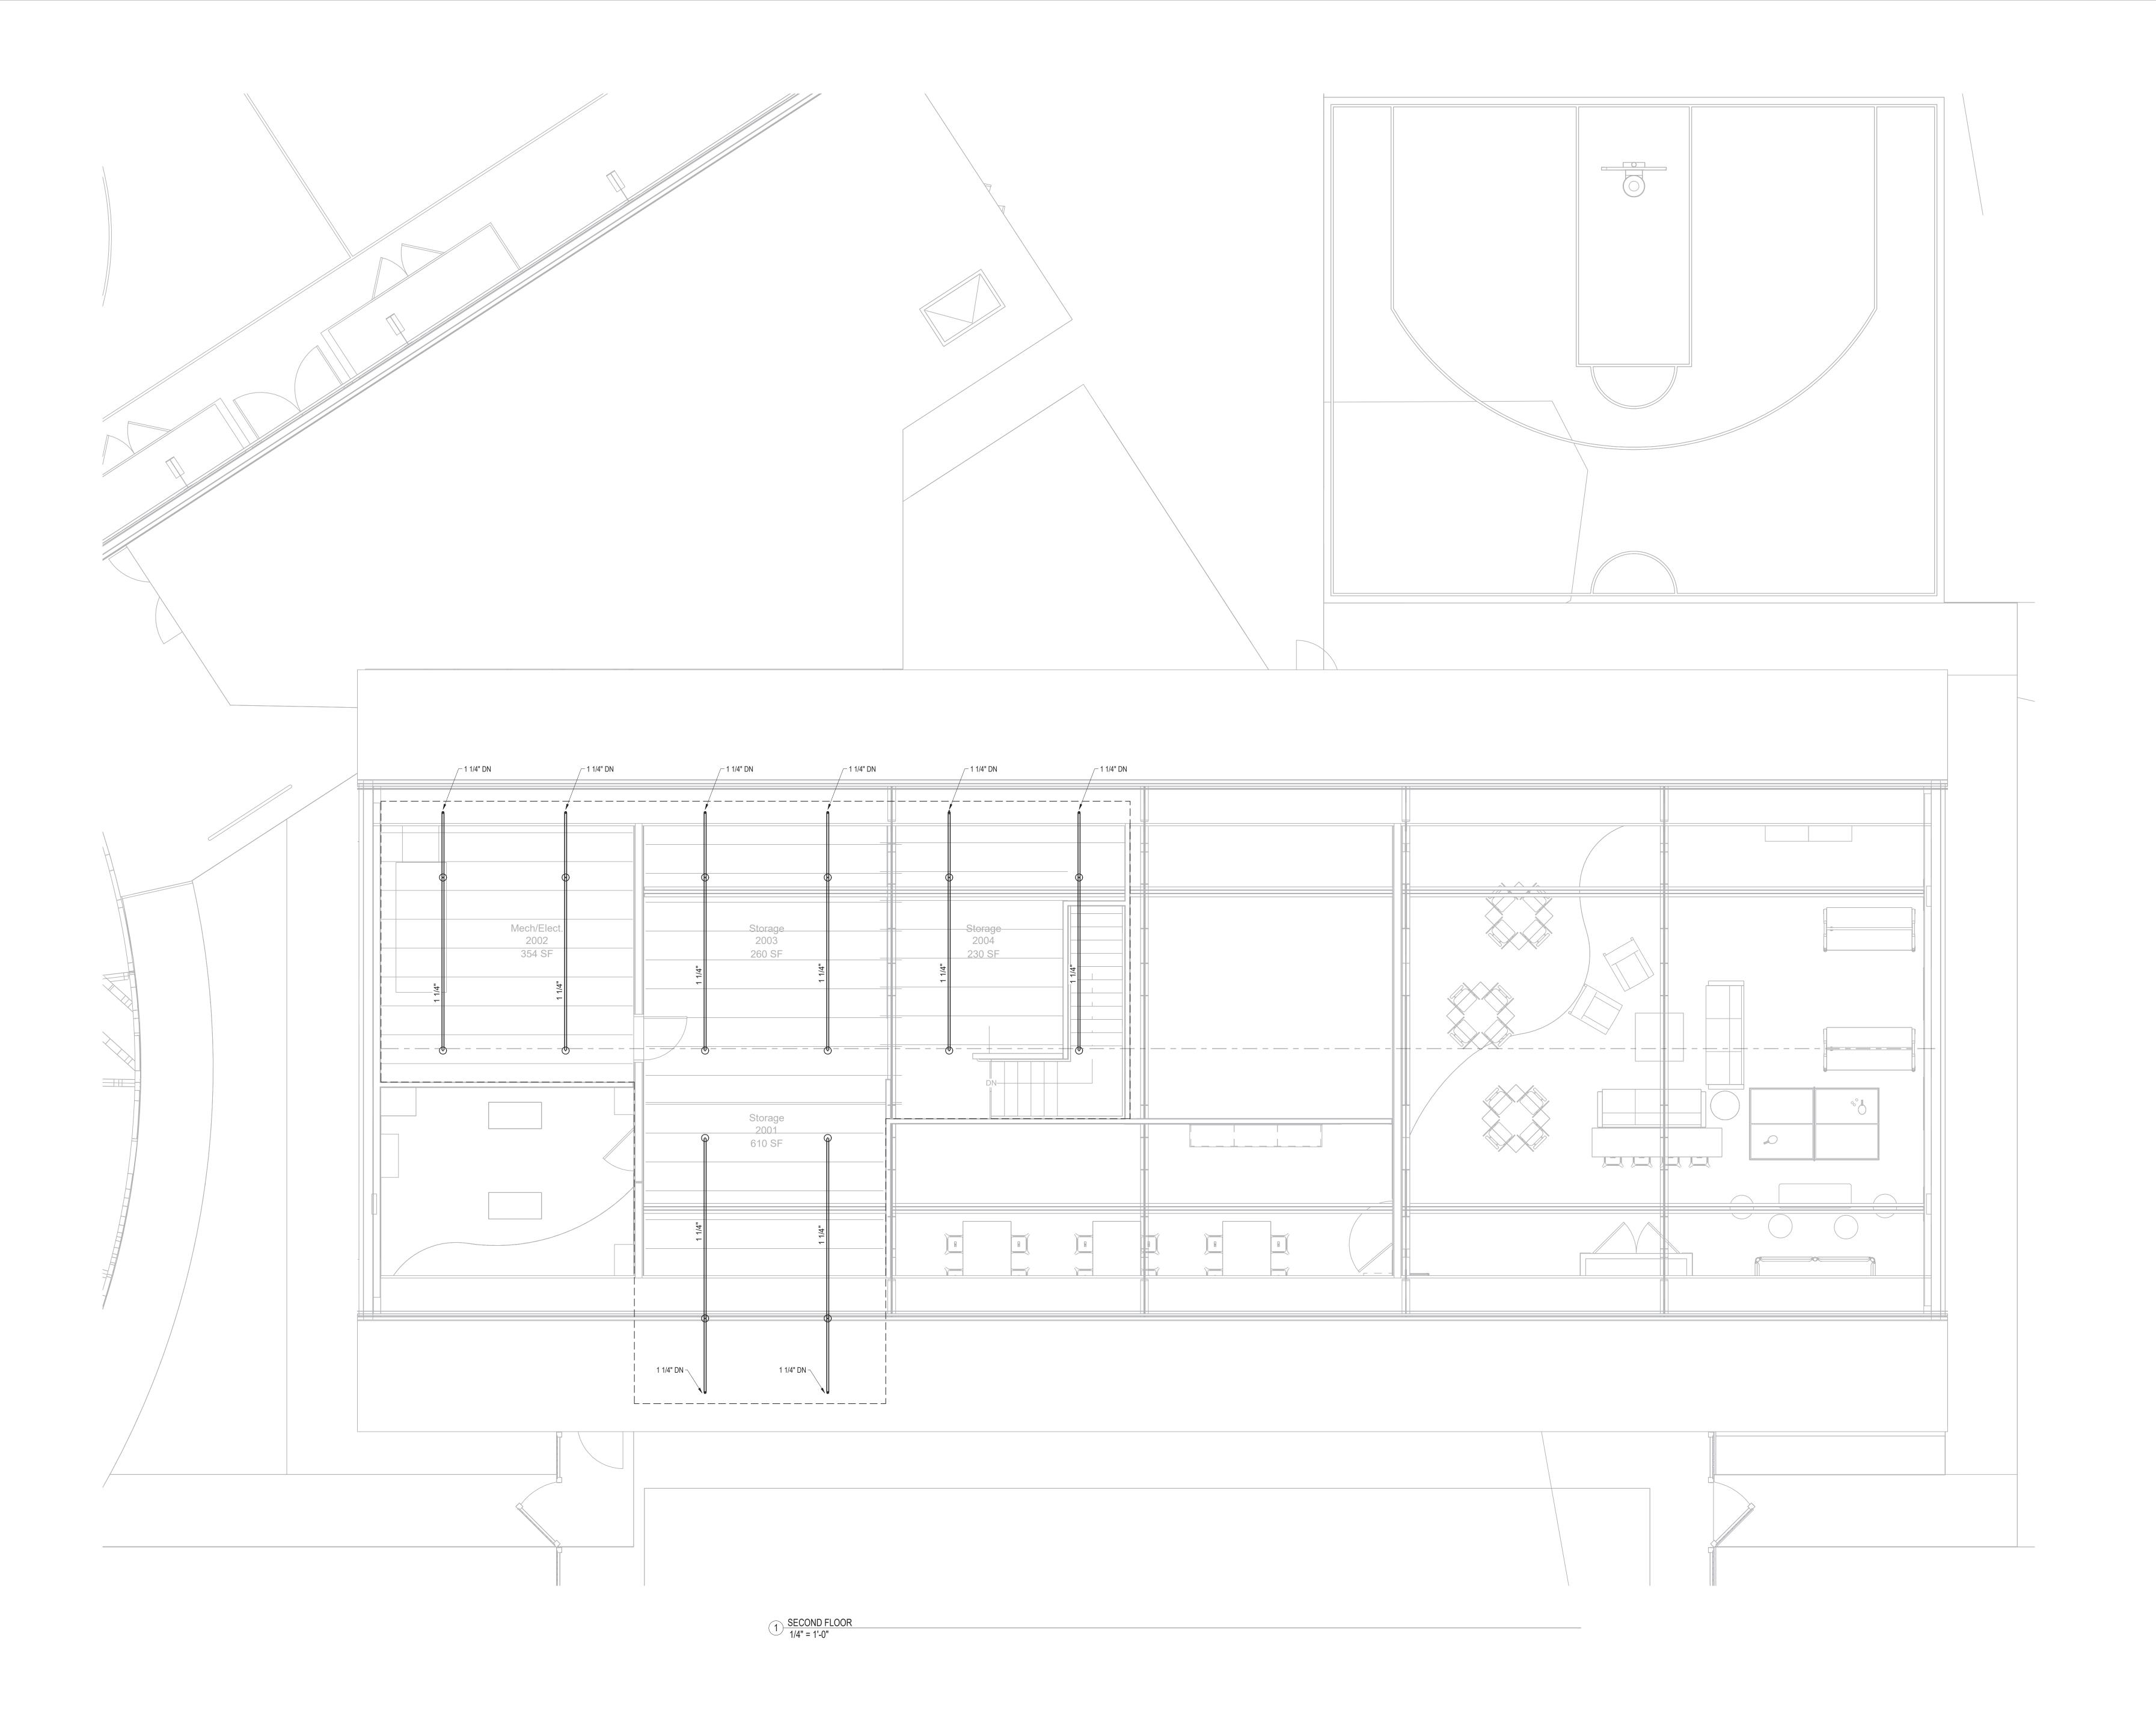
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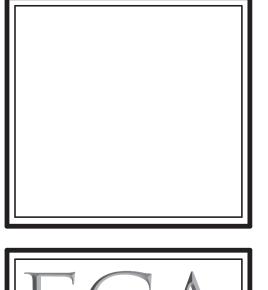
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Sheet Title:
FIRE PROTECTION
GYMASIUM PLAN

Sheet Number:


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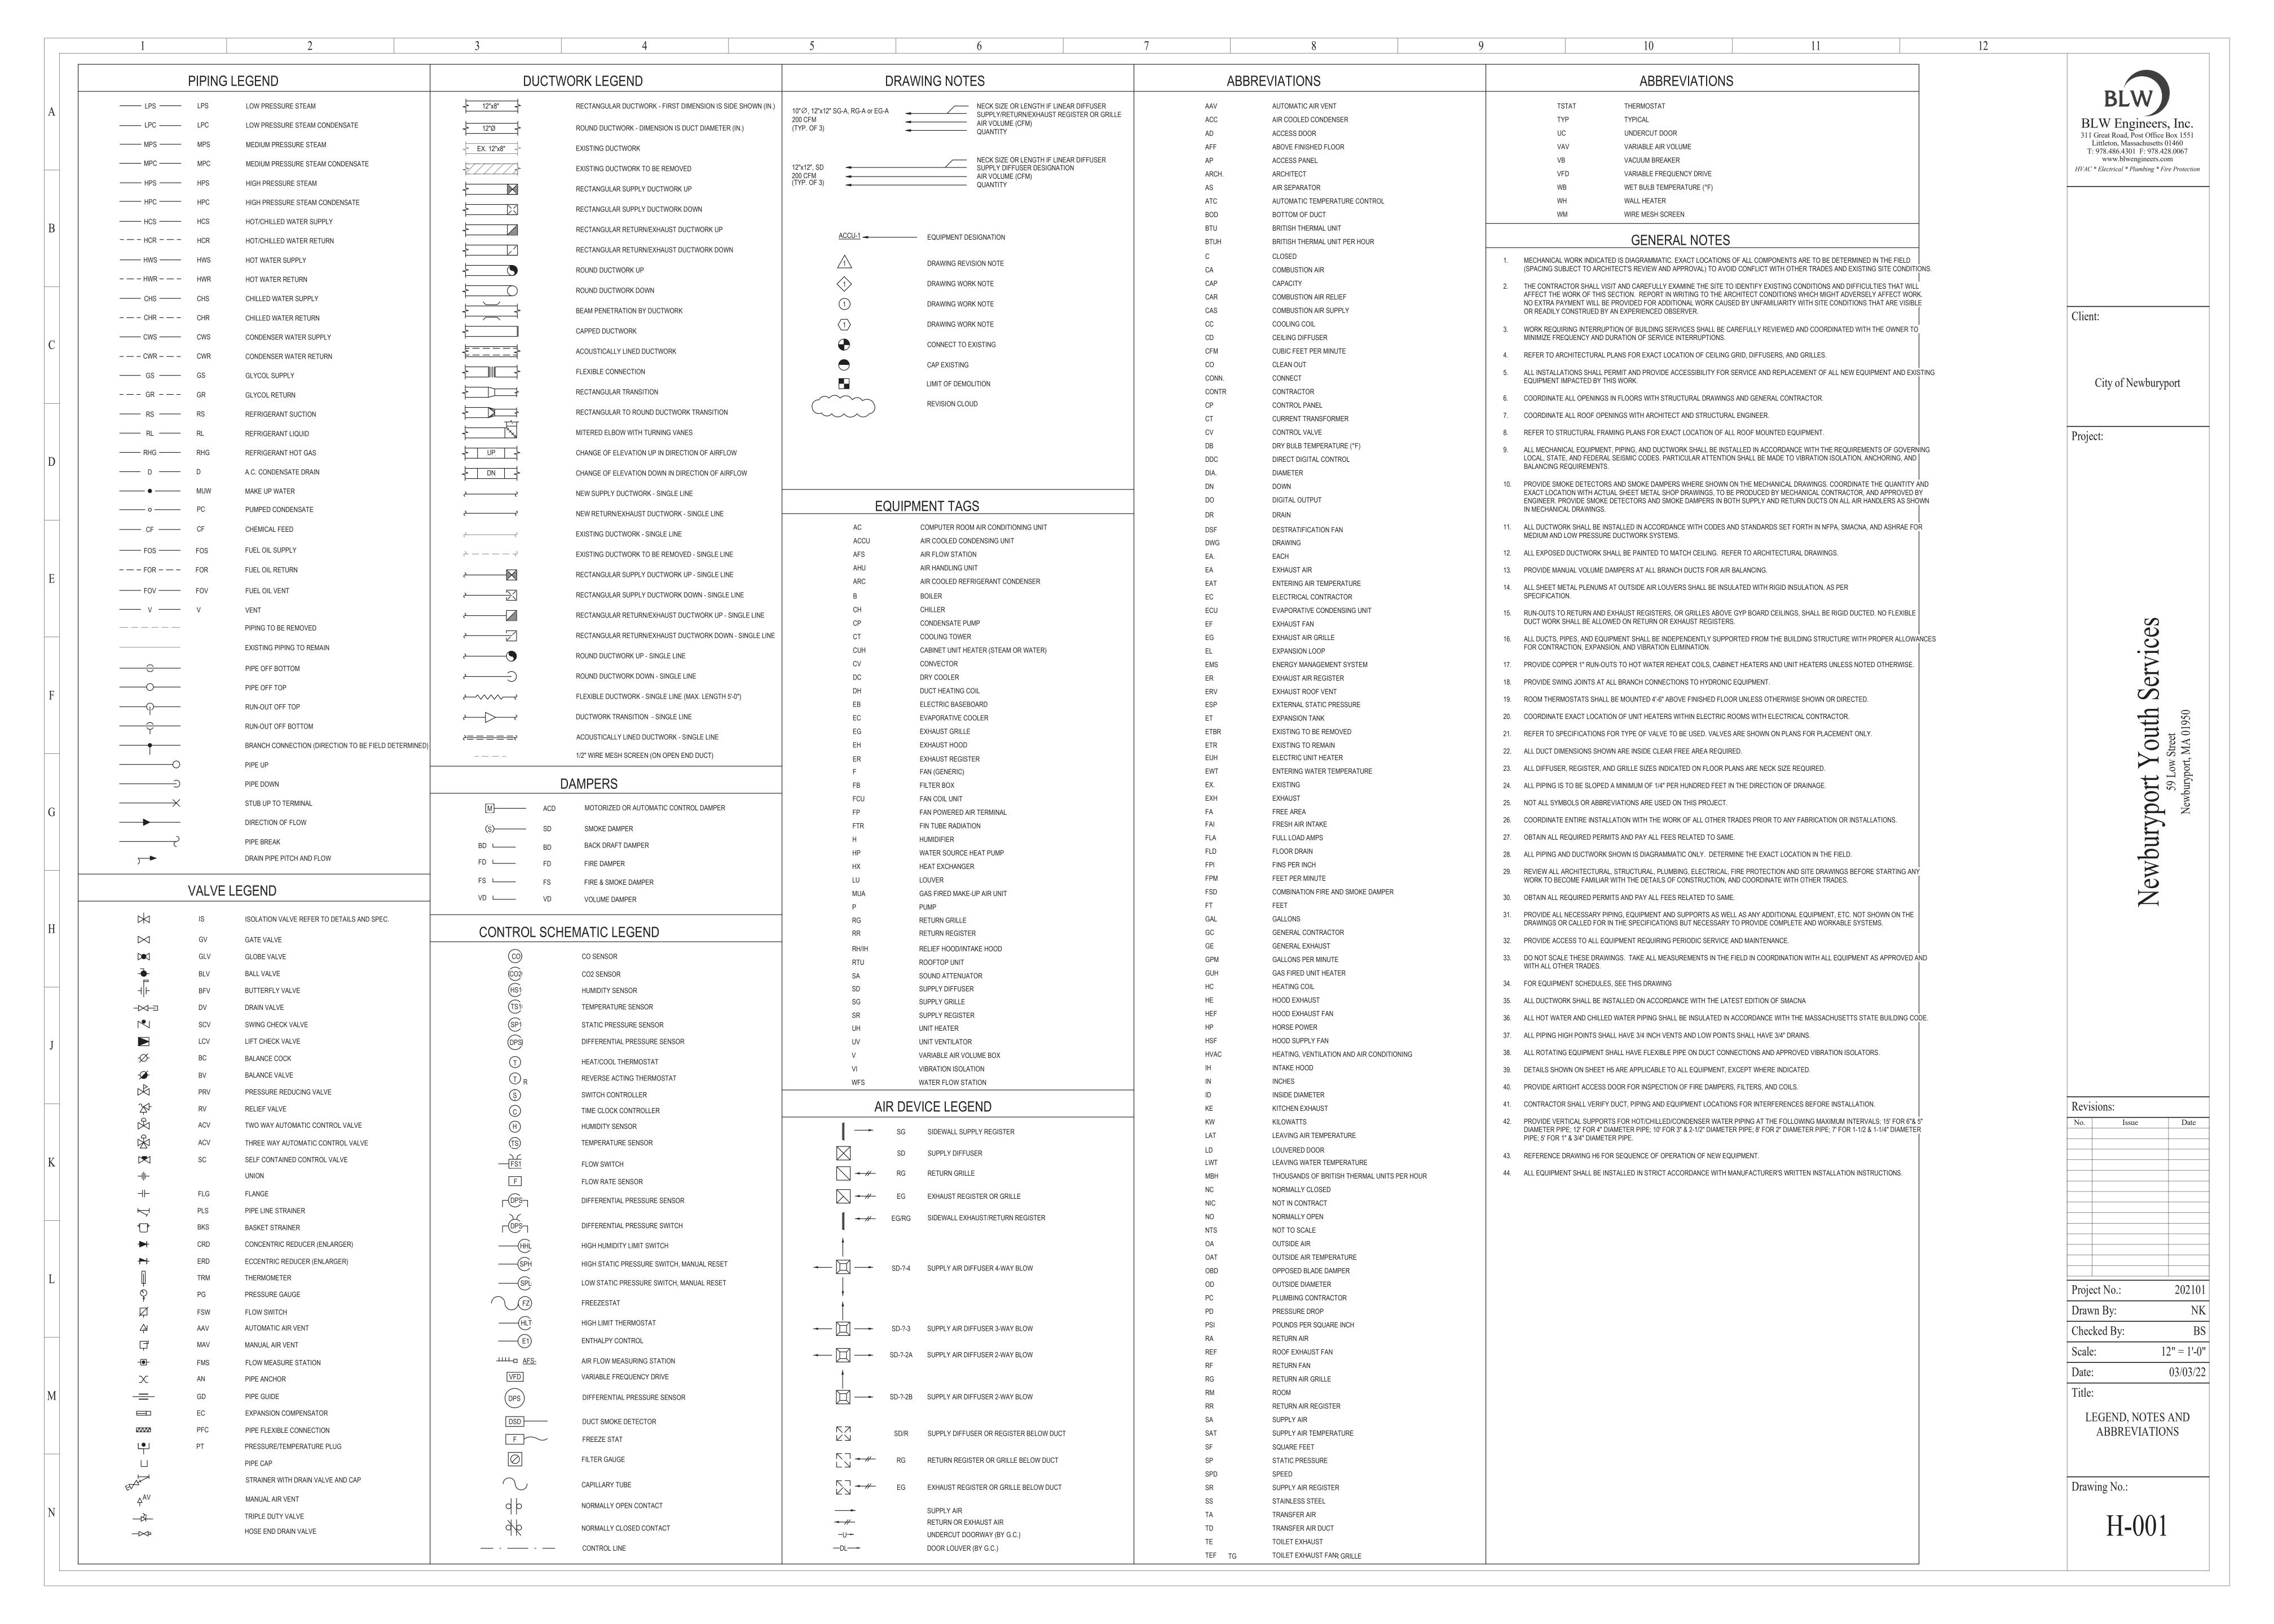



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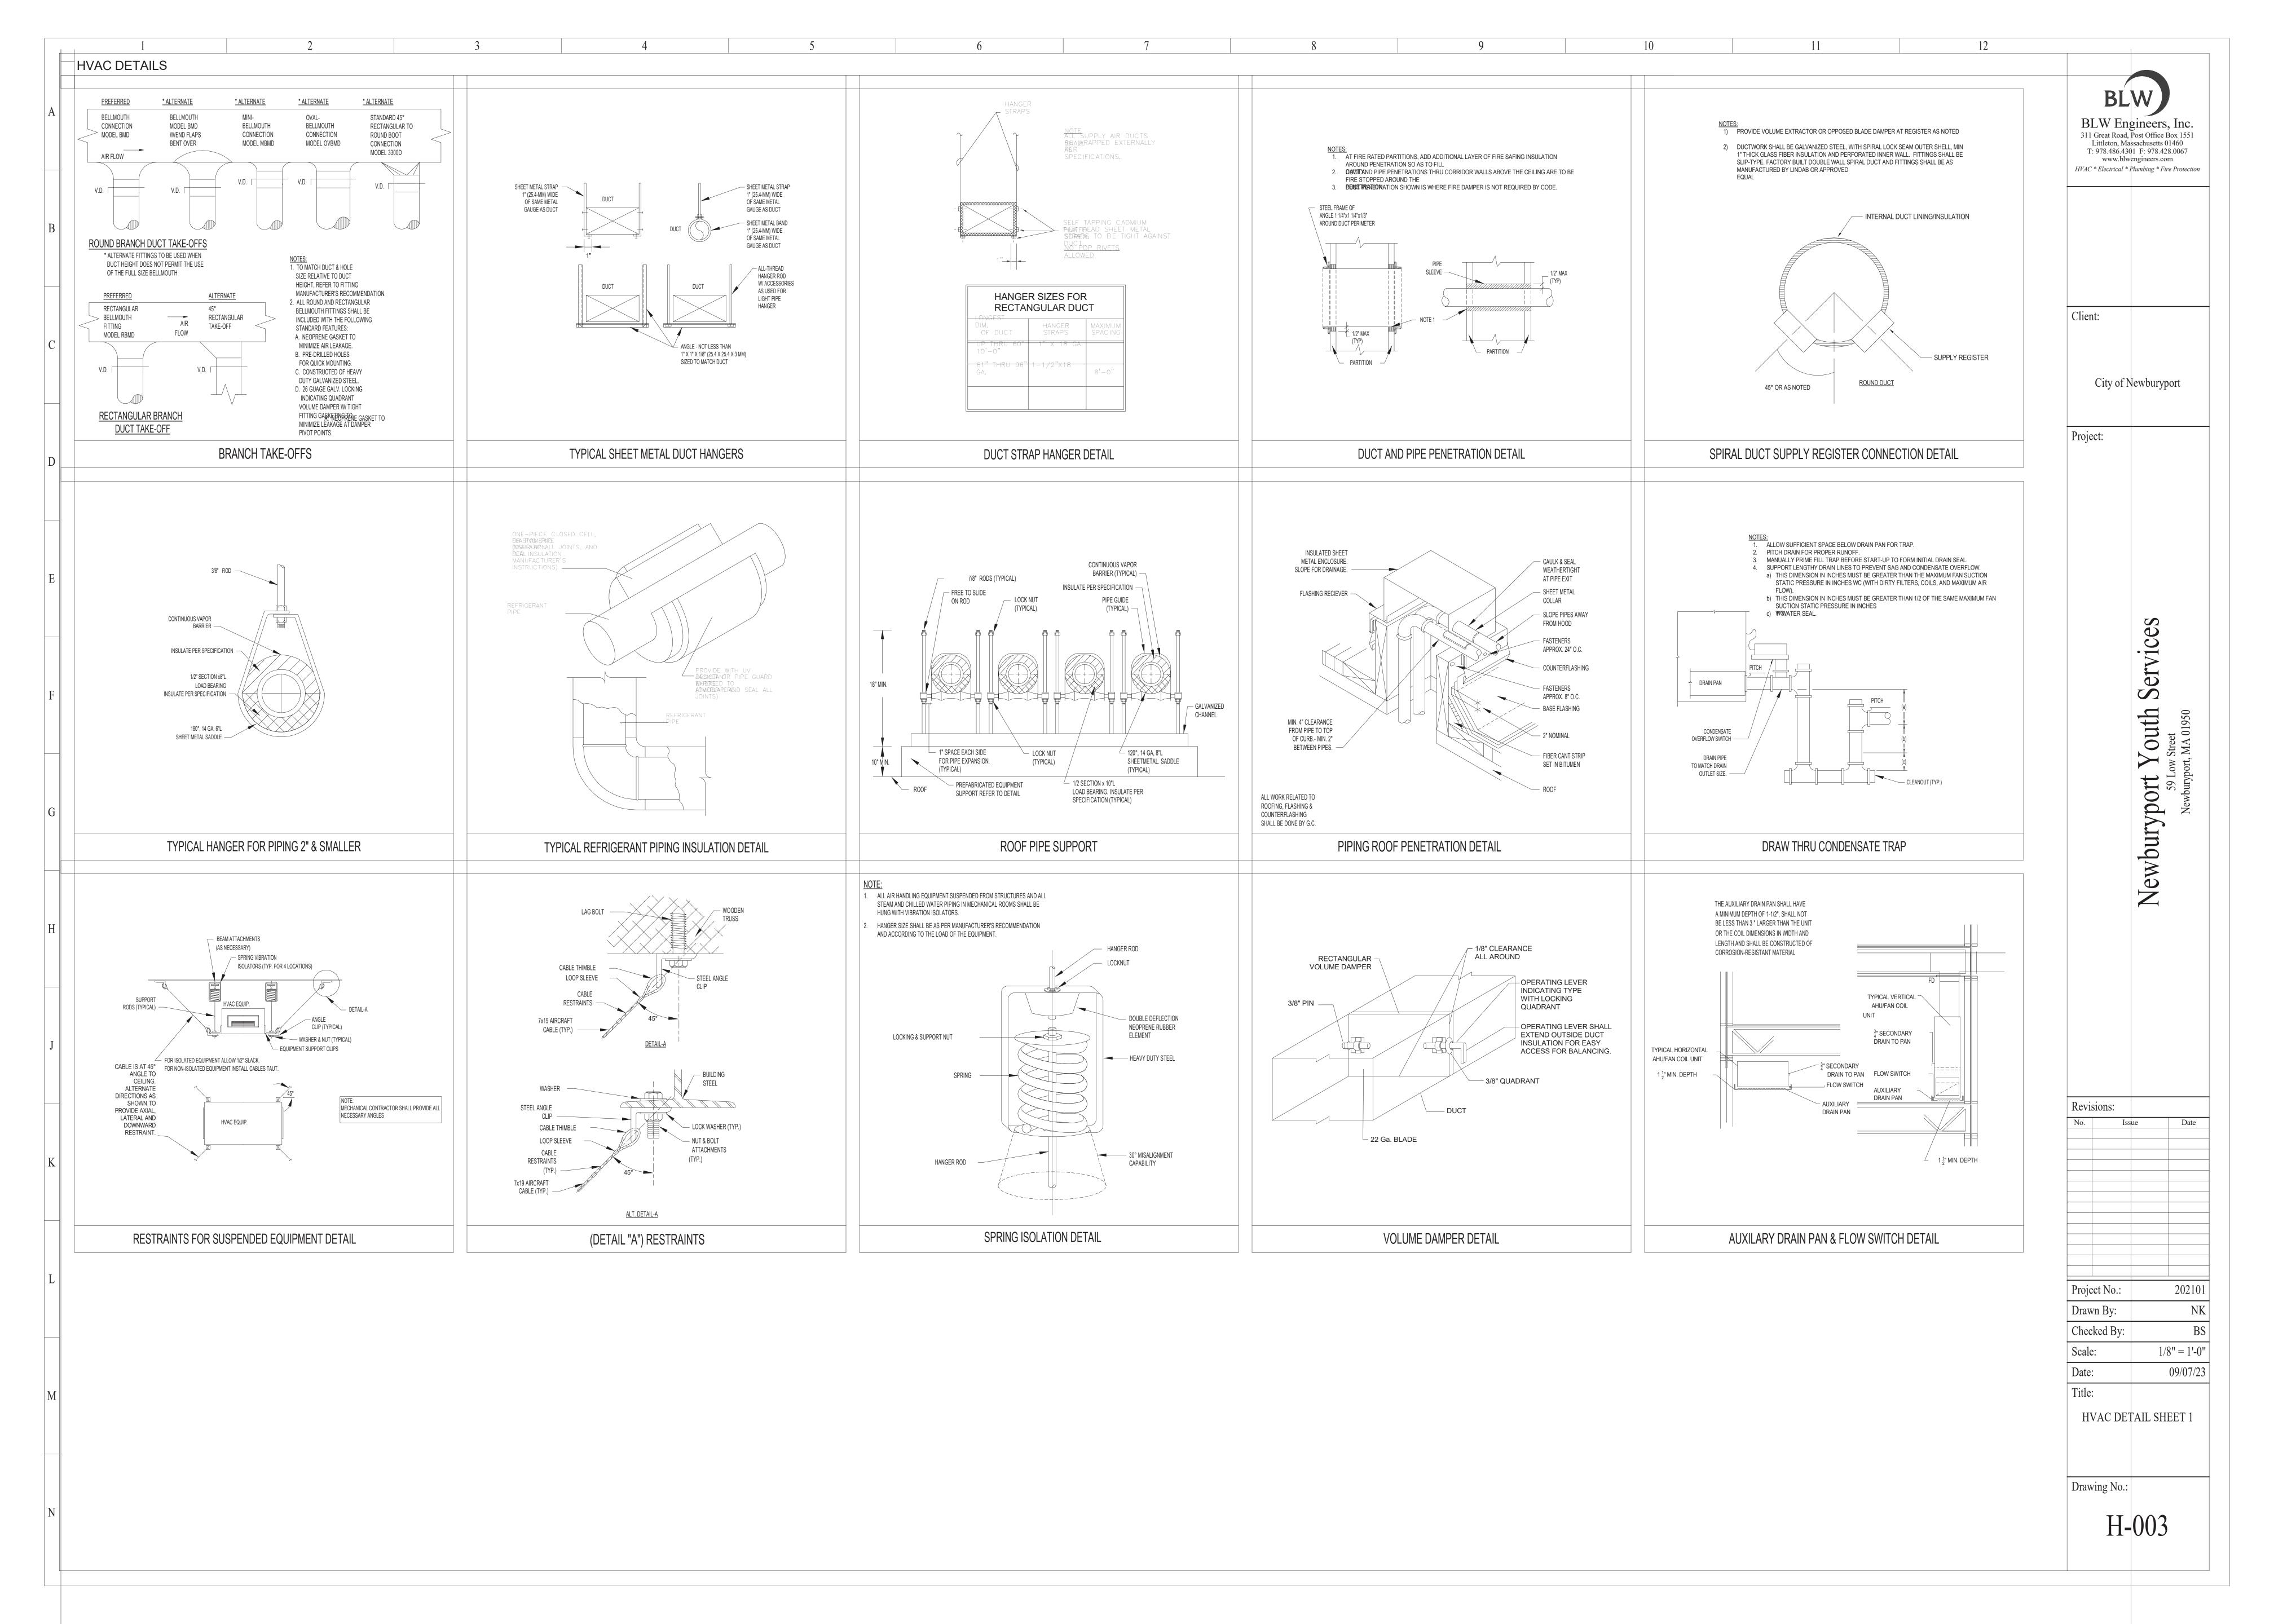



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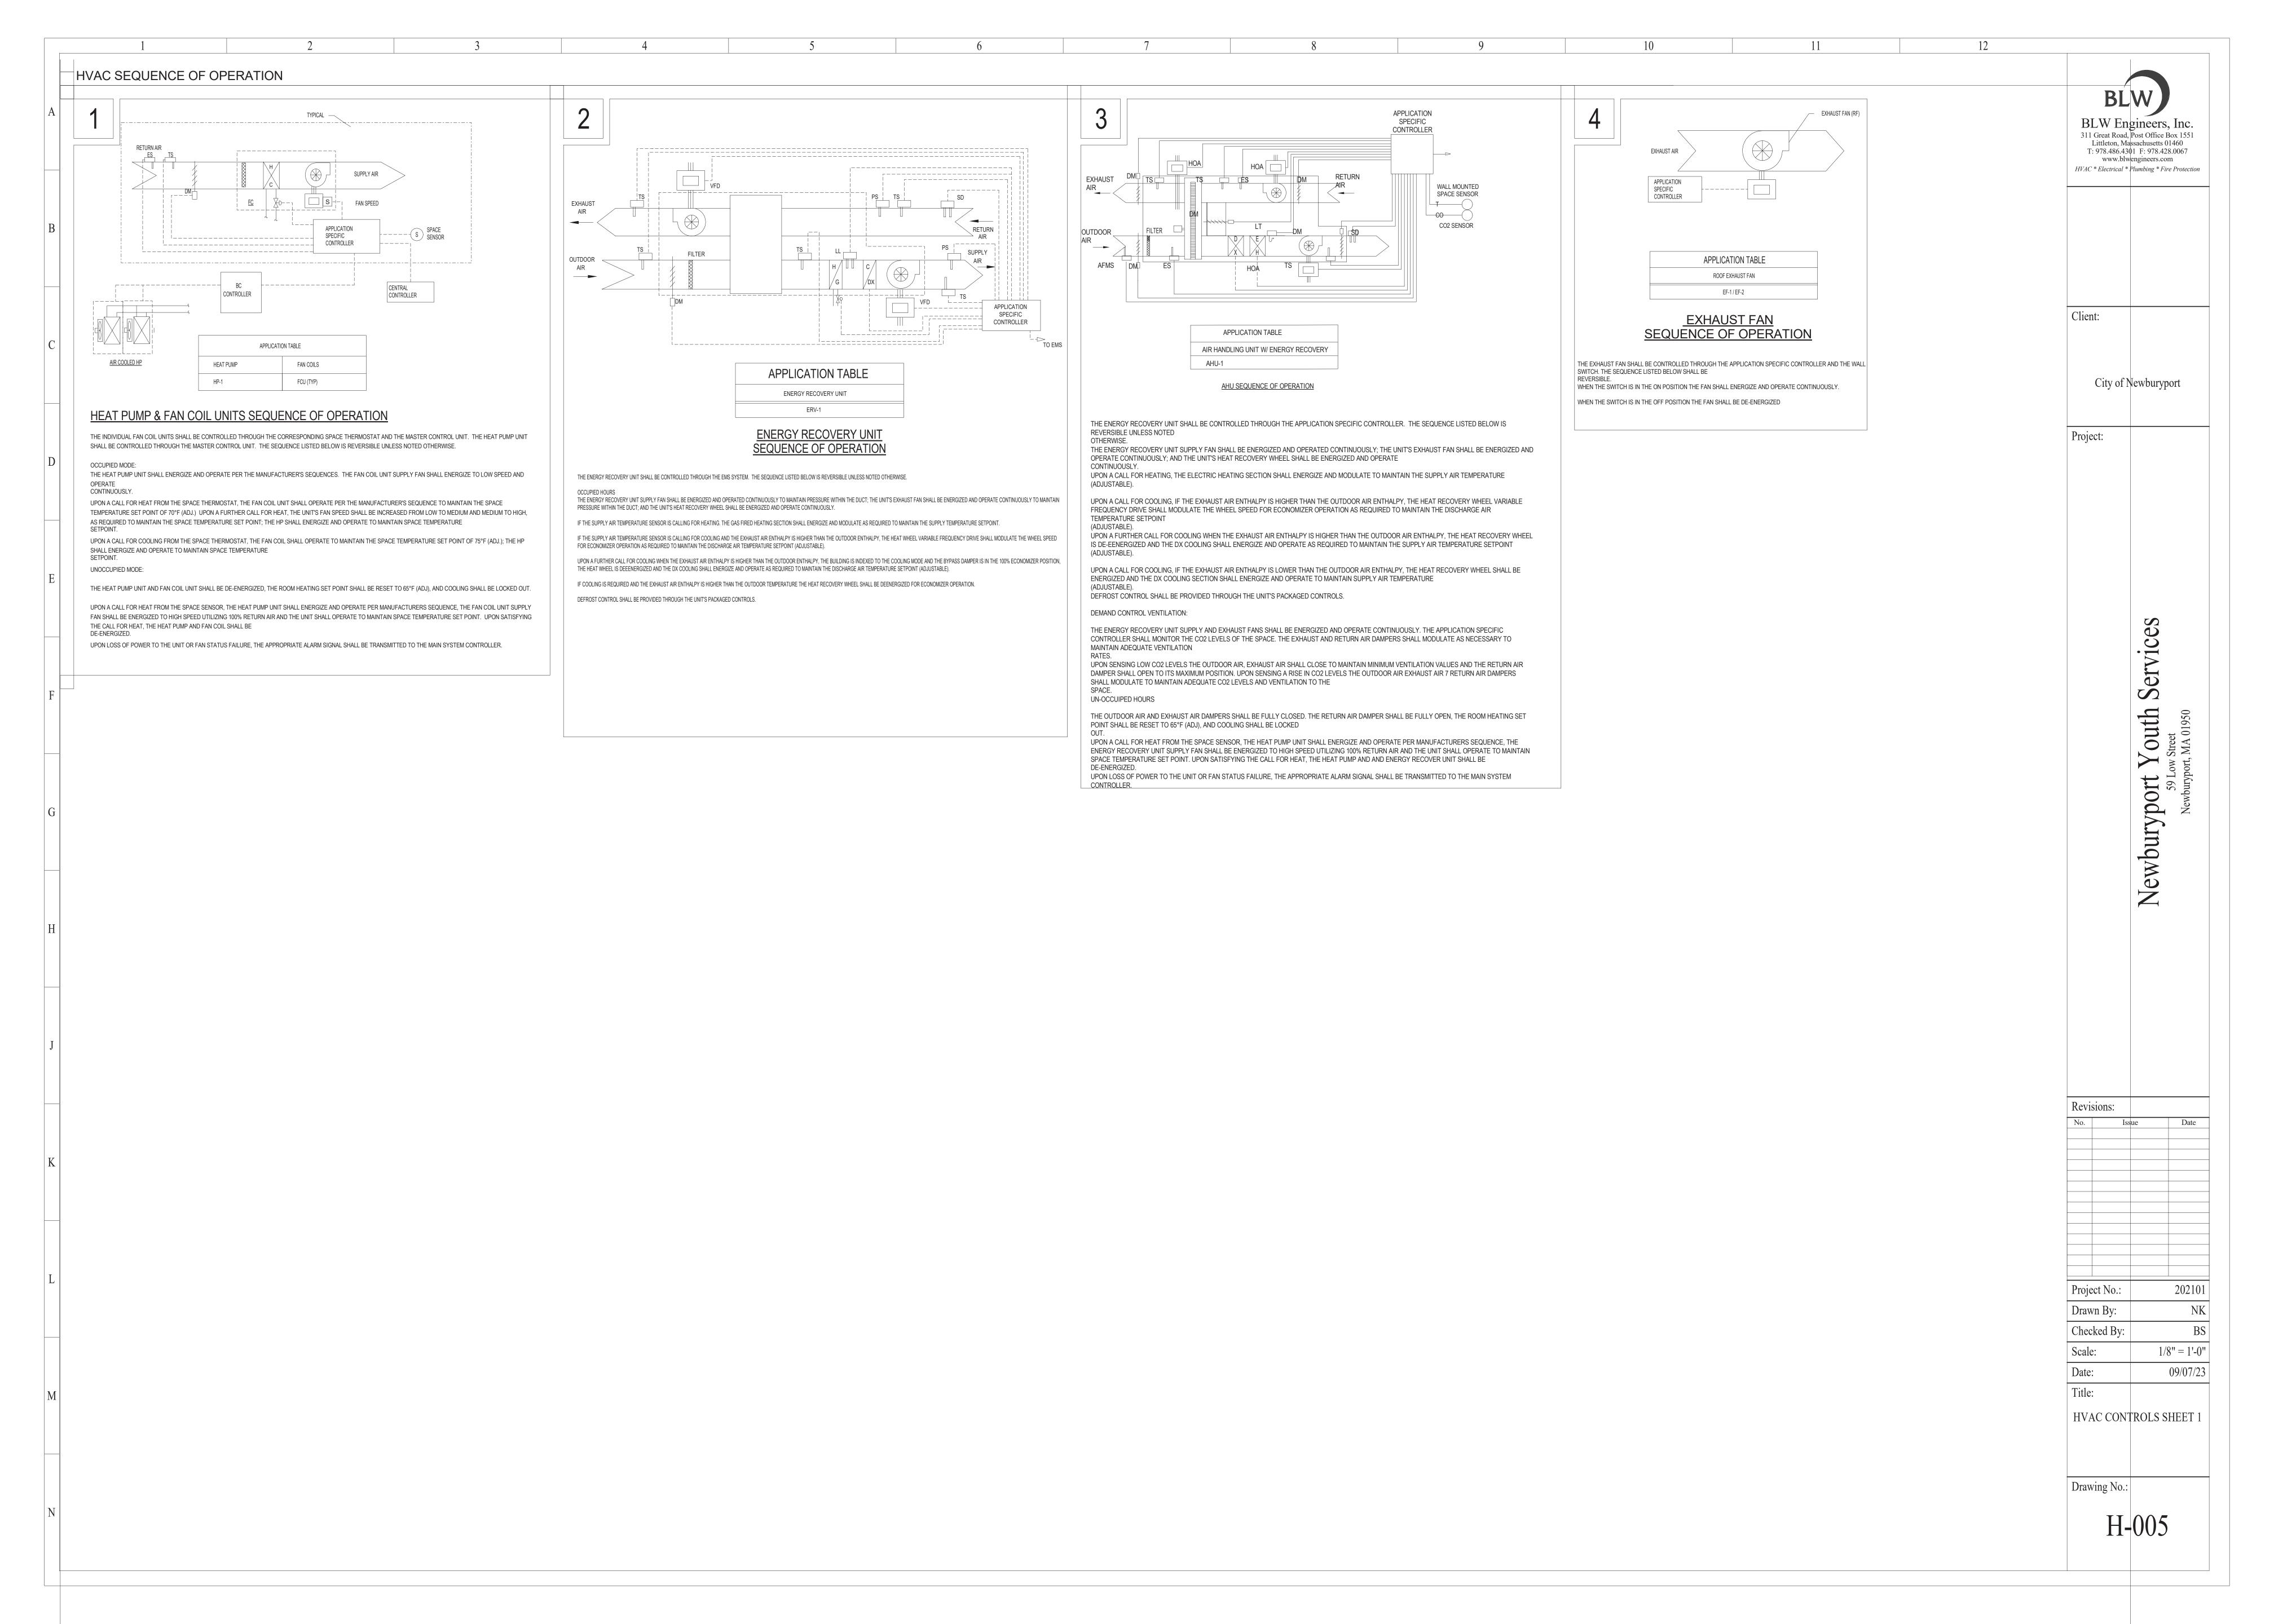
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FIRE PROTECTION SECOND FLOOR PLAN
Sheet Number:
FP-103







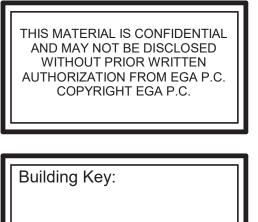


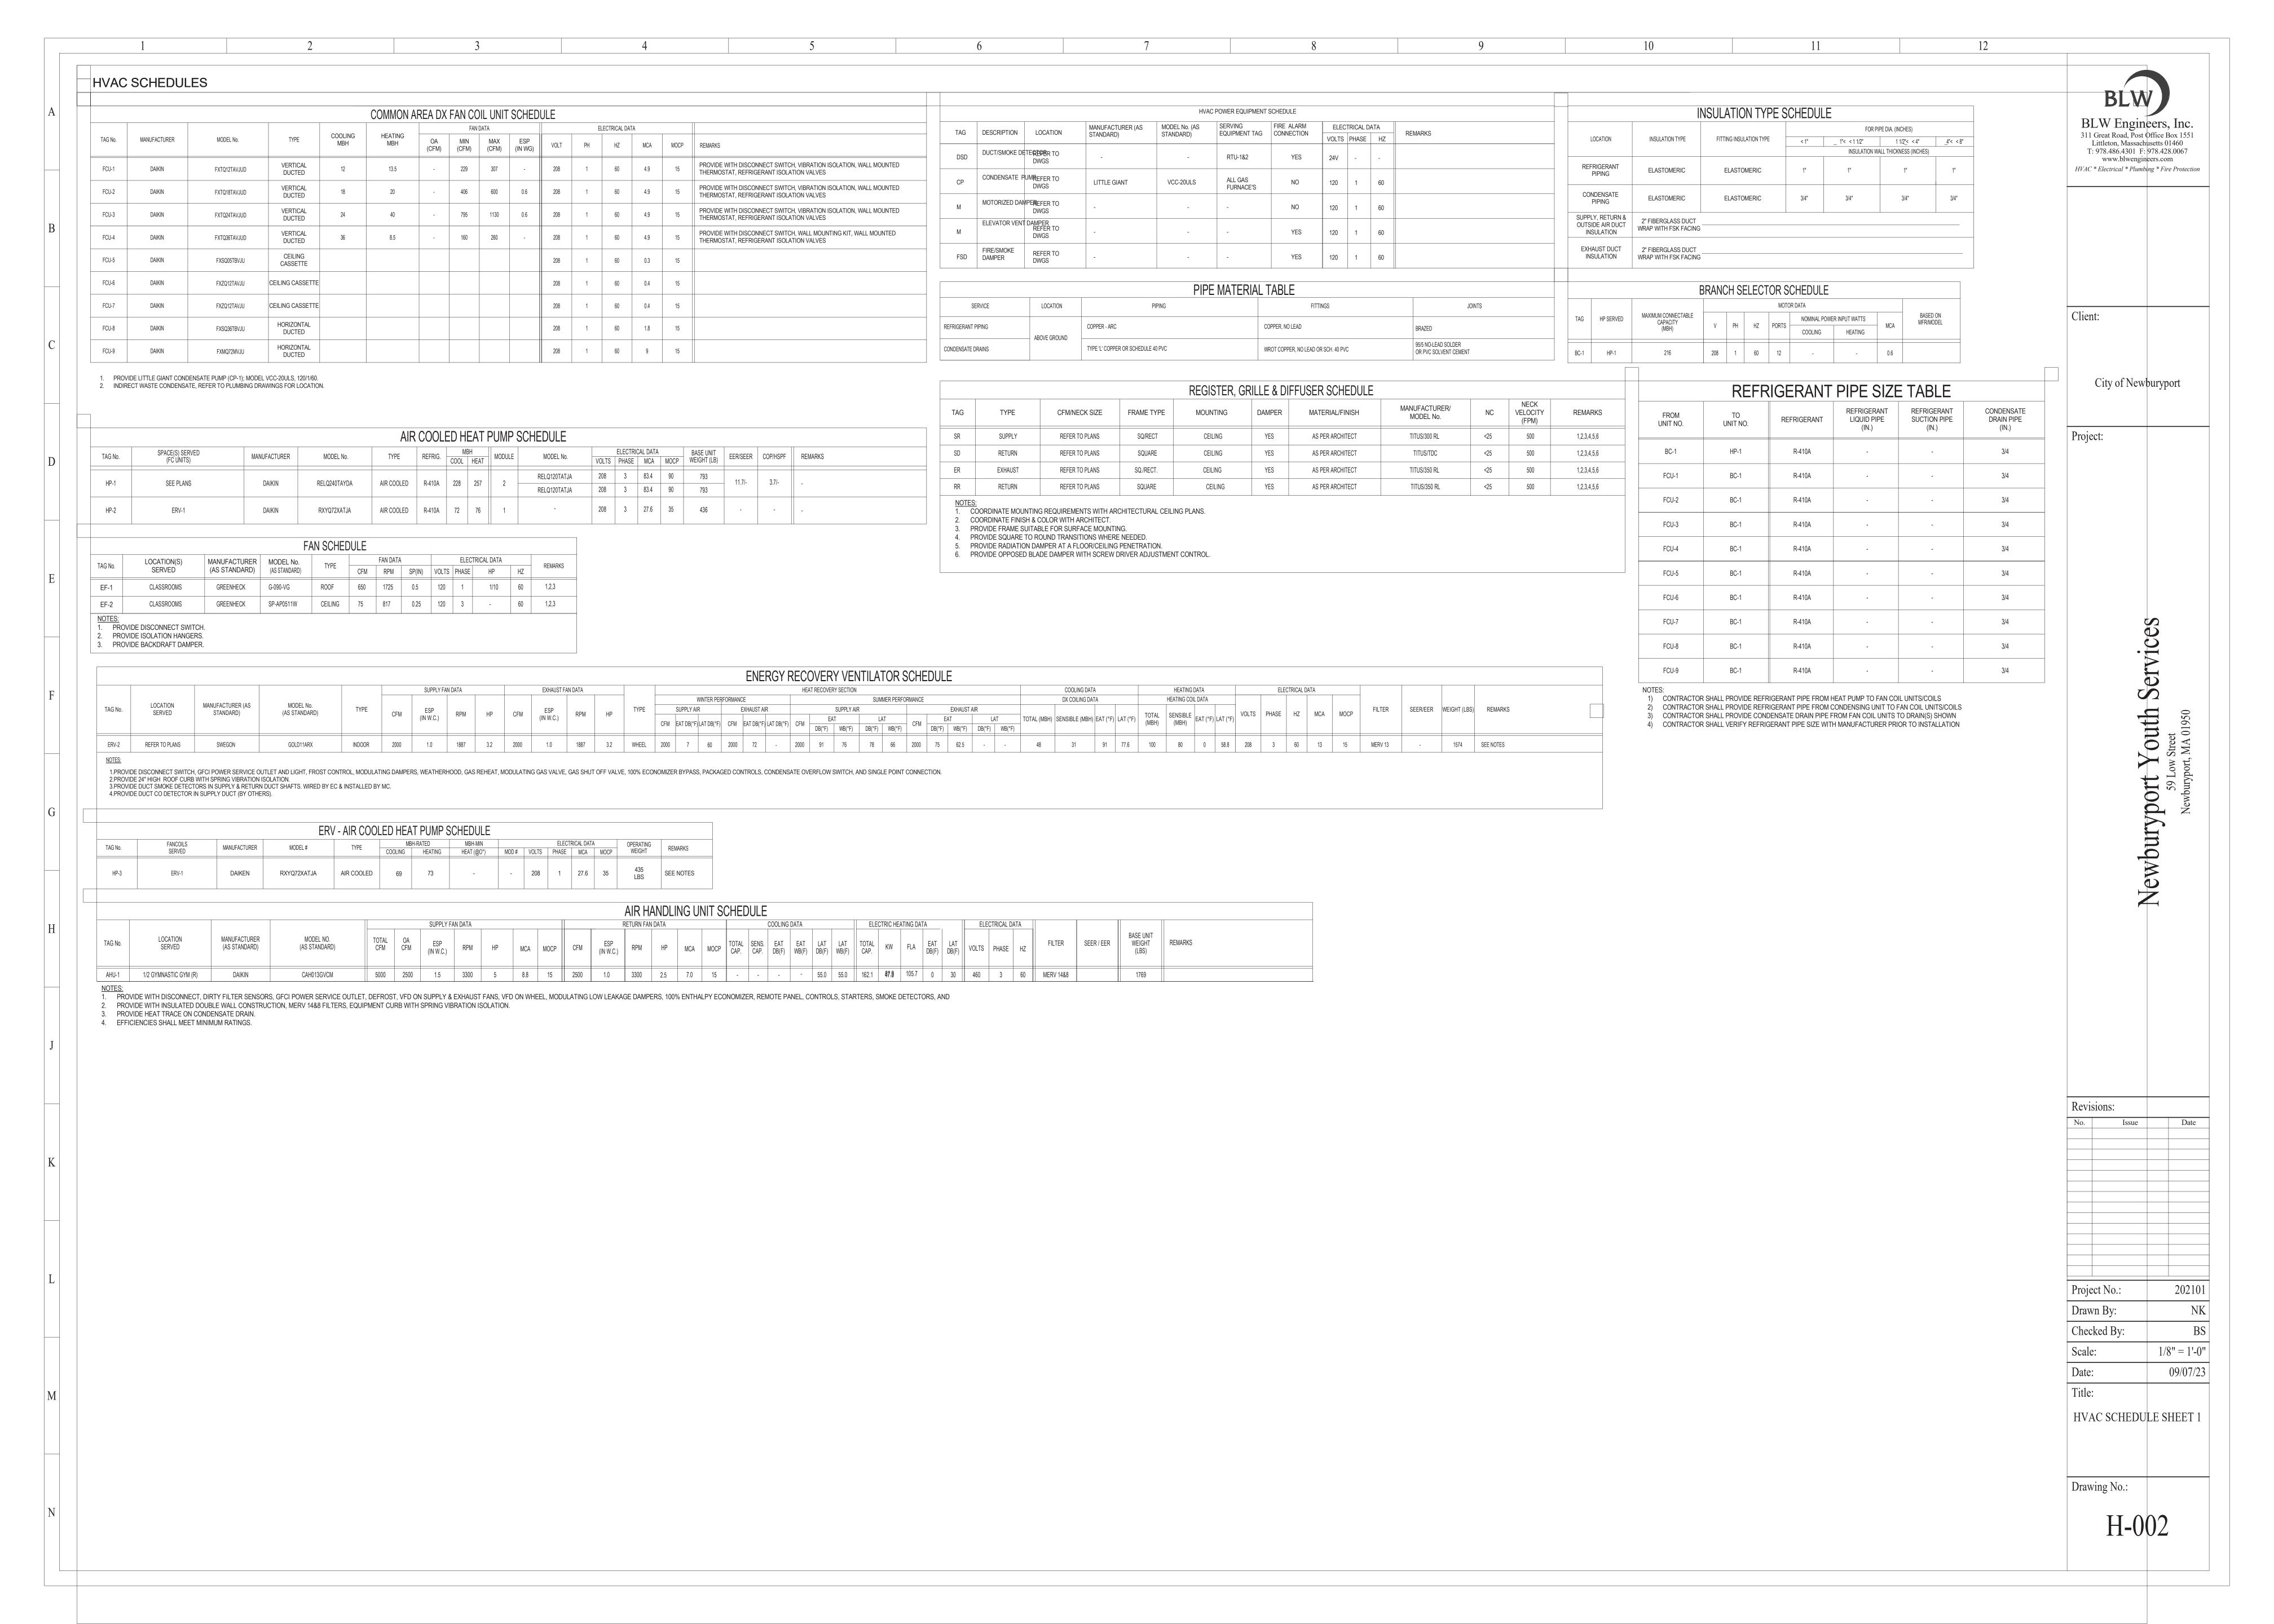

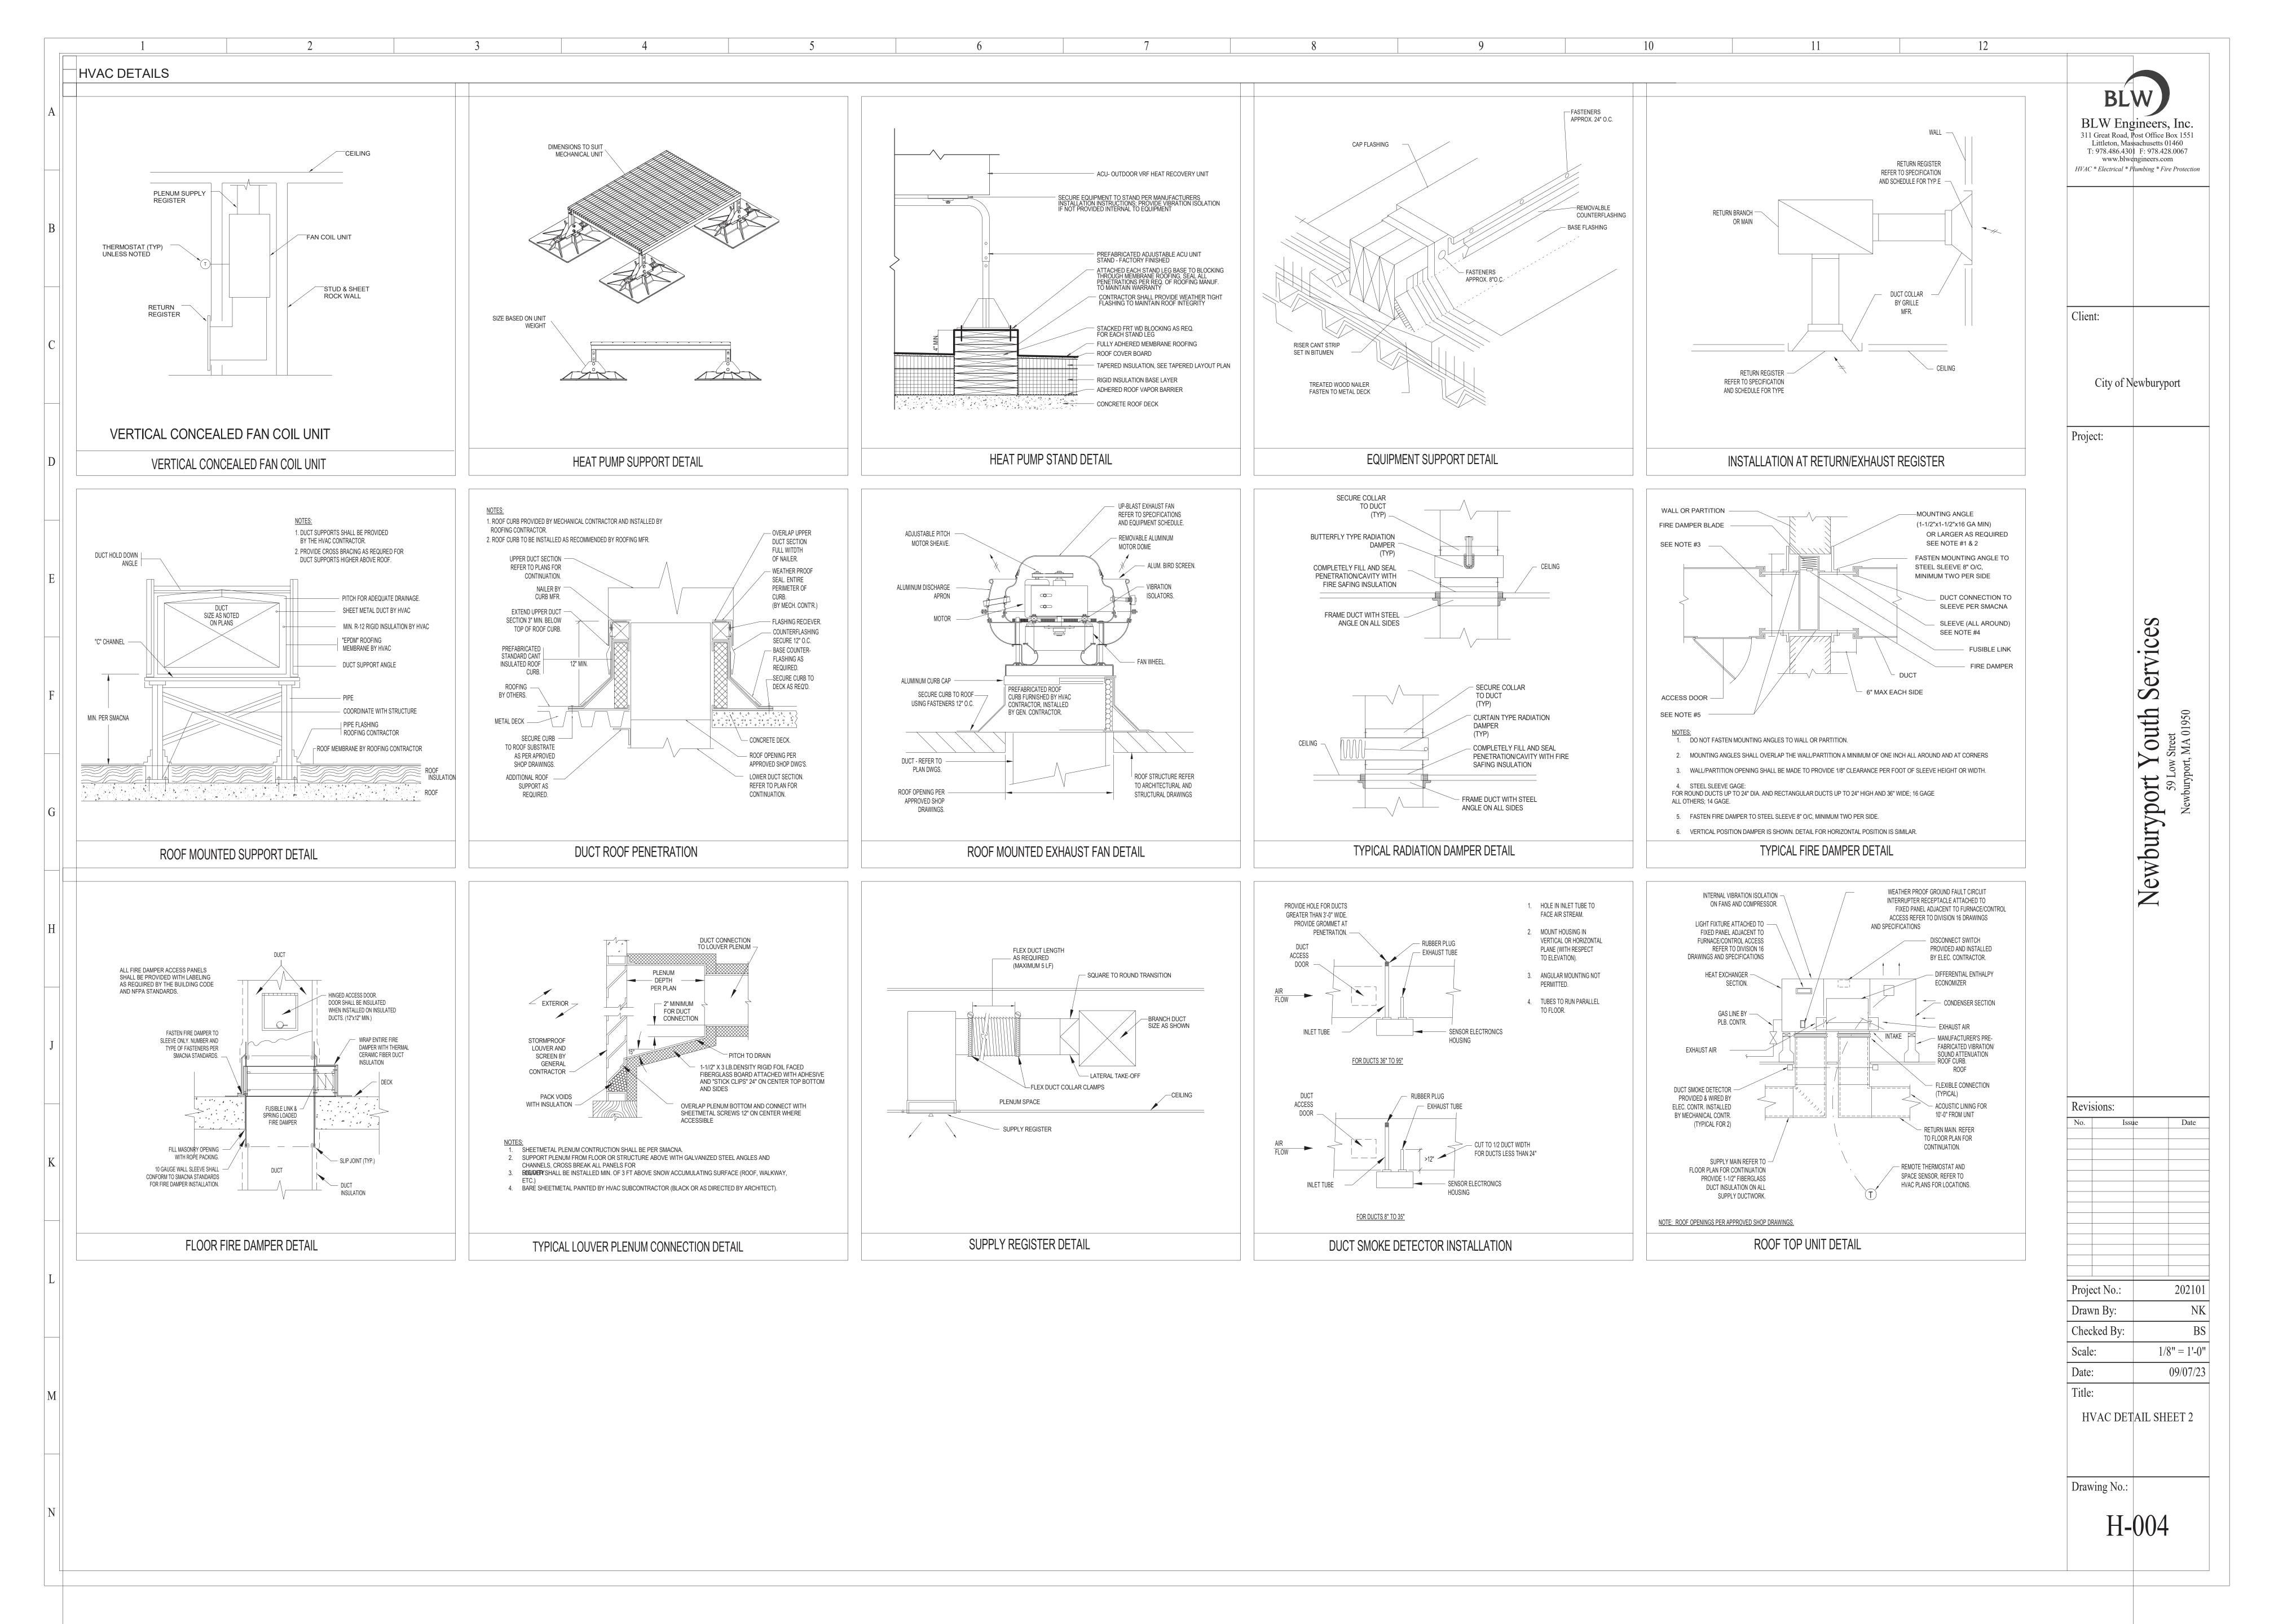


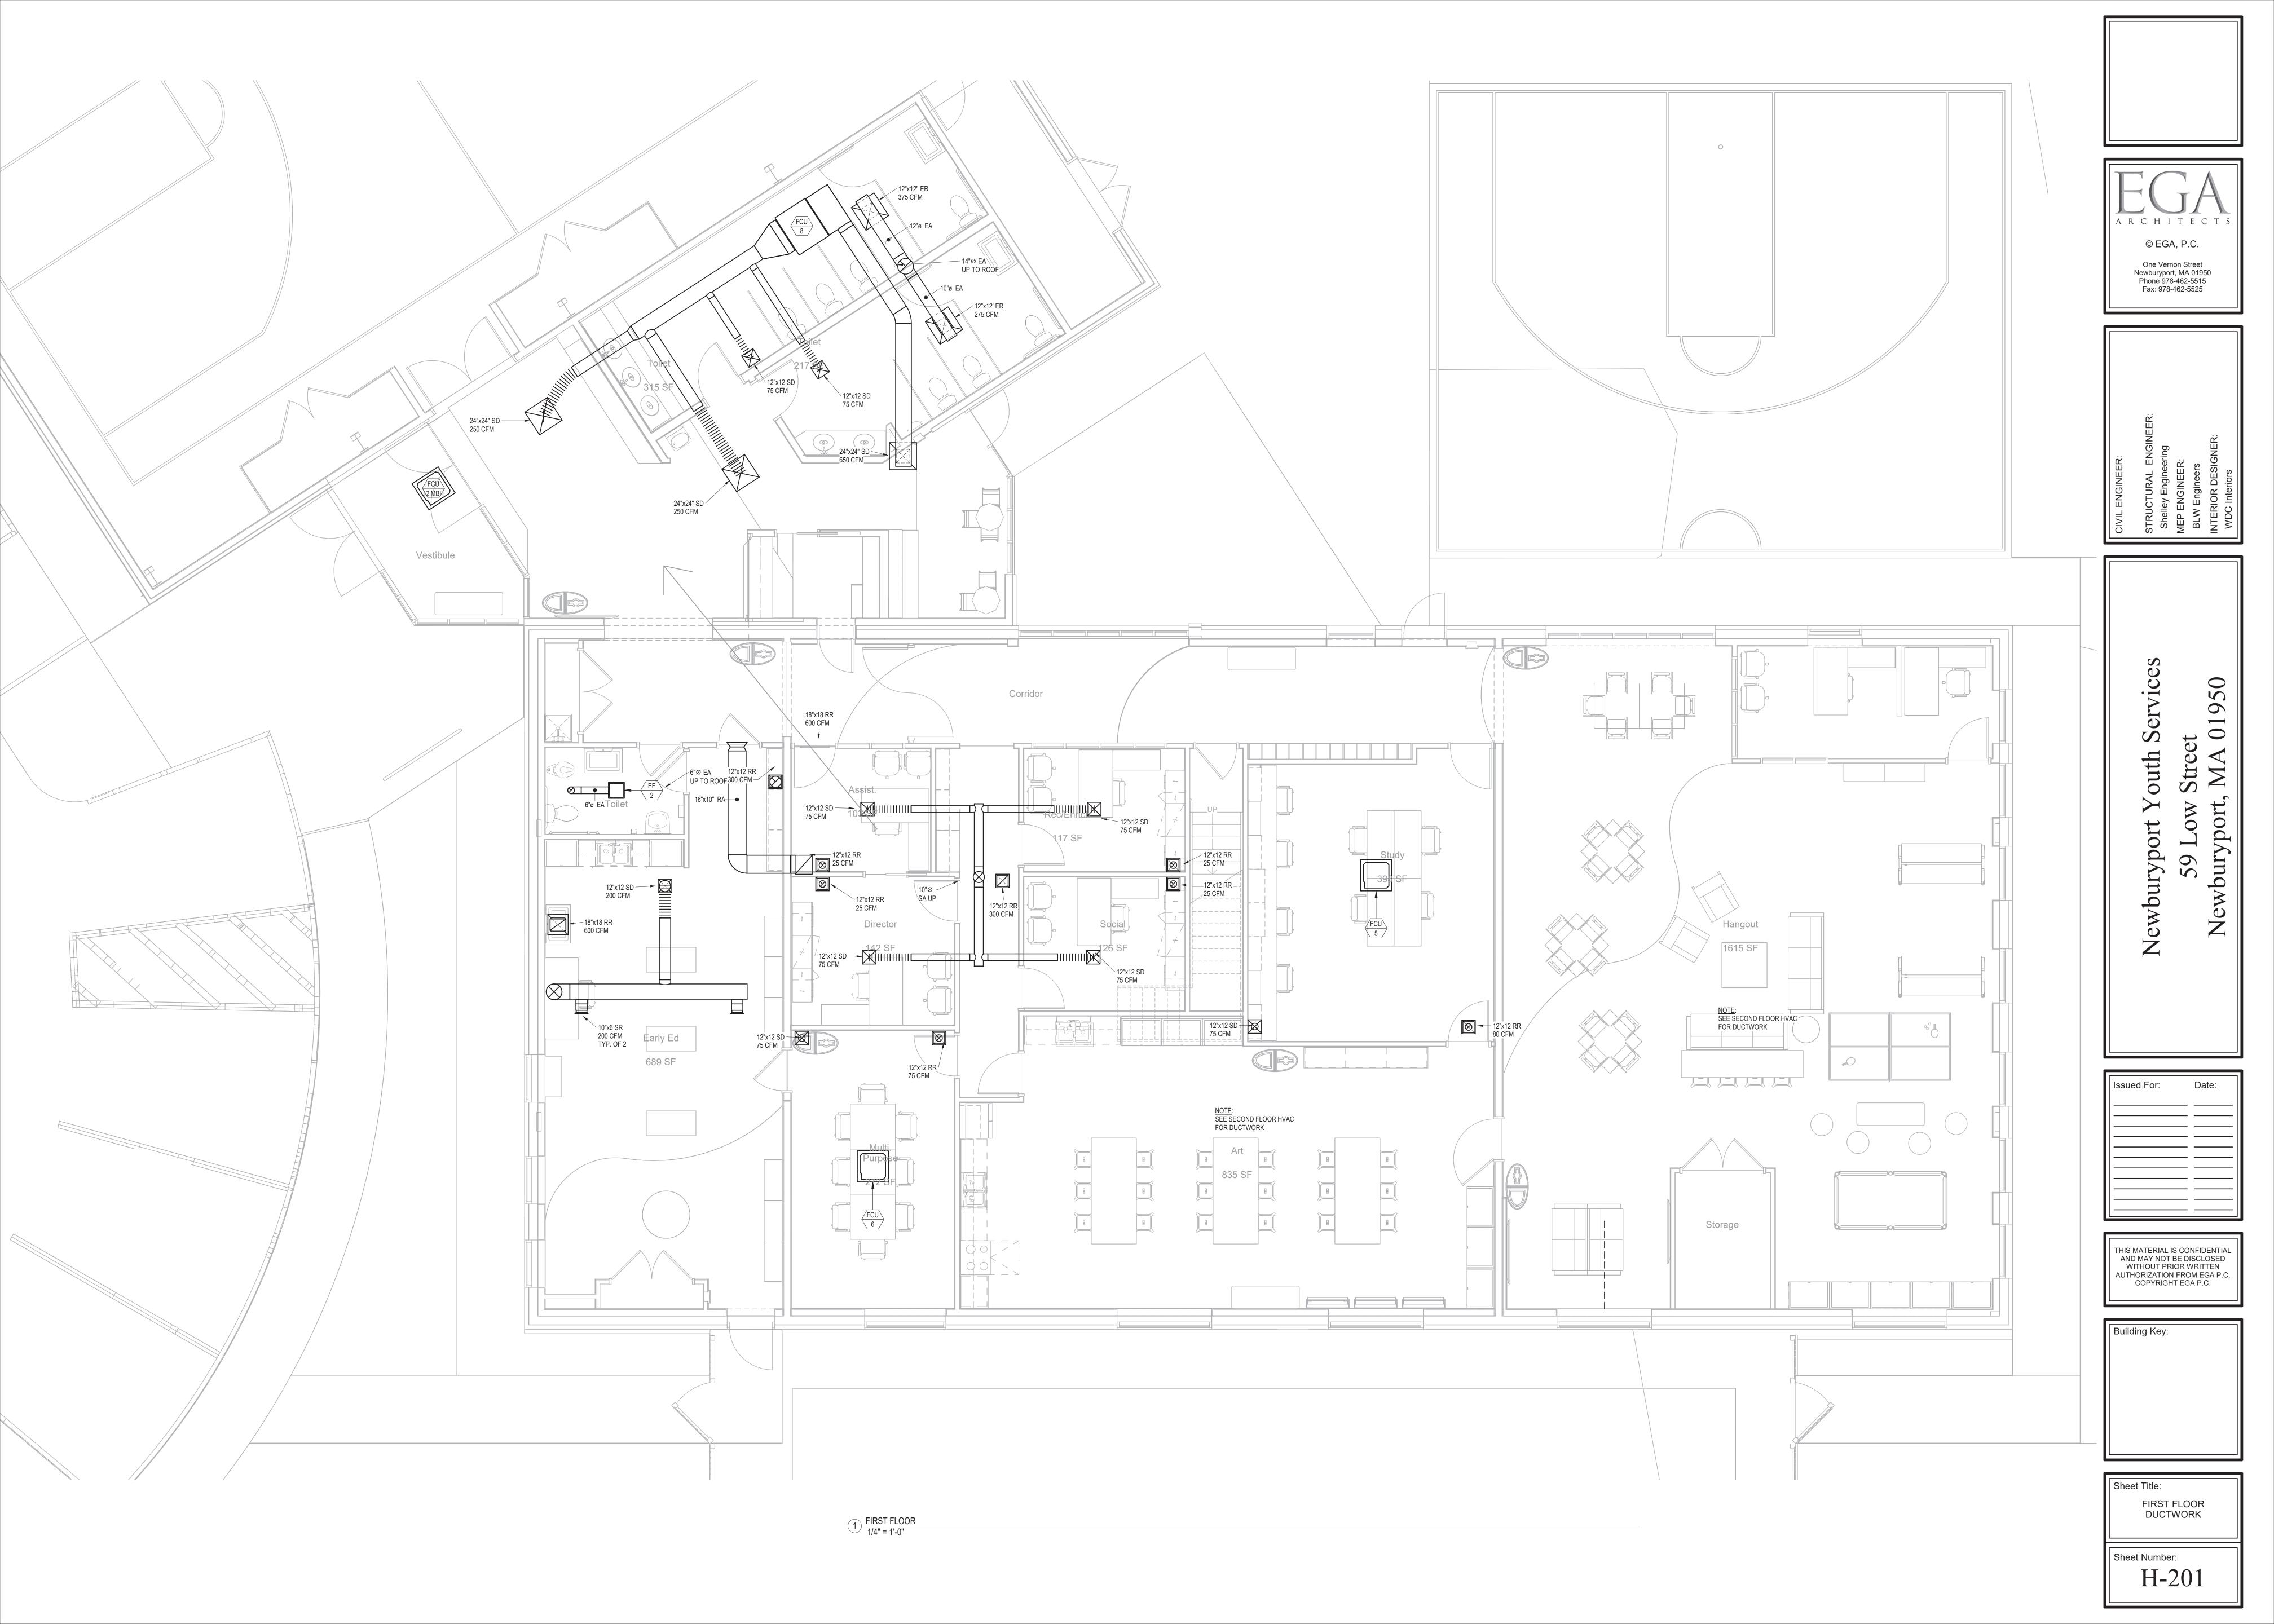


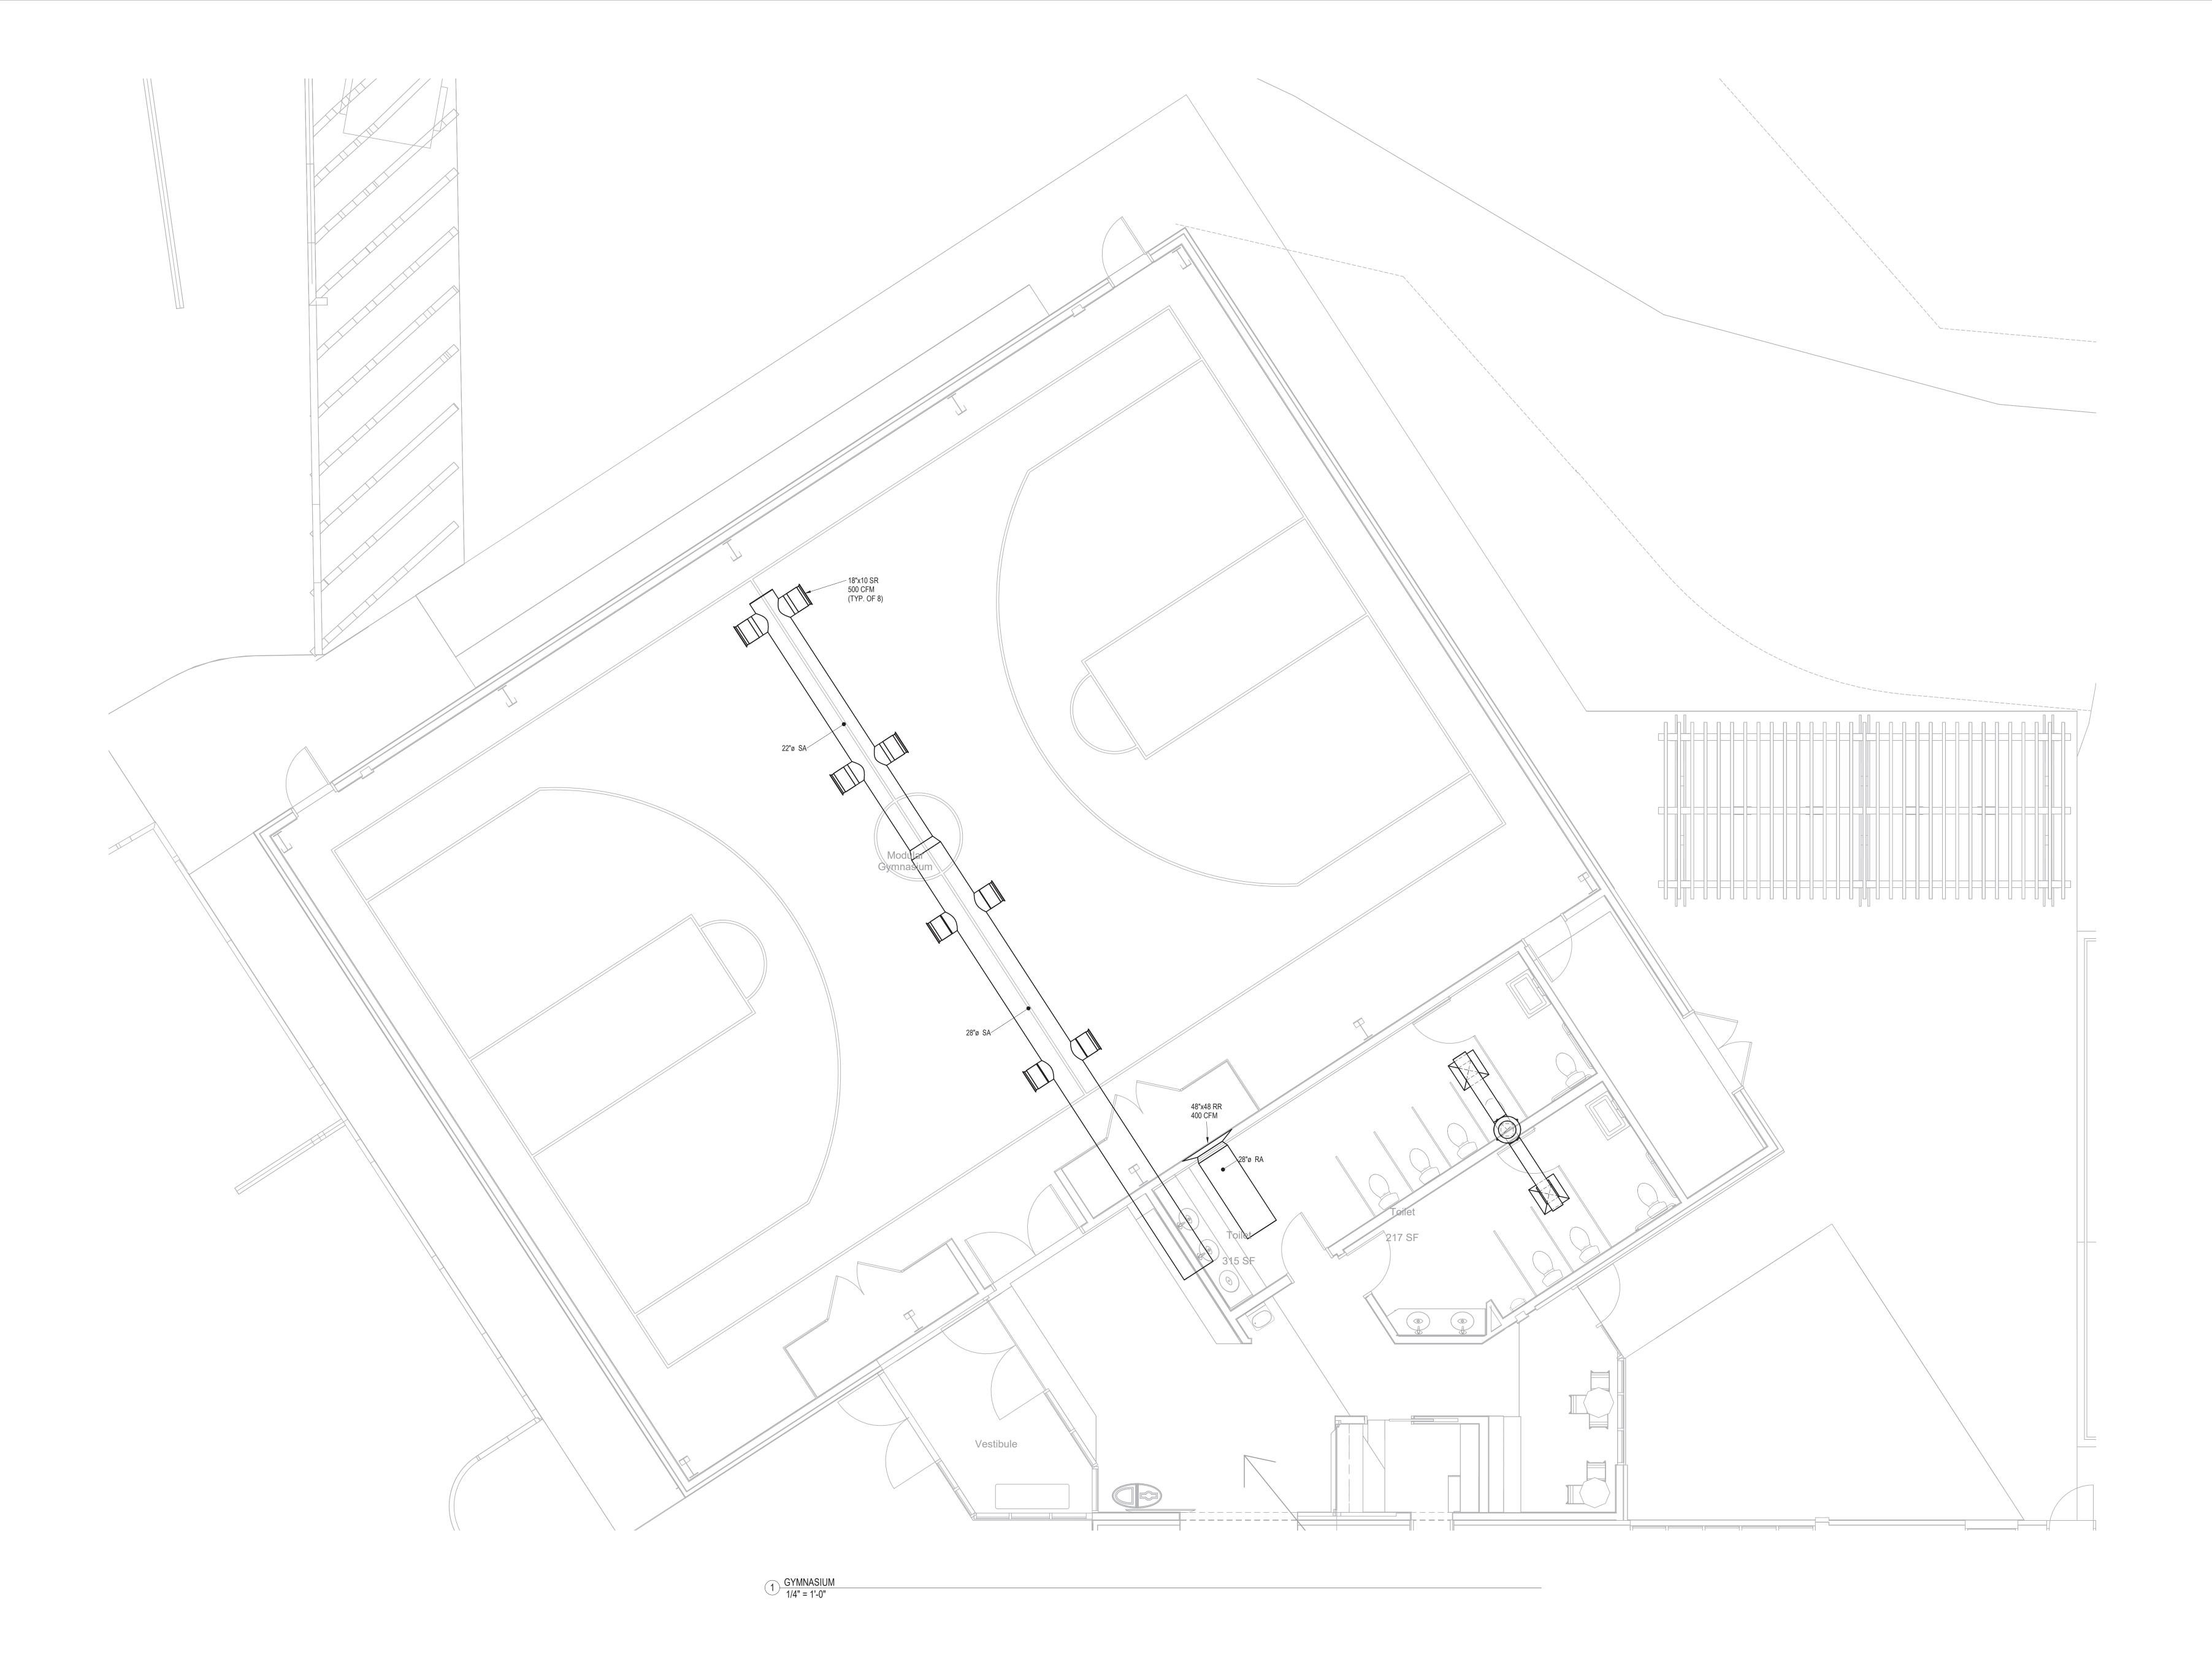


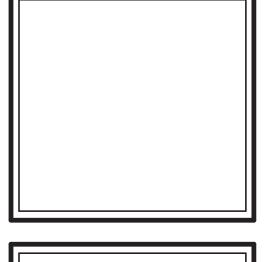




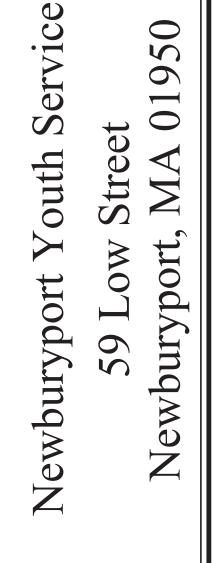

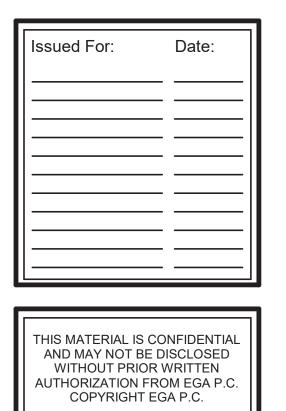

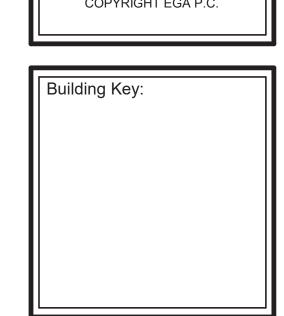


Sheet Title:
GYMNASIUM DUCTWORK
Sheet Number:
H-202

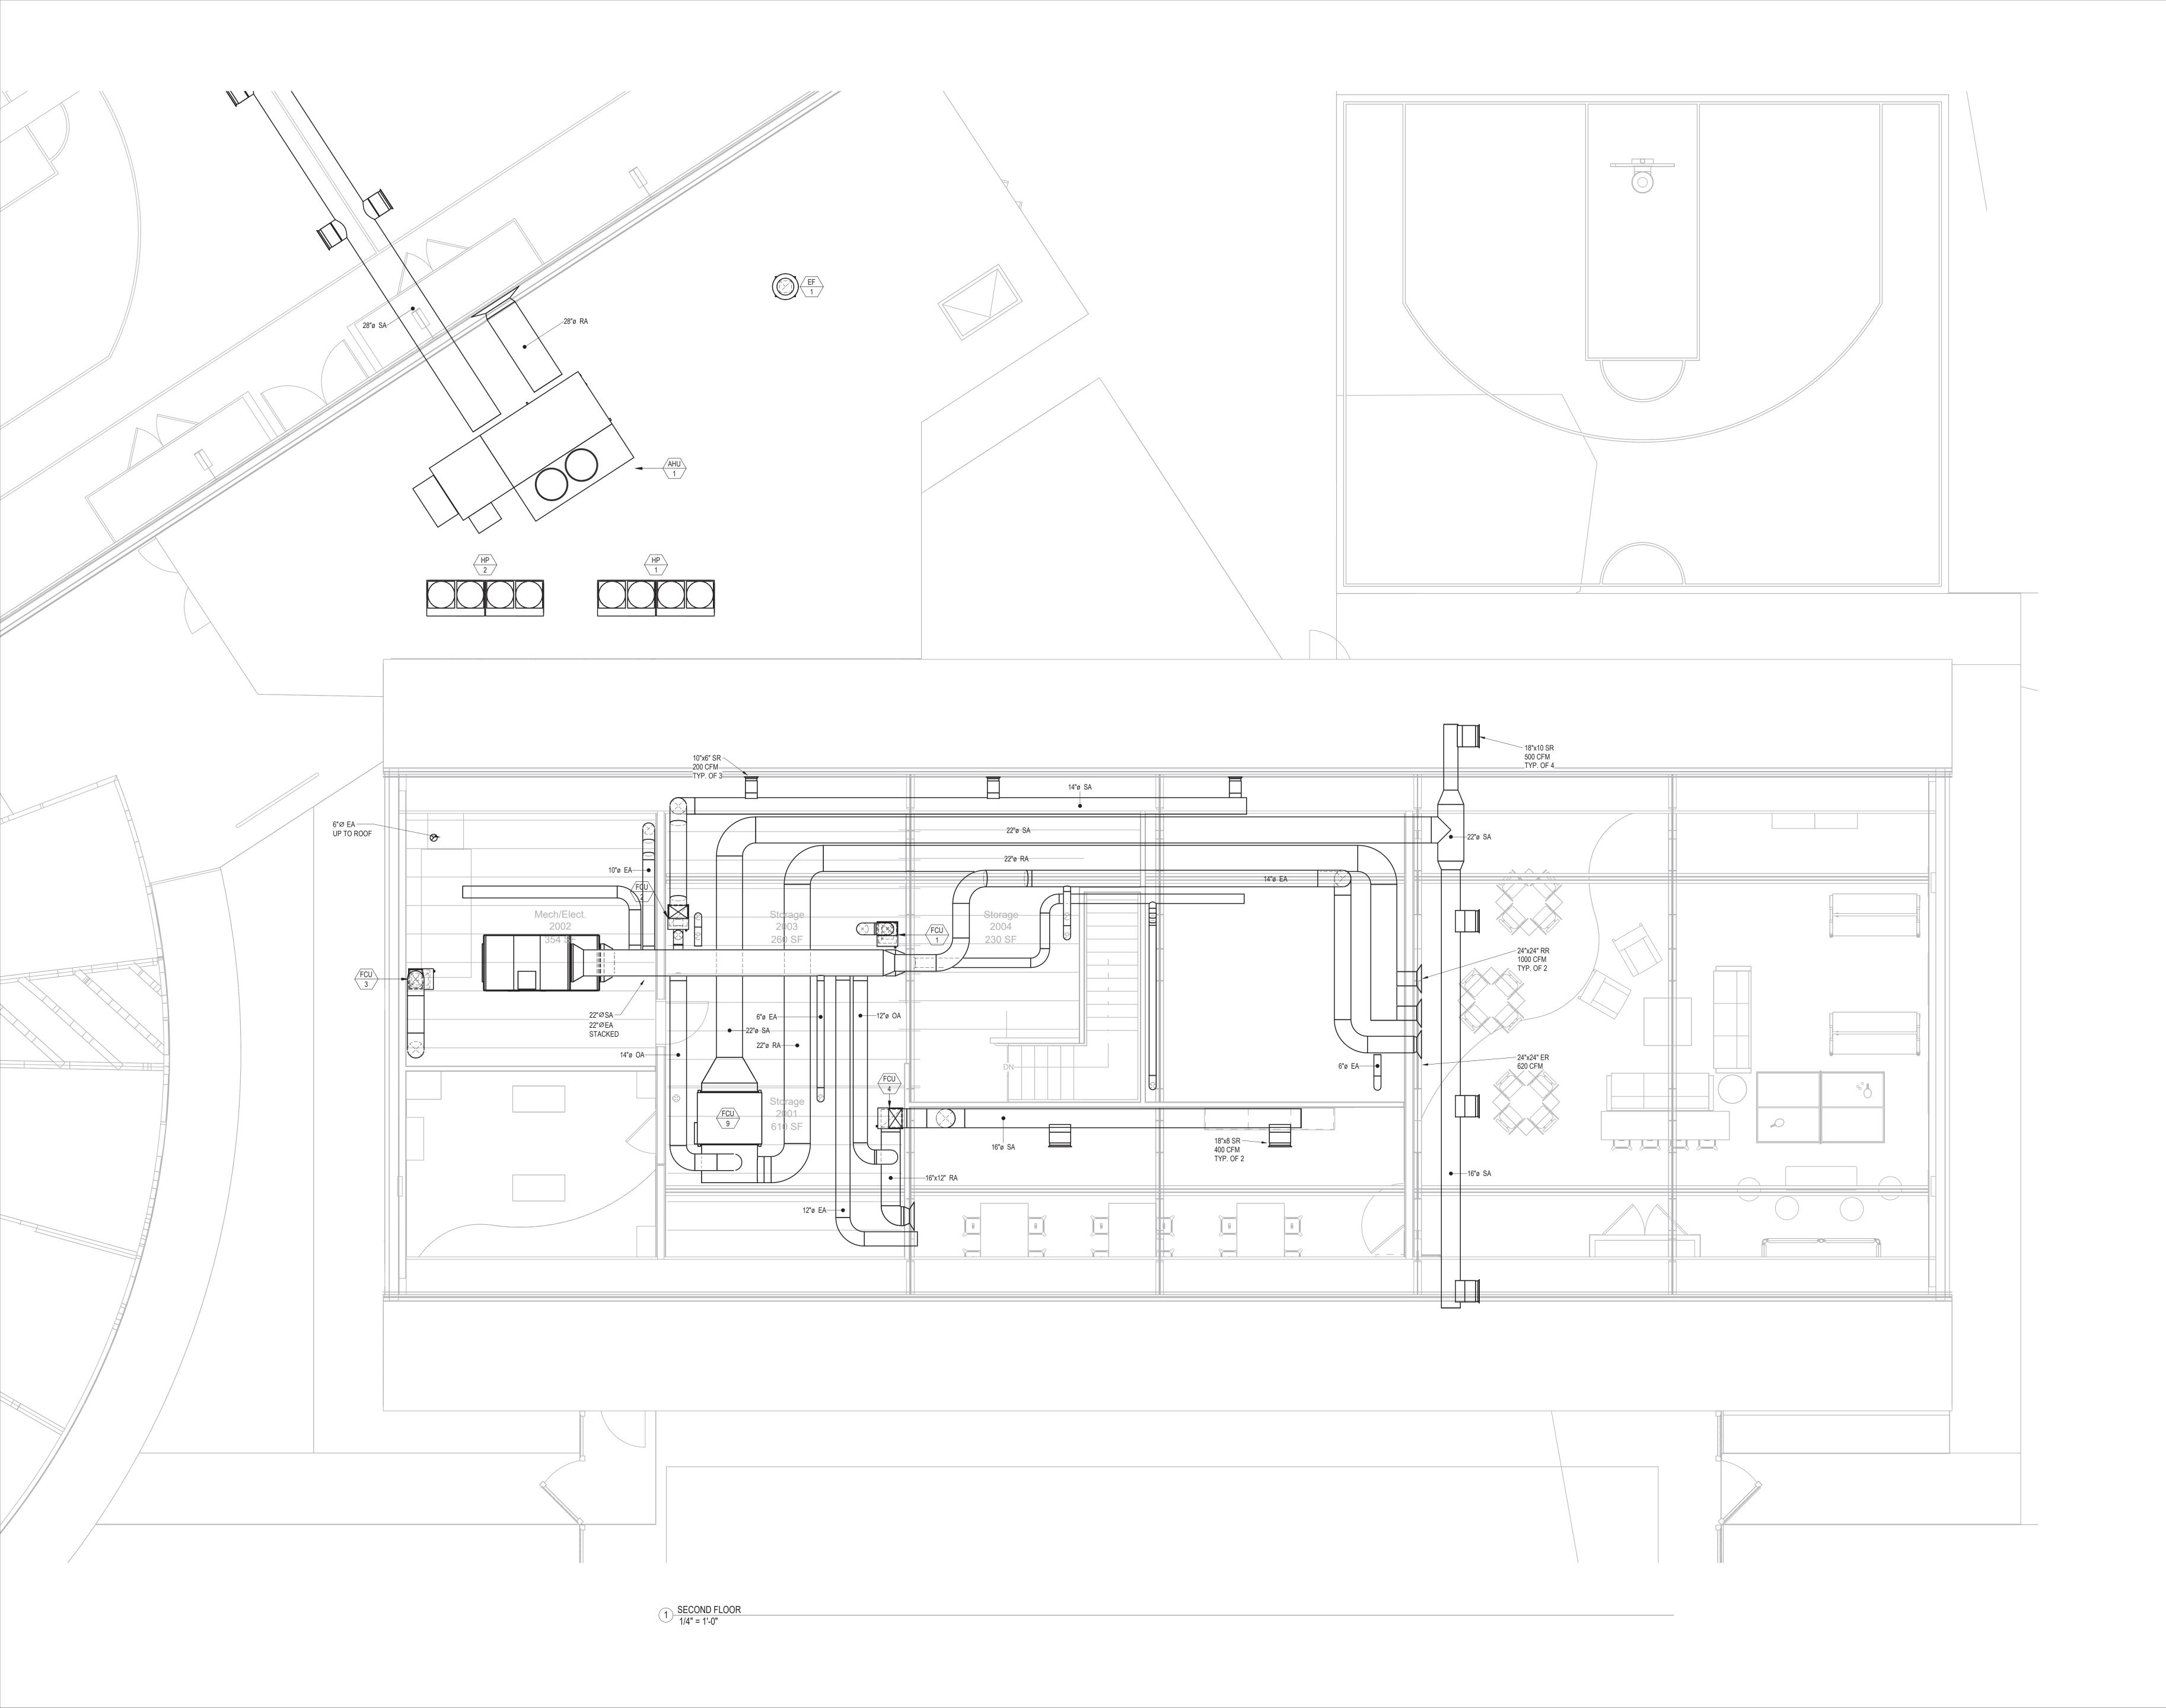







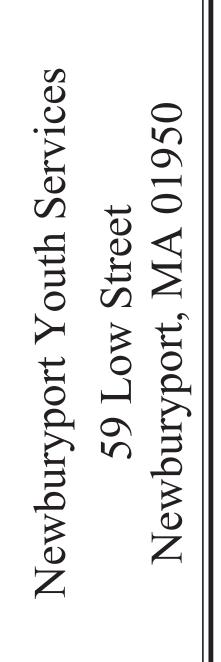


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Sheet Title:
SECOND FLOOR DUCTWORK
Sheet Number:
H-203
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Sheet Title:
ROOF DUCTWORK
Sheet Number:
H-204

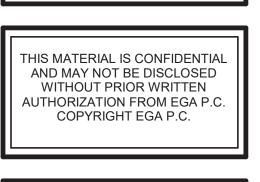	PANELBOARD AND TERMINAL CABINET	Bl	RANCH CIRCUIT AND FEEDER SYMBOLS	GENERAL NOTES
	120/208V PANEL, SURFACE MOUNTED, REFER TO PANEL SCHEDULES TELEPHONE TERMINAL, 4'x8' ¾" PLYWOOD BACKBOARD, PAINTED BLACK MOTORS AND CONTROLS	REFER TO CONCEALE NUMBER C PP1-2 UNLESS NO 20A/	I TO PANELBOARD "PP1", CIRCUIT NUMBER "2 PANEL SCHEDULE FOR BREAKER SIZE AND NUMBER OF POLES ED UNLESS OTHERWISE NOTED OF ARROWS INDICATES NUMBER OF INDIVIDUAL HOMERUNS "2", "4", AND "6" OTED OTHERWISE, WIRING FOR EACH CIRCUIT SHALL BE: 1P - 2#12,#12G-34"C	1. LEGEND IS INTENDED TO SHOW DEPICTION OF SYMBOLS. IT DOES NOT IMPLY INTENT OF SCOPE. NOT ALL SYMBOLS SHOWN ON THIS LEGEND WILL BE USED ON THE DWGS. 2. REFER TO ARCHITECTURAL PLANS AND ELEVATIONS FOR MOUNTING HEIGHTS AND EXACT LOCATIONS OF ALL DEVICES. 3. PERFORM WORK AND PROVIDE MATERIALS AND EQUIPMENT TO MAKE INSTALLATION COMPLETE IN EVERY DETAIL UNDER THIS CONTRACT.
(1)	MOTOR, NUMERAL INDICATES HORSEPOWER	20A/3	2P - 3#12,#12G- ¾ "C 3P - 4#12,#12G- ¾ "C	3. WHETHER OR NOT SPECIFICALLY SHOWN ON DRAWINGS.
(½)	MANUAL MOTOR STARTER, RATED 20A, 250V, COORDINATE MOUNTING HEIGHT IN FIELD, MOUNTING HEIGHT SHALL NOT	HOMEDIIN	OR MULTIPLE HOMERUNS MAY BE COMBINED IN CONDUIT IN ACCORDANCE WITH NEC REQUIREMENTS I FEEDER / BRANCH CIRCUIT CALLOUT:	ALL EQUIPMENT AND WIRING ON DWGS IS SHOWN DIAGRAMMATICALLY. EXACT LOCATION AND METHOD OF SUPPORT SHALL BE 4. DETERMINED IN THE FIELD, EXCEPT WHERE SPECIFIC DIMENSIONS AND DETAILS ARE SHOWN. ALL CONDUIT RUNS SHALL BE RIGIDLY
5 _M	EXCEED 6'-7" AFF	4#1,#6G-1½"C NOMERON	CATES (3) #1 AWG (PHASE), (1) #1 AWG (NEUTRAL), (1) #6 GROUND IN A 1-½" CONDUIT	SUPPORTED.
60A 3R □ →	DISCONNECT SWITCH RATED 30A, 3-POLE, IN NEMA TYPE 1 ENCLOSURE, UNLESS OTHERWISE NOTED "3R" INDICATES NEMA TYPE 3R ENCLOSURE "2P" INDICATES 2-POLE, SINGLE PHASE DISCONNECT "60A" INDICATES 60A SWITCH	NUMBER C UNLESS O'	CIRCUIT OR FEEDER CONCEALED UNLESS OTHERWISE NOTED. BRANCH CIRCUIT DIAGONAL LINES INDICATE OF CONDUCTORS, GROUND WIRE(S) NOT INDICATED. MINIMUM SIZE CONDUCTOR #12 AWG AND 3/4" CONDUIT, ITHERWISE NOTED.	COORDINATE WITH ARCHITECTURAL FURNITURE LAYOUTS FOR EXACT LOCATION OF WALL MOUNTED POWER AND COMMUNICATIONS 5. DEVICES. COORDINATE ALL LIGHTING FIXTURES, UNDER CABINET LIGHTING FIXTURES AND SWITCH LOCATIONS WITH ARCHITECTURAL REFLECTED CEILING PLANS AND ELEVATIONS.
60AF 40AT □ 3R	FUSED DISCONNECT SWITCH RATED 30A, 3-POLE, IN NEMA TYPE 1 ENCLOSURE, UNLESS OTHERWISE NOTED "3R" INDICATES NEMA TYPE 3R ENCLOSURE	FLEXIBLE (CONNECTION TO MOTOR OR EQUIPMENT	LIGHTING NOTES
	"2P" INDICATES 2-POLE, SINGLE PHASE DISCONNECT "60AF" INDICATES 60A FUSE SIZE "40AT" INDICATES 40A TRIP RATING		RECEPTACLES AND DEVICES	ALL LIGHTING FIXTURE SPACING DIMENSIONS AND MOUNTING HEIGHTS ARE RECOMMENDED LOCATIONS. SLIGHT VARIATIONS WHERE
	LIGHTING AND CONTROLS HOWN BELOW ARE REPRESENTATIVE. NOT ALL SYMBOLS FROM THE PLANS HAVE BEEN SHOWN ON THIS LEGEND. FIXTURE MBER LOCATIONS ARE ALSO REPRESENTATIVE. ACTUAL TAG AND CIRCUIT NUMBER LOCATIONS MAY VARY ON PLANS.	REFER TO SPECIFICATIONS FOR AD	ER	1. NECESSARY TO AVOID INTERFERENCE SHALL BE DETERMINED IN THE FIELD. 2. WHERE REQUIRED, ADDITIONAL SUPPORT STEEL FOR THE LIGHTING INSTALLATION SHALL BE FURNISHED AND INSTALLED BY ELECTRICAL CONTRACTOR. SEISMIC RESTRAINTS SHALL BE INCLUDED AS PER STATE BUILDING CODE. 3. PROVIDE SEPARATE UN-SWITCHED NEUTRAL TO ALL EXIT SIGNS, EMERGENCY BATTERY UNITS AND EMERGENCY LIGHT FIXTURES CONTAINING EMERGENCY BALLASTS.
Aa	LIGHTING FIXTURE (SEE LIGHTING FIXTURE SCHEDULE) "A" INDICATES LIGHTING FIXTURE TYPE	DOUBLE D	DUPLEX CONVENIENCE RECEPTACLE	
A _ a #	"#" INDICATES CIRCUIT NUMBER "a" INDICATES SWITCH CONTROL	⊕ USB DUPLI	EX CONVENIENCE RECEPTACLE	POWER NOTES
O _#	"NL" INDICATES NIGHT LIGHT (UNSWITCHED) CIRCUIT	_	ROUND FAULT CIRCUIT INTERRUPTING RECEPTACLE	1. NEC - 406.12 TAMPER-RESISTANT RECEPTACLES - IN ALL AREAS SPECIFIED IN 406.12 PARAGRAPHS (1-7) AND ASSEMBLY SUBSETS LISTED IN NEC 518.2, ALL NONLOCKING-TYPE, 125 VOLT, 15 AND 20 AMPERE RECEPTACLES SHALL BE LISTED TAMPER RESISTANT RECEPTACLES.
	EMERGENCY BATTERY UNIT WITH (2) TWO HEADS EXIT SIGN, SHADING INDICATES FACE, ARROW INDICATES DIRECTION OF CHEVRON		OUPLEX GROUND FAULT CIRCUIT INTERRUPTING RECEPTACLE	2 ELECTRICAL CONTRACTOR SHALL CONFIRM ALL NEMA CONFIGURATIONS AND REQUIRED ELECTRICAL REQUIREMENTS OF ALL EQUIPMENT
& Sa	SINGLE POLE SWITCH, RATED 20A, 120/277V, MOUNTING HEIGHT 48" TO CENTERLINE OF TOGGLE SWITCH IN "ON"		I BOX, COORDINATE MOUNTING HEIGHT WITH ARCHITECT, "HT" INDICATES HEAT TRACE PURPOSE RECEPTACLE, REFER TO SPECIAL PURPOSE RECEPTACLE SCHEDULE, "#" INDICATES TYPE	2. SPECIFICATIONS PRIOR TO ROUGH-IN.
S _a	POSITION "a" INDICATES FIXTURE SWITCH CONTROL	TYPICAL FOR ALL RECEPTACLE TYPE		EXISTING EQUIPMENT DESIGNATIONS
S ⁴ S ^D	"3" INDICATES 3-WAY SWITCH CONTROL "4" INDICATES 4-WAY SWITCH CONTROL "D" INDICATES DIMMING CONTROL		INDICATES COUNTERTOP MOUNTING	X EXISTING TO BE REMOVED, REMOVE ALL ASSOCIATE CONDUIT AND CONDUCTORS
<u>.</u>	120/208V LIGHTING CONTROL PANEL	SHADING I	INDICATES TO COORDINATE MOUNTING HEIGHT WITH ARCHITECT	XM EXISTING TO REMAIN
PC	LIGHTING CONTROL SYSTEM DEVICE	SHADING I	INDICATES EMERGENCY RECEPTACLE	XN EXISTING EQUIPMENT TO BE REPLACED WITH NEW, CONNECT NEW EQUIPMENT TO EXISTING CIRCUIT
	"SC" INDICATES SCENE CONTROLLER "TS" INDICATES TOUCH SCREEN "LC" INDICATES LOCAL CONTROL		JND RECEPTACLE INDICATES FLOOR MOUNTING, REFER TO DETAILS	XR EXISTING EQUIPMENT TO BE RELOCATED, JUNCTION AND EXTEND EXISTING CONDUIT AND CONDUCTORS
	"PC" INDICATES LOCAL CONTROL "PC" INDICATES PHOTOCELL, MOUNTED AT HIGHEST POINT ON ROOF FACING NORTH "TC" INDICATES TIMECLOCK, SURFACE MOUNTED	CIRCLE AR	ROUND RECEPTACLE INDICATES CEILING MOUNTING, REFER TO DETAILS	NEW EQUIPMENT TO BE CONNECTED TO NEAREST AVAILABLE BRANCH CIRCUIT, PROVIDE NEW BRANCH CIRCUITRY FROM NEAREST EXISTING DEVICE (TO REMAIN) TO NEW DEVICE AS REQUIRED
TYPICAL SENSOR AN	NOTATION:		TEL / DATA / COMM OUTLETS	XL NEW LOCATION OF EXISTING EQUIPMENT, JUNCTION AND EXTEND CONDUIT AND CONDUCTORS AS REQUIRED
"3" INDICATES 3	IXTURE SWITCH CONTROL WAY SWITCH CONTROL	REFER TO SPECIFICATIONS FOR AD	DDITIONAL TEL / DATA DEVICE DETAILS	
"D" INDICATED	-WAY SWITCH CONTROL DIMMING CONTROL		LEVISION CONNECTION, FLUSH MOUNTING WITH SINGLE GANG BACK BOX AND COVER PLATE WITH	
³ ⊙ ⊢	WALL OCCUPANCY SENSOR, MULTI-TECHNOLOGY, 180°, 300SF OF COVERAGE	— 1 -CONNE	CTOR. NE / COMPUTER OR DATA OUTLET (RJ45), WITH SINGLE GANG BACK BOX AND COVER PLATE, ¾" CONDUIT BACK	
•	CEILING MOUNTED OCCUPANCY SENSOR, LOW VOLTAGE, 360° TWO-SIDED, 2000SF COVERAGE	TO SERVE	ER ROOM	
	MISCELLANEOUS	WAP WIRELESS TYPICAL FOR ALL DEVICE TYPES	S ACCESS POINT	
M	UTILITY METER	BOX AROU	JND DEVICE INDICATES FLOOR MOUNTING, REFER TO DETAILS	
	ANNOTATIONS	CIRCLE AR	ROUND DEVICE INDICATES CEILING MOUNTING, REFER TO DETAILS	
ECH 1	MECHANICAL EQUIPMENT TAG, REFER TO MECHANICAL EQUIPMENT COORDINATION SCHEDULE FOR ELECTRICAL			
	REQUIREMENTS SHEET NOTE TAG		ABBREVIATIONS	
#	"#" INDICATES CALL OUT TO CORRESPONDING SHEET NOTE	A/AMP AMPERE	IMC INTERMEDIATE METALLIC CONDUIT	
<u>/1</u> \	REVISION TAG	\ <u>-</u>	MCC MOTOR CONTROL CENTER MEC MASSACHUSETTS ELECTRICAL CODE WITCH MLO MAIN LUGS ONLY MTD MOUNTED MTG MOUNTING NEC NATIONAL ELECTRICAL CODE No.,# NUMBER NS NON-SYSTEM NTS NOT TO SCALE PC PLUMBING CONTRACTOR PWR POWER RGS RIGID STEEL CONDUIT OR RMS ROOT MEAN SQUARE VALUE RPM REVOLUTIONS PER MINUTE DUIT SF SQUARE FOOT R SN SOLID NEUTRAL ST SHUT TRIP CIRCUIT BREAKER SWBD SWITCHBOARD TION FOR EQUIPMENT (GFPE CB) TYP TYPICAL INTERRUPTER VA VOLT-AMPERE VFD VARIABLE FREQUENCY DRIVE	

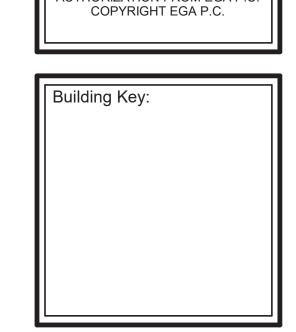

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Building Key:

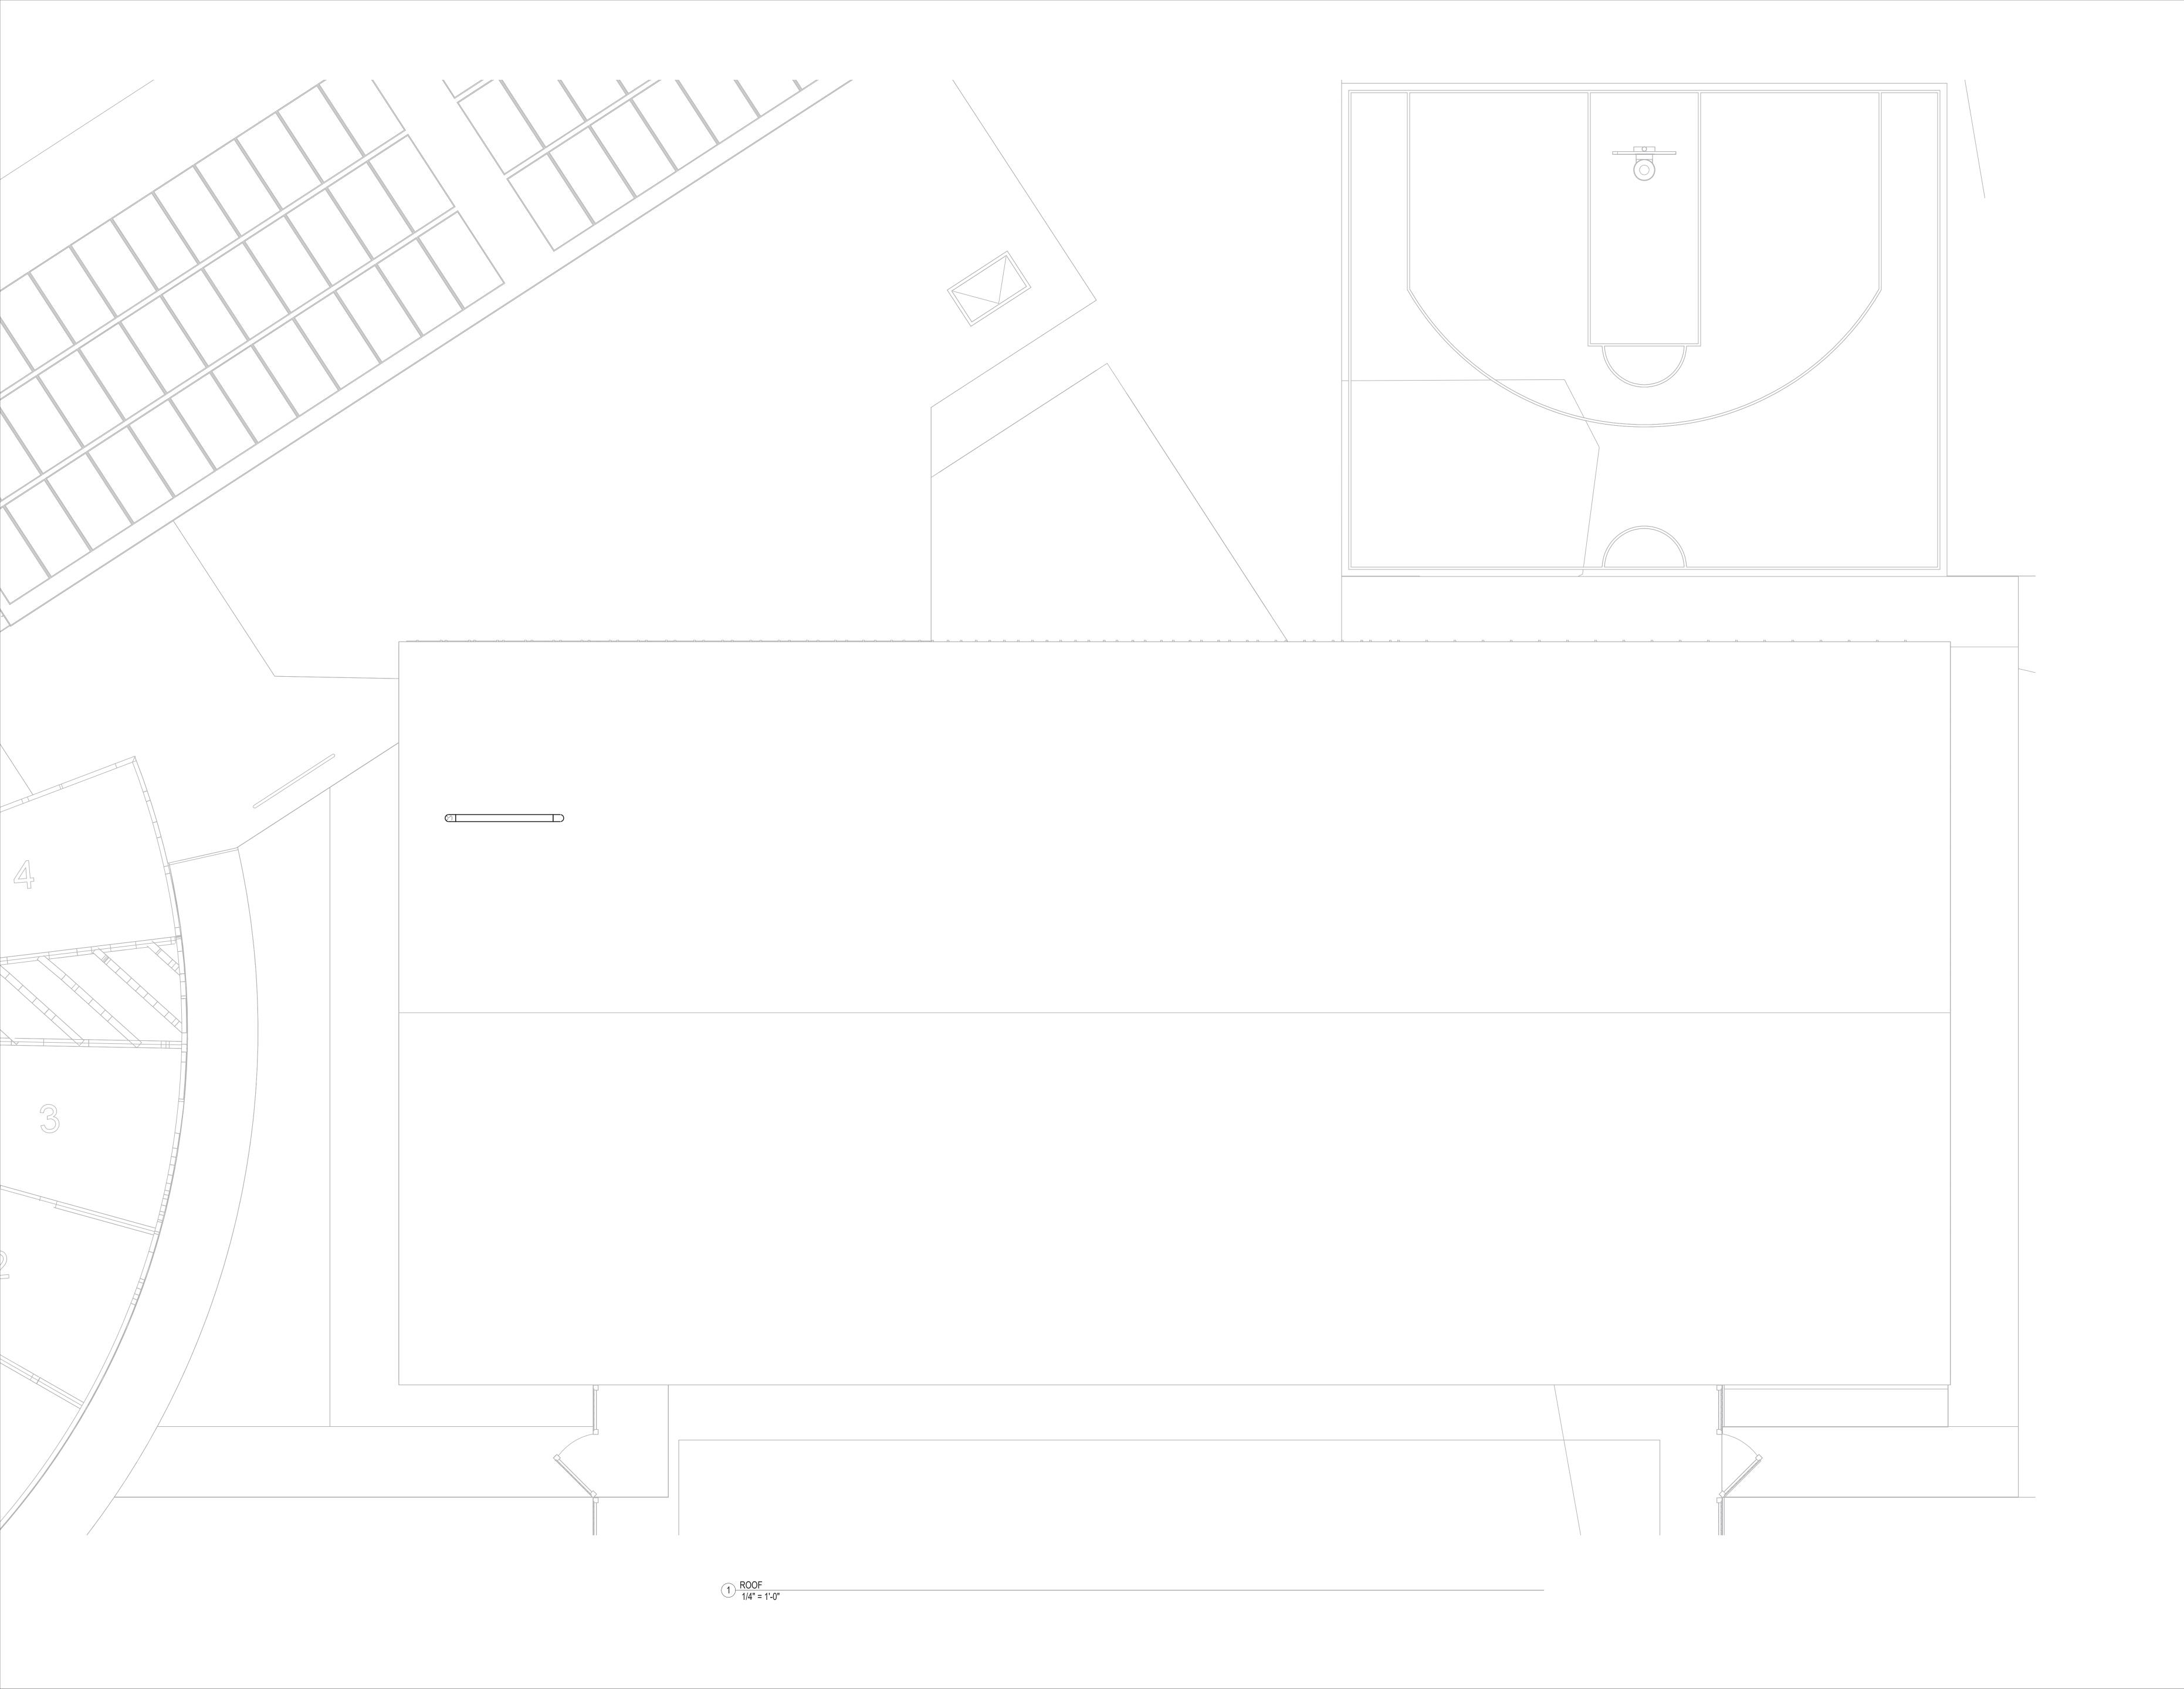Sheet Title:
LEGEND AND
NOTES

Sheet Number:

E001

PART 1 - GENERAL

1. THE OWNERS GENERAL CONDITIONS, SPECIAL CONDITIONS AND SUPPLEMENTAL CONDITIONS OR REQUIREMENTS ARE PART OF THIS

EXAMINATION OF SITE AND CONTRACT DOCUMENT: BEFORE SUBMITTING HIS PROPOSAL, THIS CONTRACTOR SHALL VISIT THE PREMISE AND 7.3. REVIEW THE ENTIRE PROJECT. THE CONTRACTOR SHALL DETERMINE THE DIFFICULTIES, CONDITIONS, AND DISPOSAL REQUIREMENTS WHICH MAY BE ENCOUNTERED DURING THE WORK. ALL CHARGES RELATED TO MEETING THE INTENT OF THE DRAWINGS AND

SPECIFICATIONS SHALL BE INCORPORATED INTO THE BID. IF DISCREPANCIES ARISE BETWEEN THE DRAWINGS AND SPECIFICATIONS, THE

3. THE INSTALLATION OF ALL ELECTRICAL SYSTEMS SHALL CONFORM TO THE REQUIREMENTS OF THE STATE BUILDING CODE, ELECTRIC CODE, NATIONAL FIRE PROTECTION ASSOCIATION AND ALL OTHER APPLICABLE FEDERAL, STATE AND LOCAL LAWS AND ORDINANCES.

MORE STRINGENT REQUIREMENT SHALL APPLY. NO ADDITIONAL CHARGES WILL BE ALLOWED DUE TO EXISTING CONDITIONS.

- 4. ALL MATERIALS SHALL BE NEW AND SHALL BEAR THE UNDERWRITERS' LABEL. SHALL BE PROVIDED IN QUANTITIES NECESSARY TO
- COMPLETE THE WORK AND SHALL BARE ALL APPLICABLE LABELS FOR INTENDED USE. 5. OBTAIN AND PAY FOR ALL REQUIRED PERMITS, LICENSES AND CERTIFICATES, INCLUDE ALL FEDERAL, STATE AND LOCAL TAXES.
- WORKMANSHIP: THE ENTIRE WORK PROVIDED IN THIS SPECIFICATION SHALL BE CONSTRUCTED AND FINISHED IN EVERY RESPECT IN A WORKMANLIKE AND SUBSTANTIAL MANNER. EQUIPMENT SHALL BE SECURELY INSTALLED PLUMB AND/OR LEVEL. NO ELECTRICAL EQUIPMENT SHALL BE SUPPORTED BY WORK OF OTHER TRADES. OBTAIN DETAILED INFORMATION FROM THE MANUFACTURERS OF APPARATUS AS TO THE PROPER METHOD OF INSTALLING AND CONNECTING EQUIPMENT. OBTAIN ALL INFORMATION FROM THE GENERAL CONTRACTOR AND OTHER SUBCONTRACTORS, WHICH MAY BE NECESSARY TO FACILITATE WORK AND THE COMPLETION OF THE WHOLE
- 7. DRAWINGS ARE DIAGRAMMATIC AND INDICATE GENERAL ARRANGEMENT OF SYSTEMS. PROVIDE DEVICES AND COMPONENTS SHOWN ON PLANS BUT NOT ON RISERS AND VICE VERSA AS IF EXPRESSLY SHOWN ON BOTH.
- 8. THE ELECTRICAL CONTRACTOR (EC) SHALL VERIFY THE LOCATIONS AND MOUNTING HEIGHTS OF ALL EQUIPMENT, LIGHT FIXTURES, PANELBOARDS, OUTLETS AND MECHANICAL EQUIPMENT WITH THE OWNER OR ARCHITECT PRIOR TO COMMENCING ANY WORK.
- 9. THE EC SHALL NOT BORE, NOTCH OR IN ANY WAY CUT INTO THE STRUCTURAL MEMBER, WITHOUT PROPER WRITTEN APPROVAL OF THE
- STRUCTURAL ENGINEER. 10. EXAMINE ALL DRAWINGS FOR REQUIREMENTS WHICH AFFECT THE WORK OF THIS SECTION. COORDINATE WORK WITH OTHER TRADES. 11. THE ELECTRICAL CONTRACTOR SHALL PROVIDE A COMPLETE TEMPORARY LIGHTING AND POWER SYSTEM FOR THE CONSTRUCTION OF THE

PROJECT AND SHALL PAY FOR THE COST OF INSTALLATIONS. THE E.C. SHALL INCLUDE ALL CHARGES FROM THE UTILITY COMPANY TO

- CONNECT AND DISCONNECT THE TEMPORARY SERVICE. THE COST OF ELECTRICITY SHALL BE BY THE OWNER OR GENERAL CONTRACTOR. 12. RECORD DRAWINGS: IN ACCORDANCE WITH REQUIREMENTS, FURNISH AND KEEP IN THE JOB AT ALL TIMES, TWO (2) COMPLETE AND SEPARATE SETS OF BLACKLINE PRINTS OF THE ELECTRICAL WORK ON WHICH SHALL BE CLEARLY, NEATLY AND ACCURATELY NOTED, PROMPTLY AS THE WORK PROGRESSES, ALL ELECTRICAL CHANGES, REVISIONS AND ADDITIONS TO THE WORK. WHENEVER WORK IS INSTALLED OTHERWISE THAN AS SHOWN ON THE CONTRACT DRAWINGS, SUCH CHANGES SHALL BE NOTED AT THE CONCLUSION OF WORK,
- PREPARE RECORD DRAWINGS IN ACCORDANCE WITH GENERAL CONDITIONS. 13. THE COMPLETED ELECTRICAL INSTALLATION SHALL BE GUARANTEED IN WRITING BY THE ELECTRICAL CONTRACTOR TO BE FREE FROM DEFECTS OF MANUFACTURE AND INSTALLATION FOR A PERIOD OF ONE YEAR FROM THE DATE OF WRITTEN ACCEPTANCE BY THE OWNER. ANY FAULT DUE TO DEFECTIVE OR IMPROPER MATERIAL, EQUIPMENT WORKMANSHIP OR DESIGN WHICH MAY DEVELOP SHALL BE MADE

GOOD FORTHWITH BY, AND AT THE EXPENSE OF THE ELECTRICAL CONTRACTOR, INCLUDING ALL OTHER DAMAGES DONE TO AREAS,

- MATERIALS AND OTHER SYSTEMS RESULTING FROM THIS FAILURE. 14. THE EC SHALL NOTIFY THE OWNER/ENGINEER UPON: (1) COMPLETION OF ALL ROUGH WIRING BEFORE CLOSURE OF ALL WALLS AND (2) UPON "SUBSTANTIAL COMPLETION" OF ALL ELECTRICAL WORK. AFTER SUBSTANTIAL COMPLETION, THE OWNER'S REPRESENTATIVE SHALL
- 15. RELATED WORK BY OTHERS 15.1. THERMOSTATS AND CONTROL WIRING SHALL BE SUPPLIED AND INSTALLED BY THE HVAC CONTRACTOR.
- 15.2. STARTERS FOR MECHANICAL EQUIPMENT SHALL BE SUPPLIED BY THE MECHANICAL CONTRACTOR, INSTALLED AND WIRED BY THE ELECTRICAL CONTRACTOR, U.N.O. 15.3. DUCT SMOKE DETECTORS ARE PURCHASED AND SUPPLIED BY THE ELECTRICAL CONTRACTOR. THE MECHANICAL CONTRACTOR SHALL INSTALL DUCT SMOKE DETECTORS IN DUCT AND PROVIDE SHUTDOWN CONTROL WIRING FROM THE DUCT SMOKE DETECTOR TO THE
- 15.4. CUTTING, PATCHING AND TRENCHING SHALL BE PROVIDED BY THE GENERAL CONTRACTOR.
- 16. SUBMITTALS: EC SHALL PROVIDE ELECTRONIC PDF SUBMITTALS FOR ELECTRICAL EQUIPMENT TO THE ENGINEER FOR APPROVAL PRIOR TO 10. PANELBOARDS: PROVIDE DEAD FRONT LIGHTING AND POWER PANEL BOARDS WITH PROPER VOLTAGE AND AMP RATING AS REQUIRED. CONSTRUCTION. SUBMITTALS SHALL INDICATE ALL MATERIALS, DIMENSIONS AND RATINGS. PROVIDE INFORMATION ON THE FOLLOWING 16.1. SWITCHES AND RECEPTACLES

MOTOR CONTROLLER. WIRING FROM THE DUCT SMOKE DETECTOR TO THE FIRE ALARM CONTROL PANEL SHALL BE PROVIDED BY THE

- 16.2. PANELBOARDS 16.3. SWITCHBOARDS
- 16.4. LIGHTING FIXTURES AND CONTROLS 16.5. ALL FIRE DETECTION SYSTEM COMPONENTS
- 16.6. CIRCUIT BREAKERS 16.7. FUSIBLE SWITCHES
- 16.8. WIRING DEVICES 16.9. CONDUIT & WIRE 16.10. FIRE ALARM (EQUIPMENT CUTS, RISERS, WIRE SIZING, ETC)

EXEMPTION FROM THE REQUIREMENTS.

- 16.11. TEST REPORTS 16.12. SUBSTITUTIONS SHOULD BE NOTED WHEN SUBMITTED WITH AN EXPLANATION FOR THE SUBSTITUTION. 16.13. ELEVATIONS OF ALL ELECTRIC ROOMS, WITH PROPOSED MANUFACTURER'S EQUIPMENT SHALL BE SUBMITTED TO SHOW COMPLIANCE
- 16.14. THE ACCEPTANCE OF SYSTEMS, EQUIPMENT AND DATA SHEETS IS A GENERAL APPROVAL SUBJECT TO THE CONTRACT DRAWINGS, SPECIFICATIONS, AND VERIFICATION OF ALL MEASUREMENTS AT THE JOB. ACCEPTANCE DOES NOT RELIEVE THE ELECTRICAL CONTRACTOR FROM THE RESPONSIBILITY OF DATA SHEET ERRORS OR OMISSIONS. QUANTITY OF ITEMS INDICATED ON SUBMITTAL IS THE RESPONSIBILITY OF THE ELECTRICAL CONTRACTOR.

PART 2 - PRODUCTS

- 1.1. AS PART OF THIS CONTRACT, THE ELECTRICAL CONTRACTOR SHALL FURNISH AND INSTALL ALL ELECTRICAL EQUIPMENT, DEVICES, MATERIALS AND EQUIPMENT NECESSARY TO MAKE THE INSTALLATION COMPLETE AND OPERATIONAL IN EVERY DETAIL, WHETHER OR
- NOT SPECIFICALLY INDICATED ON THE DRAWINGS OR SPECIFIED HEREIN ALL MATERIALS AND EQUIPMENT SHALL BE NEW AND INCLUDE A MANUFACTURERS WARRANTY IT IS THE INTENT OF THE SPECIFICATIONS THAT ONE MANUFACTURER BE SELECTED, NOT A COMBINATION, FOR ANY PARTICULAR CLASSIFICATION OF MATERIAL; FOR EXAMPLE, ALL WIRE OF ONE MANUFACTURER, ALL SWITCHES OF ONE MANUFACTURER, ETC., EXCEPT SPECIFIC MATERIAL CLASSIFICATIONS IN WHICH DELIVERY TIME BECOMES A PROBLEM. THE ENGINEER MAY GIVE SPECIFIC
- 1.4. WHERE MATERIALS, EQUIPMENT, APPARATUS, OR OTHER PRODUCTS ARE SPECIFIED BY MANUFACTURER, BRAND NAME, TYPE OR CATALOG NUMBER, SUCH DESIGNATION IS TO ESTABLISH STANDARDS OF PERFORMANCE, QUALITY, TYPE, AND STYLE.
- 2. FEEDERS: ALL FEEDERS BETWEEN PANELBOARDS AND SWITCHBOARDS SHALL BE PROVIDED IN TYPE EMT OR GRS CONDUIT; TYPE MC CABLE IS NOT PERMITTED, UNLESS NOTED OTHERWISE.
- 3. CONCEALED BRANCH CIRCUITS: ALL BRANCH CIRCUIT WIRING SHALL BE CONCEALED WHENEVER POSSIBLE. WITHIN CONCEALED SPACES SUCH AS ABOVE HUNG CEILING AREAS AND WITHIN WALL PARTITIONS
- BRANCH CIRCUIT WIRING SHALL BE TYPE MC CABLE, 12/2 OR 12/3 WITH FULL SIZE INSULATED GROUND WIRE. 3.2. MC TYPE CABLE MAY BE UTILIZED FOR FOR POWER AND LIGHTING CIRCUITS.

4.1. ALL CONDUIT SHALL BE RUN CONCEALED UNLESS NOTED OTHERWISE.

- 4.2. ALL EXPOSED, OR SURFACE MOUNTED BRANCH CIRCUIT RUNS ABOVE 8'-0" SHALL BE INSTALLED USING TYPE EMT CONDUIT. BELOW
- 8'-0" RIGID GALVANIZED STEEL CONDUIT SHALL BE INSTALLED.MINIMUM SIZE CONDUIT USED SHALL BE 3/4". PROVIDE FIRE RESISTANT RATING AROUND ALL CONDUITS PENETRATING THROUGH FIRE RATED WALLS OR FLOORS. RATING OF FIRE PROOFING SHALL MATCH RATING OF WALLS. 4.4. ALL CONDUIT AND EQUIPMENT SHALL BE INSTALLED AND GROUNDED IN ACCORDANCE WITH THE LATEST RULES AND REGULATIONS OF THE NATIONAL ELECTRICAL CODE.
- 4.5. ALL CONDUITS SHALL HAVE A PROPER SIZE GROUNDING CONDUCTOR. ALL CONNECTIONS TO MACHINERY AND EQUIPMENT SUBJECT TO VIBRATION SHALL BE MADE WITH FLEXIBLE LIQUIDTIGHT CONDUIT, NOT IN EXCESS OF 6'-0". PROVIDE SUFFICIENT SLACK TO PREVENT VIBRATION TRANSMISSION.
- PROVIDE EXPANSION FITTINGS ON ALL CONDUIT PASSING THROUGH BUILDING EXPANSION JOINTS. CONDUITS ARE SHOWN DIAGRAMMATICALLY EXACT LOCATION AND METHOD OF SUPPORT SHALL BE DETERMINED BY FIELD
- CONDITIONS. ALL CONDUITS SHALL BE RIGIDLY SUPPORTED. 5. WIRING: WIRING SHALL BE A MINIMUM OF #12 AWG SOLID. ALL WIRE AND CABLE SHALL BE COPPER; NO ALUMINUM IS PERMITTED, WITHOUT APPROVAL OF THE OWNER/ENGINEER ON A VALUE ENGINEERING BASIS. WIRE AND CABLE SHALL BE MANUFACTURED BY PHELPS DODGE
- COPPER PRODUCTS CORP., GENERAL CABLE CO., TRIANGLE CONDUIT AND CABLE CO., OR EQUAL. NON-METALIC CONDUIT TYPE NMC/ROMEX SHALL ONLY BE ALLOWED WITH OWNER/ENGINEER APPROVAL & MUST BE ALLOWED BY CODE & BE INSTALLED IN ACCORDANCE WITH CODE REQUIREMENTS.
- AWG #8 & LARGER SHALL BE STRANDED, AWG #10 AND SMALLER SHALL BE SOLID. ALL WIRING (LOW VOLTAGE, TEL/DATA, FIRE ALARM, POWER BRANCH CIRCUIT) SHALL BE PLENUM RATED; NO EXCEPTIONS.
- NON-PLENUM RATED CABLES OF ANY KIND SHALL NOT BE PROVIDED. ALL NEW WIRING SHALL BE THHN/THWN RATED 75-90 DEGREES, 600V. WET-DRY LOCATIONS. BRANCH CIRCUITS LONGER THAN 150 FEET FOR 120V OR 250FT FOR 277V SHALL BE AT LEAST #10AWG FROM PANEL TO LAST OUTLET.
- CIRCUITING SHOWN ON THE DWGS IS DIAGRAMMTIC PROVIDE COMPLETE WIRING SYSTEM WHETHER OR NOT INDICATED 5.5. PROVIDE AT LEAST ONE HOT AND ONE NEUTRAL CONDUCTOR FOR ALL INDIVIDUAL BRANCH CIRCUIT WIRING.
- 6.1. ALL GROUNDING SHALL BE PERFORMED IN ACCORDANCE WITH THE NATIONAL ELECTRICAL CODE ARTICLE 250, AS AMENDED BY LOCAL
- PROVIDE A COMPLETE GROUNDING ELECTRODE SYSTEM AND EQUIPMENT GROUNDING SYSTEM CONDUCTORS UTILIZED FOR GROUNDING AND BONDING SHALL HAVE TYPE "THHN" OR BETTER INSULATI
- 6.4. FOR EACH FEEDER OR RUN OF LIGHTING AND APPLIANCE BRANCH CIRCUITRY, INCLUDE EQUIPMENT AND RACEWAY GROUNDING CONDUCTORS RUN WITHIN THE RACEWAYS. THE INDICATED QUANTITIES OF CONDUCTORS DO NOT INCLUDE THE GROUND WIRES.

- OUTLET BOXES AND ACCESSORIES: STEEL OR FIRE RATED ELECTRICAL BOXES (SWITCHES, OUTLETS, JUNCTION BOXES, ETC) SHALL BE PROVIDED AND INSTALLED IN ALL FIRE RATED ASSEMBLIES AS IN ACCORDANCE WITH BUILDING & ELECTRICAL CODES. PROVIDE UL LISTED MOLDABLE PUTTY PADS TO SEAL ANNULAR SPACES/PENETRATIONS AROUND ALL JUNCTION BOXES.
- 7.1.1. FIRE RATED ASSEMBLIES INCLUDE EXTERIOR WALLS, FIRE RATED WALL, FLOOR/CEILING ASSEMBLIES AND ROOFING/CEILING ASSEMBLIES
- PROVIDE GALVANIZED SHEET STEEL OUTLET BOXES FOR ALL OUTLETS UNLESS OTHERWISE NOTED. ALL OUTLET BOXES FOR PENDANT-MOUNTED FIXTURES SHALL BE GALVANIZED, STAMPED STEEL FURNISHED WITH A FIXTURE STUD, SECURELY MOUNTED TO FRAMING ALL OUTLET BOXES FOR CONCEALED WORK SHALL BE GALVANIZED, STAMPED STEEL; THOSE FOR FIXTURES, FURNISHED WITH A
- FIXTURE STUD. OUTLET BOXES SHALL BE OF SIZE AND TYPE TO ACCOMMODATE (1) STRUCTURAL CONDITIONS, (2) SIZE AND NUMBER OF RACEWAYS, CONDUCTORS OR CABLES ENTERING, AND (3) DEVICES OR FIXTURES FOR WHICH THEY ARE REQUIRED. INSTALL BLANK PLATES ON ALL OUTLET BOXES, IN WHICH NO APPARATUS IS INSTALLED, WHICH DO NOT INTEGRALLY PROVIDE A
- SPECIAL CARE SHALL BE TAKEN TO SET ALL BOXES CORRECTLY SQUARE AND TRUE WITH THE BUILDING FINISH. FIXTURE OUTLET BOXES SHALL HAVE 3/8" SOLID MALE FIXTURE STUDS AND AUXILIARY FIXTURE STEMS SHALL BE SUPPORTED FROM 3/8" MALE FIXTURE STUDS
- OUTLET BOXES AND ACCESSORIES SHALL BE AS MANUFACTURED BY STEEL CITY, APPLETON, RACO, OR EQUAL. 8. WIRING DEVICES: ALL WIRING DEVICES SHALL BE OF A SINGLE MANUFACTURER. AS MANUFACTURED BY PASS AND SEYMOUR, GENERAL ELECTRIC, HUBBELL, BRYANT ELECTRIC COMPANY, LEVITON, OR EQUAL. MANUFACTURERS LISTED BELOW ESTABLISH MINIMUM REQUIREMENTS. COORDINATE COLOR WITH ARCHITECT
- ALL 20A COMMERCIAL GRADE RECEPTACLES SHALL BE GROUNDING TYPE, 125V. RECEPTACLES SHALL BE BACK AND SIDE WIRED WITH SCREW TYPE TERMINALS OR PRESSURE TYPE, SCREWLESS TERMINALS. PROVIDE TAMPER RESISTANT GRADE RECEPTACLES IN ALL LOCATIONS AS REQUIRED BY CODE; DWELLING UNIT, CHILD CARE, PRESCHOOLS, BUSINESS OFFICES, MEDICAL, DENTAL AND OUT PATIENT FACILITIES. SUBSETS OF ASSEMBLY GROUPS AND
- 8.3. WIRING DEVICES WITHIN COMMERCIAL KITCHEN AND BAR AREAS SHALL BE PROVIDE WITH IN-USE, CLEAR WEATHER PROOF COVER. 6. INSTALLATION OF WIRING, CONDUIT AND BOXES: SPECIAL EQUIPMENT RECEPTACLES AS REQUIRED SHALL HAVE AN ADDITIONAL GROUNDING LEG AND SHALL BE OF CAPACITY AND CONFIGURATION FOR THE EQUIPMENT TO BE CONNECTED, CONTRACTOR SHALL CONFIRM CONFIGURATION PRIOR TO ROUGH IN. GFI RECEPTACLES SHALL EACH HAVE GFI TRIPPING (NO FEED THROUGH IS PERMITTED). DAMP LOCATION WEATHERPROOF RECEPTACLES SHALL HAVE AN ENCLOSURE THAT IS WEATHERPROOF WHEN THE RECEPTACLE IS
- RECESSED POKE THROUGH/FLOOR BOX DEVICE: 8.7.1. 6 GANG, WITH OPEN/CLOSE COVER PLATE AND ADJUSTABLE FIRE BARRIER. POKE THROUGH - 4" APPROXIMATE HOLE SIZE, 8 1/4" DEVICE DIAMETER, 17" DEEP FED FROM CEILING BELOW. FLOOR BOX - PROVIDE CONDUIT FOR TEL/DATA AND POWER FROM NEAREST AVAILABLE WALL.
- CONFIGURED WITH THE FOLLOWING: (1) DUPLEX OUTLET (2) RJ45 JACKS (2) AUDIO/VISUAL (COORDINATE EXACT REQUIREMENTS WITH OWNER)

MINIMUM (2) 1" CONDUIT CONNECTIONS FOR TEL/DATA & AUDIO/VISUAL

ARCHITECT), SINGLE-POLE, DOUBLE-POLE, OR THREE-WAY AS REQUIRED.

FINISH - COORDINATE FINISH WITH ARCHITECT WET LOCATION WEATHERPROOF RECEPTACLES SHALL CONFORM TO NEC ARTICLE 406.8(B)(i) AND SHALL HAVE AN ENCLOSURE THAT IS WEATHERPROOF WHETHER OR NOT THE ATTACHMENT PLUG CAP IS INSERTED. PROVIDE RECEPTACLE WITH COVER. LIGHT SWITCHES: ALL LOCAL WALL SWITCHES SHALL BE OF THE FLUSH QUIET DECORA OR TOGGLE TYPE (AS COORDINATED WITH

SENSORS: THE DESIRED SWITCH CONTROL IS SHOWN ON THE DWGS. THE CONTRACTOR SHALL PROVIDE THE SWITCHING AS

REQUIRED. ALL NECESSARY APPURTENANCES SHALL BE PROVIDED FOR THE TYPE SWITCHING SELECTED BY THE CONTRACTOR. THE GENERAL INTENT OF THE SENSOR DESIGN IS FOR ALL WALL SWITCHES WORKING INDEPENDENTLY TO BE LINE VOLTAGE. CEILING SENSORS AND WALL SWITCHES WORKING IN CONJUNCTION WITH CEILING SENSORS SHALL BE LOW VOLTAGE, ALL LOW VOLTAGE SENSORS SHALL BE PROVIDED WITH ALL POWER PACKS AS REQUIRED. SENSORS SHALL BE MOUNTED IN LOCATIONS AS RECOMMENDED BY THE MANUFACTURER. NO ADDITIONAL COMPENSATION WILL BE RECEIVED IF CONTRACTOR HAS TO RELOCATE SENSORS. TIME DELAY SETTINGS SHALL BE SET TO NO LESS THAN 10 MINUTES. COVERAGE DIMENSIONS APPLY TO DEVICE BEING CENTERED. ACTUAL COVERAGE'S CAN VARY ON THE SHAPE AND USE OF APPLICABLE SPACE. COVERAGE MAY BE REDUCED IF DEVICE IS MOUNTED GREATER THAN 12 FEET HIGH.

9.1. ALL GFI CIRCUIT BREAKERS:

- 9.1.1. PROVIDED FOR PERSONNEL PROTECTION SHALL BE 5-6mA IN ACCORDANCE WITH NEC REQUIREMENTS PROVIDED FOR EQUIPMENT PROTECTION SHALL BE 30mA IN ACCORDANCE WITH NEC REQUIREMENTS. ALL MULTI-POLE CIRCUIT BREAKERS SHALL BE COMMON INTERNAL TRIP. HANDLE TIES SHALL NOT BE PERMITTED. ALL CIRCUIT BREAKERS FEEDING 120V SINGLE PHASE LOADS WITHIN DWELLING UNITS SHALL BE ARC FAULT RATED AS REQUIRED BY
- MINIMUM SHORT CIRCUIT INTERRUPTING CAPACITY SHALL BE 10,000AIC AT 240V & 14,000AIC AT 480V. WHERE REQUIRED BY CODE, PROVIDE COMBINATION ARC-FAULT/GFCI BREAKERS.
- 10.1. PANELBOARDS SHALL BE SURFACE- OR FLUSH-MOUNTED AS REQUIRED. PROVIDE COPPER BUS BARS AND FULL SIZE INSULATED PANEL BUSWORK SHALL BE RATED TO CARRY, AS MINIMUM, AMPERE RATING OF OVERCURRENT DEVICE THAT SERVES PANEL.
- 10.3. PANELS WITH FEED-THROUGH BUSING SHALL NOT BE USED. PROVIDE ANTI TURN, SOLDERLESS LUGS SUITABLE FOR COPPER OR ALUMINUM WIRE.PROVIDE SEPARATELY MOUNTED GROUND BUS 10.5. GROUND BUS SHALL BE BONDED TO PANELBOARD ENCLOSURE. PROVIDE BOLT ON, MOLDED CASE, CIRCUIT BREAKERS WITH THERMAL MAGNETIC TRIPS. MULTIPLE POLE BREAKERS SHALL BE
- PROVIDE HANDLE LOCKS FOR EMERGENCY LIGHTING CIRCUITS, FIRE ALARM, SECURITY, OR OTHER SIMILAR FUNCTIONS. MAIN CIRCUIT BREAKERS SHALL BE MOUNTED VERTICALLY, SEPARATE FROM THE BRANCH BREAKERS.
- CURRENT LIMITING CIRCUIT BREAKERS SHALL NOT BE USED. PANELBOARD TRIM SHALL BE PROVIDED WITH DOOR-IN-DOOR CONSTRUCTION. PANELBOARD SHALL BE CAPABLE OF SUPPORTING ADDITIONAL BOLT-ON CIRCUIT BREAKERS WITHOUT MODIFICATION UP TO THE FRAME SIZE SPECIFIED ON THE DRAWINGS. 10.10. PROVIDE FULLY RATED CIRCUIT BREAKERS EQUAL TO SHORT CIRCUIT INTERRUPTING CURRENT SPECIFIED.
- 10.11. PROVIDE TYPED NAME CARD IN EACH PANELBOARD. CARD SHALL INDICATE EQUIPMENT, LIGHTING AREAS, OR RECEPTACLE AREAS FED BY EACH BRANCH CIRCUIT BREAKER. 10.12. PANELBOARD DOORS SHALL HAVE FLUSH MOUNTED CATCH AND LOCK WITH TWO KEYS. ALL KEYS FOR PANELBOARDS SHALL BE KEYED ALIKE. PANELBOARDS SHALL BE MANUFACTURED BY EATON, SIEMENS, SQUARE D, OR APPROVED EQUAL.

11.1. SUBSTITUTIONS FOR SCHEDULED LIGHTING EQUIPMENT WILL BE REJECTED UNLESS RECEIVED WITHIN TEN DAYS AFTER CONTRACT 11.2. LIGHTING FIXTURES SHALL BE PROVIDED COMPLETE, WITH LAMPS AND DRIVERS AS REQUIRED AND AS SHOWN ON THE FIXTURE SCHEDULE. FURNISH ALL FITTINGS AND OTHER MISCELLANEOUS MATERIALS FOR COMPLETE INSTALLATION OF FIXTURES.

- SPARE: CONTRACTOR SHALL PROVIDE (3) ADDITIONAL EMERGENCY FIXTURES AND (2) ADDITIONAL EXIT SIGNS. EACH SHALL BE OF 12. DISCONNECT SWITCHES: ALL SAFETY SWITCHES SHALL BE NEMA GENERAL-DUTY TYPE HD AND UNDERWRITERS' LABORATORIES LISTED
- 12.1. ALL SWITCHES SHALL HAVE SWITCHBLADES WHICH ARE FULLY VISIBLE IN THE OFF POSITION WITH THE DOOR OPEN. ALL CURRENT CARRYING PARTS SHALL BE PLATED THROUGH ELECTROLYTIC PROCESSES TO RESIST CORROSION AND PROMOTE COOL OPERATION. 14. SWITCHES SHALL BE QUICK MAKE AND QUICK BREAK SUCH THAT DURING NORMAL OPERATION OF THE SWITCH, THE OPERATION OF THE CONTACTS SHALL BE NOT CAPABLE OF BEING RESTRAINED BY THE OPERATING HANDLE AFTER THE CLOSING OR OPENING ACTION OF THE CONTACTS HAS STARTED. THE HANDLE AND MECHANISM SHALL BE AN INTEGRAL PART OF THE BOX, NOT THE COVER,
- WITH POSITIVE PADLOCKING PROVISIONS IN THE OFF POSITION. SWITCHES SHALL BE FURNISHED IN NEMA 1 GENERAL PURPOSE ENCLOSURES. ENCLOSURES SHALL BE OF CODE GAUGE (UL 98) SHEET STEEL (NEMA 1) OR CODE GAUGE PHOSPHATE TREATMENT AND GRAY BAKED ENAMEL FINISH. EXTERIOR SWITCHES SHALL BE IN A NEMA 3R (RAINTIGHT) ENCLOSURE.
- 12.4. SWITCHES SHALL BE HORSEPOWER RATED FOR 600 VOLTS AC AND ALL SWITCHES SHALL BE FUSED TYPE WITH DUAL ELEMENT FUSES 13. FUSES: SHALL BE NON RENEWABLE TYPE, UL CLASS J UP TO 600 AMP, AND CLASS L OVER 600 AMP. FUSES SHALL BE CURRENT LIMITING TYPE WITH A MINIMUM INTERRUPTING RATING OF 200,000 RMP AMP.
- FURNISH AND INSTALL ALL FUSES AND ONE COMPLETE SET OF THREE SPARE FUSES FOR EACH SIZE USED. FUSES SHALL BE MANUFACTURED BY BUSSMAN, GOULD SHAWMUT, LITTLE OR APPROVED EQUAL.

- SERVICE TO THE FACILITY: ELECTRICAL POWER OUTAGES MUST BE MINIMIZED AS NOT TO INTERFERE WITH THE BUILDING'S OPERATION. THE TIME AND DURATION OF ANY POWER OUTAGE MUST BE APPROVED BY AND SCHEDULED WITH THE BUILDING OWNER/AUTHORITY. THE ELECTRICAL CONTRACTOR SHALL NOTIFY THE OWNER/AUTHORITY AT LEAST TEN CALENDAR DAYS FROM THE DATE OF PROPOSED POWER
- . DEMOLITION, RELOCATION AND REMOVAL OF EXISTING WIRING THE ELECTRICAL CONTRACTOR SHALL PROVIDE ALL ELECTRICAL DEMOLITION, RELOCATION OF CIRCUITS, AND REMOVAL OF EXISTING WIRING NECESSARY FOR THE ELECTRICAL WORK AS SHOWN ON THE DWGS. THE ELECTRICAL CONTRACTOR SHALL COMPLETELY REMOVE ALL ELECTRICAL SYSTEMS WITHIN THE BUILDING THAT ARE DESIGNATED
- THE CONTRACTOR SHALL MAINTAIN, EXTEND, AND CONNECT EXISTING BRANCH CIRCUITS WHICH PASS THROUGH THE CONSTRUCTION AREA, MAINTAINING POWER TO ALL EQUIPMENT AND LIGHTING OUTSIDE OF THE CONSTRUCTION AREA.

OUTLETS THAT ARE EXISTING FOR USE AS LIGHTING OR RECEPTACLES MAY BE USED AS JUNCTION BOXES FOR THE RE-WIRING OF

SPECIAL COORDINATION INSTRUCTIONS COORDINATION WITH WORK OF OTHER TRADES IS REQUIRED. THE FOLLOWING SPECIAL INSTRUCTIONS SHALL ALSO BE CAREFULLY

- 3.1.1. LOCATIONS AND MOUNTING HEIGHT OF ALL WALL OUTLETS AND LIGHTING FIXTURES SHALL BE VERIFIED WITH THE ARCHITECT/ENGINEER PRIOR TO ROUGHING IN CONDUIT.
- ALL FEEDER, BRANCH CIRCUIT OR AUXILIARY SYSTEM WIRING PASSING THROUGH PULL BOXES AND/OR BEING MADE UP IN PANELBOARDS SHALL BE PROPERLY GROUPED, BOUND, AND TIED TOGETHER IN A NEAT AND ORDERLY MANNER, IN KEEPING
- WITH THE HIGHEST STANDARDS OF THE TRADE, WITH PLASTIC CABLE TIES. ALL DUPLEX CONVENIENCE AND POWER RECEPTACLES SHALL BE MOUNTED VERTICALLY WITH THE GROUNDING POST TO THE BOTTOM AS THE OUTLET IS VIEWED FROM THE FRONT.
- ALL MISCELLANEOUS HARDWARE AND SUPPORT ACCESSORIES, INCLUDING SUPPORT RODS, NUTS, BOLTS, SCREWS, AND OTHER SLICH ITEMS. SHALL BE OF A GALVANIZED OR CADMILIM PLATED FINISH. OR OF OTH CARE SHOULD BE TAKEN THAT FIXTURES SHALL NOT BE INSTALLED ON BOTH SIDES OF EXISTING OR NEW BUILDING EXPANSION 3.1.5. THE ELECTRICAL CONTRACTOR SHALL PROVIDE ALL MATERIALS, EQUIPMENT, AND WORKMANSHIP TO PROVIDE FOR ADEQUATE
- PROTECTION OF ALL ELECTRICAL EQUIPMENT DURING THE COURSE OF CONSTRUCTION OF THE PROJECT. 3.1.6. THE ELECTRICAL CONTRACTOR SHALL FURNISH AND INSTALL APPROVED INSULATION AT TERMINAL CONNECTION POINTS FOR

- ALL ELECTRICAL CONDUCTING MATERIALS, SUCH AS TRANSFORMER TERMINALS, TERMINAL STUDS, AND AT ANY OTHER SPECIAL LOCATIONS AS DIRECTED BY THE ENGINEER
- PRIOR TO INSTALLATION OF CONDUIT AND WIRE, THE ELECTRICAL CONTRACTOR SHALL COORDINATE WIRING REQUIREMENTS WITH ACTUAL EQUIPMENT SUPPLIED. THE ELECTRICAL DRAWINGS INDICATE WIRE, CONDUIT, AND OVERCURRENT PROTECTIVE DEVICES TO BE INSTALLED FOR CERTAIN HVAC UNITS. THESE SIZES ARE BASED ON CERTAIN MANUFACTURERS REQUIREMENTS. SHOULD THE GENERAL CONTRACTOR ALLOW THE MECHANICAL CONTRACTOR TO SUBSTITUTE HVAC EQUIPMENT DIFFERENT THAN SPECIFIED, THEN THE GENERAL CONTRACTOR SHALL PROVIDE THE REQUIRED REVISED ELECTRICAL WIRING, CONDUIT, AND OVERCURRENT PROTECTIVE DEVICES IN ACCORDANCE WITH THE MANUFACTURERS RECOMMENDATIONS AT NO ADDITIONAL CHARGE TO THE
- CUTTING, PATCHING, AND DRILLING: THE GENERAL CONTRACTOR SHALL PERFORM PLASTER CUTTING AND CHANNELING AND DRILLING THROUGH STRUCTURAL BEAMS NECESSARY FOR THE INSTALLATION OF ELECTRICAL WORK. THE GENERAL CONTRACTOR SHALL BE RESPONSIBLE FOR ALL PAINTING AND PATCHING WHICH SHALL MATCH EXISTING BASE MATERIALS IN LOOKS AND COLOR. THE ELECTRICAL CONTRACTOR SHALL PROVIDE ROUTINE DRILLING THROUGH 2 X 4 AND/OR 2 X 6 WOOD FRAME WALLS AND 2 X 10 AND/OR 2 X 12 FLOOR JOISTS IN ORDER TO INSTALL WIRING.
- 5. COOPERATION AND WORK PROGRESS 5.1. THE ELECTRICAL WORK SHALL BE CARRIED ON UNDER THE USUAL CONSTRUCTION CONDITIONS, IN CONJUNCTION WITH ALL OTHER WORK AT THE SITE. THE ELECTRICAL CONTRACTOR SHALL COOPERATE WITH THE ENGINEER AND ALL CONTRACTORS AND EQUIPMENT
- SUPPLIERS WORKING ON THE SITE, COORDINATE THE WORK, AND PROCEED IN A MANNER SO AS NOT TO DELAY THE PROGRESS OF 5.2. THE ELECTRICAL CONTRACTOR HAS A RESPONSIBILITY TO COORDINATE THE EXACT MOUNTING ARRANGEMENT AND LOCATION OF EQUIPMENT INDICATED ON THE DRAWINGS TO ALLOW FOR PROPER SPACE REQUIREMENTS FOR EQUIPMENT ACCESS, OPERATION,
- 5.3. IT SHALL BE THE RESPONSIBILITY OF THE ELECTRICAL CONTRACTOR TO COORDINATE THE DELIVERY OF ELECTRICAL EQUIPMENT TO THE PROJECT PRIOR TO THE TIME INSTALLATION OF EQUIPMENT WILL BE REQUIRED.
- 6.1. ALL CONDUIT AND WIRING SHALL BE INSTALLED CONCEALED.
- OUTLET BOXES SHALL BE MOUNTED FLUSH. CONDUIT SHALL BE RUN CONCEALED. WHERE WALLS ARE BLOCK, DEVICES AND WIRING SHALL BE SURFACE MOUNTED. PROVIDE WIRE MOLD OR EQUAL TO SURFACE MOUNTED RACEWAY WITH FINISHED BOXES.
- 6.3. UNLESS OTHERWISE INDICATED, ALL WIRING SHALL BE (2)#12 AND (1)#12 GROUND, 3/4"C. 6.4. CONDUIT ENDS SHALL BE CUT SQUARE, THREADED, AND REAMED TO REMOVE BURRS AND SHARP EDGES. OFFSETS AND BENDS FOR CHANGES IN ELEVATION OF EXPOSED CONDUIT RUNS SHALL BE MADE AT WALLS OR BEAMS AND NOT IN OPEN SPACES BETWEEN WALLS OR BEAMS. CONDUITS SHALL BE ROUTED SO AS NOT TO INTERFERE WITH THE OPERATION OR MAINTENANCE OF ANY
- EQUIPMENT. STEEL SUPPORTS OR RACKS SHALL BE GALVANIZED STEEL CHANNEL AND FITTINGS. 6.5. EXPOSED CONDUITS SHALL BE RUN PARALLEL TO, OR AT RIGHT ANGLES TO, THE WALLS OF THE BUILDING, AND ALL BENDS SHALL BE MADE WITH STANDARD CONDUIT ELLS OR CONDUITS BENT TO - NOT LESS THAN - THE SAME RADIUS. HORIZONTAL RUNS OF EXPOSED CONDUITS SHALL BE CLOSE TO CEILING BEAMS, PASSING OVER WATER OR OTHER PIPING WHERE POSSIBLE AND SHALL BE SUPPORTED BY PIPE STRAPS OR BY OTHER APPROVED MEANS, NOT MORE THAN 5' APART. INSTALLATION OF EXPOSED CONDUITS IN FINISHED AREAS OF THE BUILDING SHALL BE CHECKED WITH THE ENGINEERS FOR LAYOUT BEFORE INSTALLATION TO CONFORM TO THE PATTERN OF THE STRUCTURAL MEMBERS, AND WHEN COMPLETED, IS TO PRESENT THE MOST UNOBTRUSIVE APPEARANCE POSSIBLE. NO EXPOSED CONDUITS WILL BE PERMITTED ON WALLS OR PARTITIONS IN PUBLIC AREAS, UNLESS SPECIFICALLY NOTED.
- AND, IN THAT CASE, THE CONDUIT SHALL BE KEPT AT LEAST 1" FROM COVERING OR PIPE CROSSED. DO NOT LAY CABLE OR RACEWAY ON, OR SUPPORT FROM SUSPENDED CEILING OR PIPING AND DUCTWORK. 6.8. CONDUITS SHALL BE SUPPORTED ON APPROVED TYPE GALVANIZED WALL BRACKETS, CEILING TRAPEZE, STRAP HANGERS, OR PIPE

CONDUITS SHALL NOT BE INSTALLED WITHIN 3" OF HOT WATER PIPES. OR APPLIANCES. EXCEPT WHERE CROSSING IS UNAVOIDABLE

- STRAPS, SECURED BY MEANS OF TOGGLE BOLTS ON HOLLOW MASONRY UNITS OR EXPANSION BOLTS IN CONCRETE OR BRICK. IN GENERAL, NO SPLICES OR JOINTS WILL BE PERMITTED IN EITHER FEEDER OR BRANCHES EXCEPT AT OUTLETS OR ACCESSIBLE
- ALL SPLICES IN WIRE #8 AWG AND SMALLER SHALL BE STANDARD PIGTAIL, MADE MECHANICALLY TIGHT AND INSULATED WITH PROPER THICKNESS OF INSULATING TAPE. 6.11. WIRE #6 AND LARGER SHALL BE CONNECTED TO PANELS AND APPARATUS BY MEANS OF APPROVED LUGS OR CONNECTORS.
- CONNECTORS SHALL BE SOLDERLESS TYPE, SUFFICIENTLY LARGE TO ENCLOSE ALL STRANDS OF THE CONDUCTOR AND SECURELY 6.12. PROVIDE ALL REQUIRED BRANCH CIRCUIT WIRING FOR ELECTRICAL DEVICES AND LIGHTING FIXTURES. DESIGNATIONS SHOWN ON)RAWINGS ARE DIAGRAMMATIC ONLY. CIRCUIT NUMBERS BESIDE RECEPTACLES AND LIGHTING FIXTURES CONVEY THAT A COMPLET BRANCH CIRCUIT IS REQUIRED BACK TO ELECTRICAL PANELBOARD.SWITCH CONTROL LETTERS ADJACENT TO LIGHTING FIXTURES
- 7.1. PROVIDE COLOR CODING FOR SECONDARY SERVICE, FEEDERS, AND BRANCH CIRCUITS AS FOLLOWS, IN ACCORDANCE WITH NEC

INDICATE BRANCH WIRING REQUIRED FROM LIGHTING FIXTURE TO LIGHT SWITCH OR DIMMER.

- RECOMMENDATIONS AND STANDARD PRACTICES MAKE CONNECTIONS TO TERMINALS FROM LEFT TO RIGHT ARRANGED PHASE A, B, AND C 7.3. PROVIDE SAME COLOR CODING FOR SWITCH LEGS AS CORRESPONDING PHASE CONDUCTOR. PROVIDE COLORED PLASTIC TAPE OF SPECIFIED COLOR CODE IDENTIFICATION FOR LARGE SIZE CONDUCTORS AVAILABLE ONLY IN BLACK.
- MOTORS, CONNECTIONS, AND CONTROLS
- 8.1. SPLICES AND TERMINATIONS: MAKE SPLICES AND TERMINATIONS EQUIVALENT ELECTRICALLY AND MECHANICALLY TO CONDUCTOR INSULATION. MAKE SPLICES AT MOTOR JUNCTION BOXES WITH PRESSURE INDENT CONNECTORS OR SPLIT BOLT CONNECTORS AS SPECIFIED
- PROVIDE STANDARD BOLT ON LUGS WITH ALLEN CAP SCREWS TO ATTACH COPPER WIRE AND CABLE TO DISCONNECT SWITCHES
- TEMPERATURE CONTROL WIRING: THE TEMPERATURE CONTROL SYSTEM SHALL BE AN ELECTRIC SYSTEM INSTALLED BY THE HEATING AND
- 10. SALVAGE: THE ELECTRICAL CONTRACTOR SHALL REMOVE ALL ELECTRICAL EQUIPMENT NOT TO BE USED. ALL ELECTRICAL EQUIPMENT REMOVED AND DEEMED SALVAGEABLE BY THE OWNER SHALL BE STORED IN AN AREA DESIGNATED BY THE OWNER.ANY ELECTRICAL EQUIPMENT REMOVED THAT IS NOT DESIRED BY THE OWNER SHALL BE DISPOSED OF AT THE EXPENSE OF THE ELECTRICAL CONTRACTOR.
- SUPPORTS AND ATTACHMENTS: BOXES AND PENDANTS FOR SURFACE-MOUNTED FIXTURES SHALL BE SUPPORTED IN AN APPROVED MANNER. BOXES AND SUPPORTS SHALL BE FASTENED WITH BOLTS AND EXPANSION SHIELDS ON CONCRETE OR BRICK. WITH TOGGLE BOLTS ON HOLLOW MASONRY UNITS, WITH MACHINE SCREWS ON STEEL WORK WITH LOCKNUTS. THREADED STUDS SHALL BE PROVIDED
- QUIET OPERATION: ALL EQUIPMENT AND MATERIAL FURNISHED BY THE ELECTRICAL CONTRACTOR SHALL OPERATE UNDER ALL CONDITIONS OF LOAD WITHOUT OBJECTIONABLE NOISES OR VIBRATIONS. WHICH, IN THE OPINION OF THE ENGINEER, IS OBJECTIONABLE WHERE SOUND OR VIBRATION CONDITIONS ARISE WHICH ARE CONSIDERED OBJECTIONABLE BY THE ENGINEER, THE ELECTRICAL
- TESTS: FURNISH ALL LABOR, MATERIAL, INSTRUMENTS, SUPPLIES, AND SERVICES AND BEAR ALL COSTS FOR THE ACCOMPLISHMENT OF TESTS HEREIN SPECIFIED. CORRECT ALL DEFECTS APPEARING UNDER TEST. REPEAT THE TESTS UNTIL NO DEFECTS ARE DISCLOSED. LEAVE THE EQUIPMENT CLEAN AND READY FOR USE

13.1. THE ELECTRICAL CONTRACTOR SHALL PERFORM ANY TEST OTHER THAN HEREIN SPECIFIED WHICH MAY BE SPECIFIED BY LEGAL

- FINAL INSPECTION AND TEST: PRIOR TO TEST, FEEDERS AND BRANCHES SHALL BE CONTINUOUS FROM SERVICE CONTACT POINT TO EACH OUTLET; ALL PANELS, FEEDERS, AND DEVICES CONNECTED AND FUSES IN PLACE. TEST SYSTEM FREE FROM SHORT CIRCUITS AND GROUNDS WITH INSULATION RESISTANCES NOT LESS THAN OUTLINES IN THE NATIONAL ELECTRICAL CODE. PROVIDE TESTING EQUIPMENT NECESSARY AND CONDUCT TEST IN PRESENCE OF THE OWNER'S AUTHORIZED REPRESENTATIVE. THE FINAL INSPECTION AND TEST SHALL
- INCLUDE THE FOLLOWING: 14.1. TESTING OF THE EMERGENCY LIGHTING SYSTEM. 14.2. TESTING OF THE IMPEDANCE OF THE GROUNDING SYSTEM.
- 14.3. TESTING OF EACH OUTLET. 14.4. TESTING OF THE FIRE ALARM SYSTEM
- TESTING OF BRANCH AND FEEDER CONDUCTORS FOR CONTINUITY 14.6. TESTING OF PANELBOARDS TO VERIFY PROPER CURRENT BALANCE AND VOLTAGE

TESTING OF MOTORS, VERIFYING PROPER CURRENT BALANCE AND VOLTAGE.

CONTRACTOR SHALL ELIMINATE SAME IN A MANNER APPROVED BY THE ENGINEER.

AUTHORITIES OR BY AGENCIES TO WHOSE REQUIREMENTS THIS WORK IS TO CONFORM.

13.1. FUSES FOR MOTOR FEEDERS OR MOTOR CIRCUITS SHALL BE CLASS K5 OF A VOLTAGE CLASSIFICATION RATED FOR THE MOTOR WITH 14.8. TESTING, TARGETING, AND FOCUSING OF ALL ADJUSTABLE LIGHTING FIXTURES. A MINIMUM INTERRUPTING CAPACITY OF 100,000 RMS AMP AND WITH TIME DELAY OF A MINIMUM OF 10 SECONDS AT 500% OF MOTOR 14.9. TESTING OF ALL GROUND FAULT PROTECTIVE DEVICES IN ACCORDANCE WITH THE NATIONAL ELECTRICAL CODE, SECTION 230-95.



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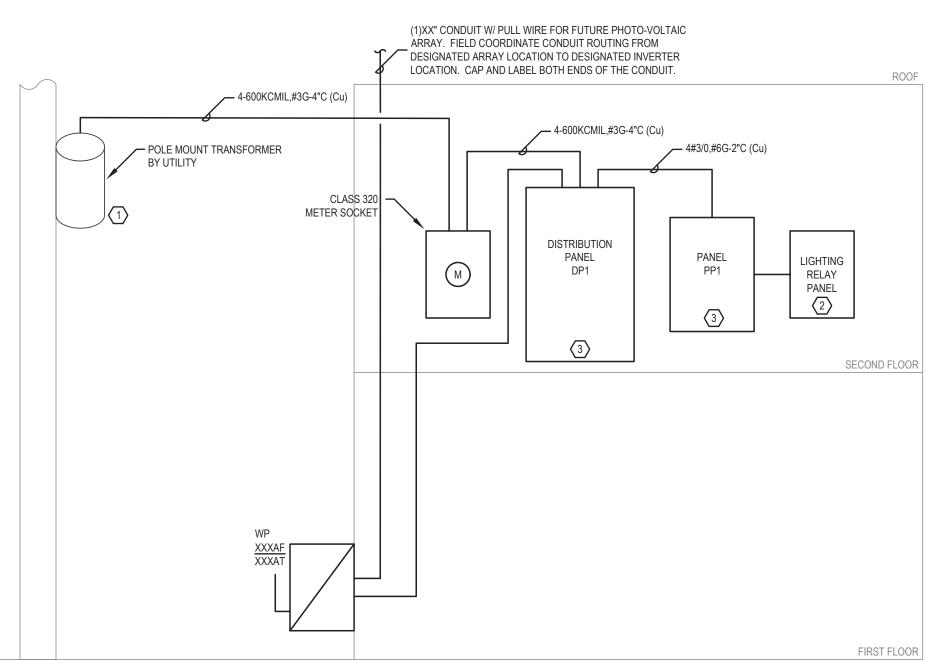
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SPECIFICATION


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POWER RISER DIAGRAM

- # NOTES:
- POLE MOUNTED TRANSFORMER BY UTILITY. GROUNDING, SECONDARY CONDUIT, AND SECONDARY CONDUCTORS BY ELECTRICAL CONTRACTOR. ALL FINAL CONNECTIONS AT TRANSFORMER BY UTILITY. UTILITY COMPANY SHALL BE NATIONAL GRID.
- 2. ELECTRICAL CONTRACTOR SHALL PROVIDE LIGHTING RELAY PANEL, CRISTAL CCLP-32 OR EQUAL. REFER TO LIGHTING RELAY ZONE SCHEDI II F
- 3. ELECTRICAL CONTRACTOR SHALL PROVIDE NEW PANELBOARDS AS INDICATED.
- 4. ELECTRICAL CONTRACTOR SHALL GROUND AS IN ACCORDANCE WITH NEC ARTICLE 250 AS AMENDED BY THE STATE ELECTRICAL CODE



PARTIAL COMMUNICATIONS RISER DIAGRAM

NOTES:

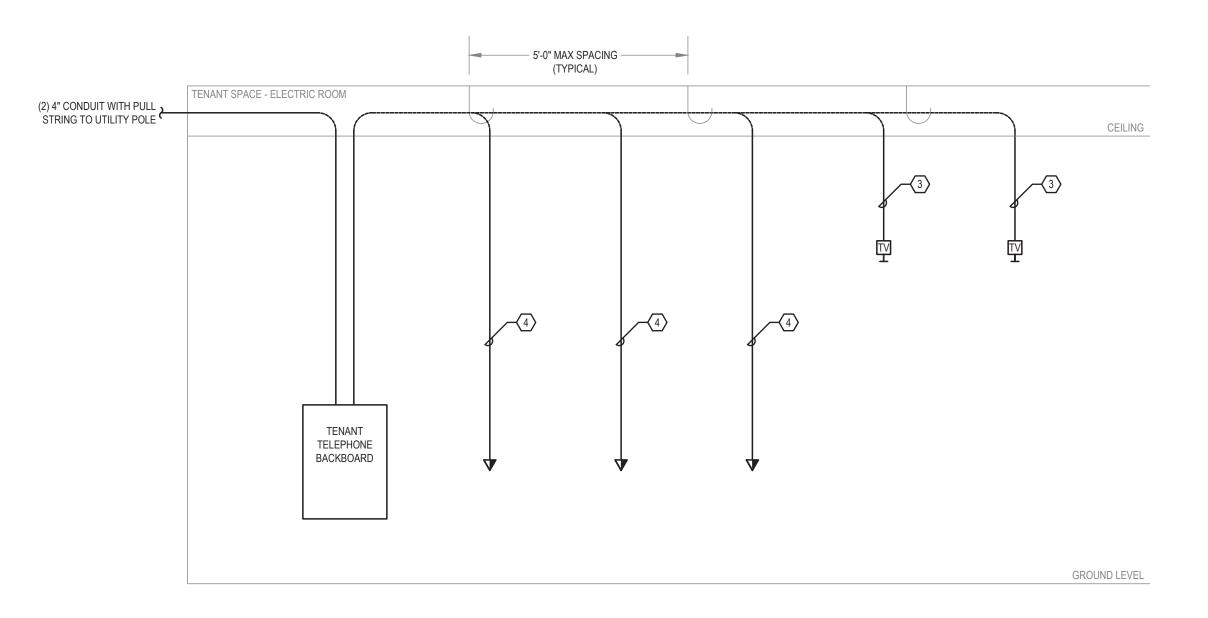- ELECTRICAL CONTRACTOR SHALL MAKE ALL TERMINATIONS (UNLESS NOTED OTHERWISE) AND TEST ALL CABLES IN ACCORDANCE WITH EIA AND TIA STANDARDS, PROVIDE REPORT.
- 2. ALL CABLES SHALL BE CLEARLY LABELED AT BOTH ENDS WITH DESCRIPTION OF DEVICE. A 6' SERVICE LOOP SHOULD BE LEFT AT THE TELEPHONE BACKBOARD END AND DESTINATION END.
- 3. PROVIDE CATV JACK AND COVER PLATE. TERMINATE (1) RG6 CABLE ON "F" CONNECTOR, SEE FLOOR PLANS FOR EXACT QUANTITY AND LOCATIONS. RG6 CABLE SHALL EXTEND FROM EACH DEVICE LOCATION TO TELEPHONE BACKBOARD.
- 4. PROVIDE (2) RJ4 JACKS AND COVER PLATE. TERMINATE (2) CAT6 CABLES FROM EACH RJ45 JACK IN DEVICE TO TELEPHONE BACKBOARD, REFER TO DRAWINGS FOR QUANTITIES.

LIGHTING FIXTURE SCHEDULE								
FIXTURE TYPE	DESCRIPTION	LIGHT SOURCE					VOLTAGE	
TIXTORE THE	DESCRIPTION	CATALOG NUMBER	LUMENS	TEMP	No.	WATTAGE	TYPE	VOLIAG
L1	8' LINEAR SURFACE MOUNTED STRIP LIGHTS	TBD BY ARCHITECT	-	-	-	-	LED	120
P1	LED PEDNANT	TBD BY ARCHITECT	-	-	-	-	LED	120
P2	LED PENDANT	TBD BY ARCHITECT	-	-	-	-	LED	120
P3	LED PENDANT	TBD BY ARCHITECT	-	-	-	-	LED	120
P4	LED PENDANT	TBD BY ARCHITECT	-	-	-	-	LED	120
P5	LED PENDANT	TBD BY ARCHITECT	-	-	-	-	LED	120
P6	LED PENDANT	TBD BY ARCHITECT	-	-	-	-	LED	120
P7	LED PENDANT	TBD BY ARCHITECT	-	-	-	-	LED	120
R1	2'X2' RECESSED TROFFER	TBD BY ARCHITECT	-	-	-	-	LED	120
R2	LED UNDER COUNTER STRIP LIGHTING	TBD BY ARCHITECT	-	-	-	-	LED	120
R3	ROUND RECESSED LED FIXTURE	TBD BY ARCHITECT	-	-	-	-	LED	120
R4	RECTANGULAR RECESSED LED	TBD BY ARCHITECT	-	-	-	-	LED	120
S1	LED WALL SCONCE	TBD BY ARCHITECT	-	-	-	-	LED	120
>	EXTERIOR RATED REMOTE EMERGENCY HEAD WITH INDOOR POWER MODULE, REFER TO FLOOR PLANS FOR QUANTITY OF HEADS	EXITRONIX # SINGLE: MLED1-W-WP DOUBLE: MLED2-W-WP	-	-	2	3.6	LED	120
E1 E1	WALL OR CEILING MOUNTED EMERGENCY BATTERY UNIT WITH TWO (2) HEADS, PROVIDE WITH SELF-TEST/SELF DIAGNOSTICS, 30'-0" O.C. MAX	EXITRONIX # LED-52-WH-G2	-	-	2	2.0	LED	120
E2 E2	WALL OR CEILING MOUNTED EMERGENCY BATTERY UNIT WITH TWO (2) HEADS, PROVIDE WITH SELF-TEST/SELF DIAGNOSTICS, 60'-0" O.C. MAX	EXITRONIX # NFT-W-G2	-	-	2	2.7	LED	120
E3 E3	WALL OR CEILING MOUNTED EMERGENCY BATTERY UNIT WITH TWO (2) HEADS, PROVIDE WITH SELF-TEST/SELF DIAGNOSTICS, 115'-0" O.C. MAX	EXITRONIX # NFT-HO-W-G2	-	-	2	5.4	LED	120
⊗ ⊗	SINGLE OR DOUBLE FACE EDGELIT EXIT SIGN, REFER TO FLOOR PLANS FOR DIRECTIONAL ARROWS AND MOUNTING TYPES (WALL/CEILING)	EXITRONIX # SINGLE: S902-WB-SR-RC-AG DOUBLE: S903-WB-SR-RM-AG	-	-	1	4	LED	120
⊗& \$ &	SINGLE FACE EDGELIT EXIT SIGN, W/ ACCESSIBLE SYMBOL, REFER TO FLOOR PLANS FOR DIRECTIONAL ARROWS AND MOUNTING TYPES (WALL/CEILING)	EXITRONIX # SINGLE: MA902-S-WB-RC-WH DOUBLE: MA903-S-WB-RM-WH	-	-	1	4	LED	120


LIGHTING FIXTURE NOTES:

- 1. ALL RECESSED FIXTURE TRIMS TO BE PAINTED TO MATCH CEILING.
- PROVIDE A COMPLETE AND OPERABLE SYSTEM INCLUDING ALL NECESSARY MOUNTING HARDWARE, POWER FEEDS, WIRING CONNECTIONS, DRIVERS, AND CONTROL INTERFACES.
 PAINT ALL FLANGES INSTALLED IN DRYWALL TO MATCH ADJACENT CEILING FINISH. FLANGES SHALL BE REMOVED FROM CEILING PRIOR TO PAINTING, OR RAZOR CUT AFTER PAINTING TO ALLOW FOR REMOVAL OF THE TRIM FROM THE CEILING.
- * ELECTRICAL CONTRACTOR SHALL PROVIDE DIMMABLE LED REPLACEMENT LAMPS, LAMP COLOR TEMPERATURE 2700K, AS INDICATED ON THE LIGHTING FIXTURE SCHEDULE.
- ** ELECTRICAL CONTRACTOR SHALL PROVIDE ALL NECESSARY COMPONENTS FOR A COMPLETE AND OPERATIONAL SYSTEM.

LIGHTING RELAY ZONE SCHEDULE					
ZONE	CIRCUIT NUMBER	SWITCH			
1					
2					
3					
4					
5					
6					
7					
8					
9					
10					
11					
12					
13					
14					
15					
16					
17					
18					
19					
20					
21					
22					
23					
24					
25					
26					
27					
28					
29					
30					
31					
32					

INTERRUPTING CAPACITY: 65,000 AMPS RMS SYM MAIN: 400A M.C.B. NEUTRAL: 400A MOUNTING: SURFACE						
CIRCUIT	DESCRIPTION	LOAD	OVERC	JRRENT	DEVICE	REMARKS
No.	BESOKII IION	kVA	FRAME	TRIP	POLE	KEMAKKO
1	PANELBOARD 'PP1'	33.79	250	200	3	
2	SPACE AND HARDWARE	0.00	250			
3	SPACE AND HARDWARE	0.00	250			
4	SPACE AND HARDWARE	0.00	250			
5	SPACE AND HARDWARE	0.00	250			
6	SPACE AND HARDWARE	0.00	150			
7	SPACE AND HARDWARE	0.00	150			
8	SPACE AND HARDWARE	0.00	150			
9	SPACE AND HARDWARE	0.00	150			
10	SPACE AND HARDWARE	0.00	150			
11	SPACE AND HARDWARE	0.00	150			
12	SPACE AND HARDWARE	0.00	150			

INTERRUPTING CAPACITY CB TYPE: G - INDICATES GFCI	,				LOCK,	GE - IN		I: 200A S GFPI			S SH	UNT T	MOUNTING: SURFACE RIP, A - INDICATES ARC FAULT
LOAD DESCRIPTION CB/TYPE CIRC KVA LOAD CIRC CB/TYPE LOAD DESCRIPTION													
LOAD DESCRIPTION	CB/	IYPE	NO.	Α	В	С	Α	В	С	NO.	CBI	ITPE	LOAD DESCRIPTION
CEPTACLES - LOBBY	20		1	0.54			0.72			2		20	RECEPTACLES - EARLY ED
EPTACLES - RESTROOMS 1003/1004	20		3		0.36			0.54		4		20	RECEPTACLES - EARLY ED
CEPTACLES - LOBBY CONVENIENCE	20		5	1		0.54			0.18	6		20	RECEPTACLES - EARLY ED RESTROOM
ETPACLE - BUBBLER	20		7	0.18]		0.90]		8		20	RECEPTACLES - CORRIDOR
CEPTACLE - CONCESSIONS	20		9		0.54			0.72		10		20	RECEPTACLES - MULTI PURPOSE
CEPTACLES - LOBBY/VESTIBULE	20		11	1		0.54			0.54	12		20	RECEPTACLES - DIRECTOR
CEPTACLES - STUDY	20		13	0.54]		0.54			14		20	RECEPTACLES - ASSIST
CEPTACLES - STUDY	20		15		0.54			0.54		16		20	RECEPTACLES - REC/ENRICH
CEPTACLES - ART SINK	20		17	1		0.36			0.54	18		20	RECEPTACLES - SOCIAL
CEPTACLES - ART REFRIGERATOR	20		19	1.20]		0.54	1		20		20	RECEPTACLES - ART
CEPTACLES - ART KITCHEN	20		21		0.54			0.72		22		20	RECEPTACLES - YOUTH PROGRAM
- DANOE/OVEN	1		23	1		2.75			0.72	24		20	RECEPTACLES - HANGOUT
Γ RANGE/OVEN	50		25	2.75]		0.54			26		20	RECEPTACLES - HANGOUT
VER ART HOOD	20		27		1.20			0.60		28		20	MOTORIZED PROJECTOR SCREEN
CEPTACLES - GYMNASIUM	20		29	1		0.72			0.72	30		20	RECEPTACLE - PROJECTOR
CEPTACLES - GYMNASIUM	20		31	0.54]		1.20			32		20	DOOR ACCESS POWER
OR ACCESS POWER	20		33		1.20			1.20		34		20	AUTOMATIC DOOR POWER
CEPTACLES - SECOND FLOOR	20		35	1		0.72			0.36	36		20	RECEPTACLE - TELEPHONE BACKBOARD
HTING - SECOND FLOOR/ FIRST FLOOR HALL	20		37	1.08]		1.15]		38		20	LIGHTING - EARLY ED/OFFICES
HTING - HANGOUT	20		39		1.12			1.10		40		20	LIGHTING - GYM/RESTROOMS
HTING - GYM	20		41	İ		0.80			0.36	42		20	RECEPTACLE - TELEPHONE BACKBOARD
ARE	20		43	0.00]		0.60]		44		20	FIRE ALARM CONTROL PANEL
ARE	20		45		0.00]		0.00		46		20	SPARE
ARE	20		47	1		0.00			0.00	48		20	SPARE
ACE AND HARDWARE	† <u></u>		49	0.00	1		0.00	1		50			SPACE AND HARDWARE
ACE AND HARDWARE	†		51		0.00			0.00		52			SPACE AND HARDWARE
ACE AND HARDWARE	†		53	1		0.00			0.00	54			SPACE AND HARDWARE
CE AND HARDWARE	 		55	0.00]		0.00	1		56			SPACE AND HARDWARE
CE AND HARDWARE	 		57		0.00			0.00		58			SPACE AND HARDWARE
ACE AND HARDWARE	 		59	1		0.00			0.00	60			SPACE AND HARDWARE

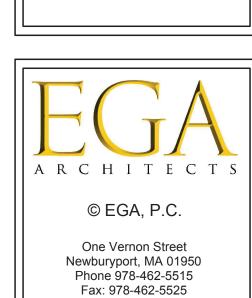

STRUCTURAL ENGINEER:
Shelley Engineering
MEP ENGINEER:
BLW Engineers
INTERIOR DESIGNER:

Newburyport Youth Services 59 Low Street Newburyport, MA 01950


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DIAGRAMS AND
SCHEDULES

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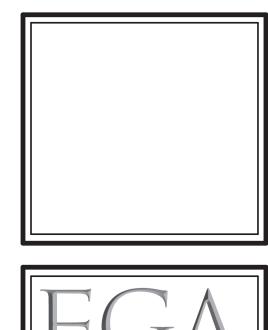
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DETAILS


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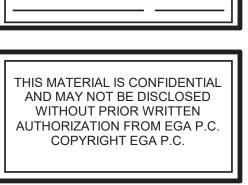
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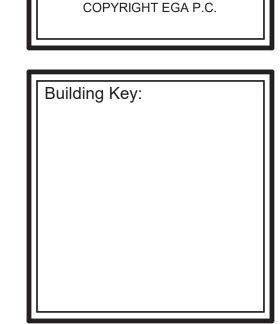







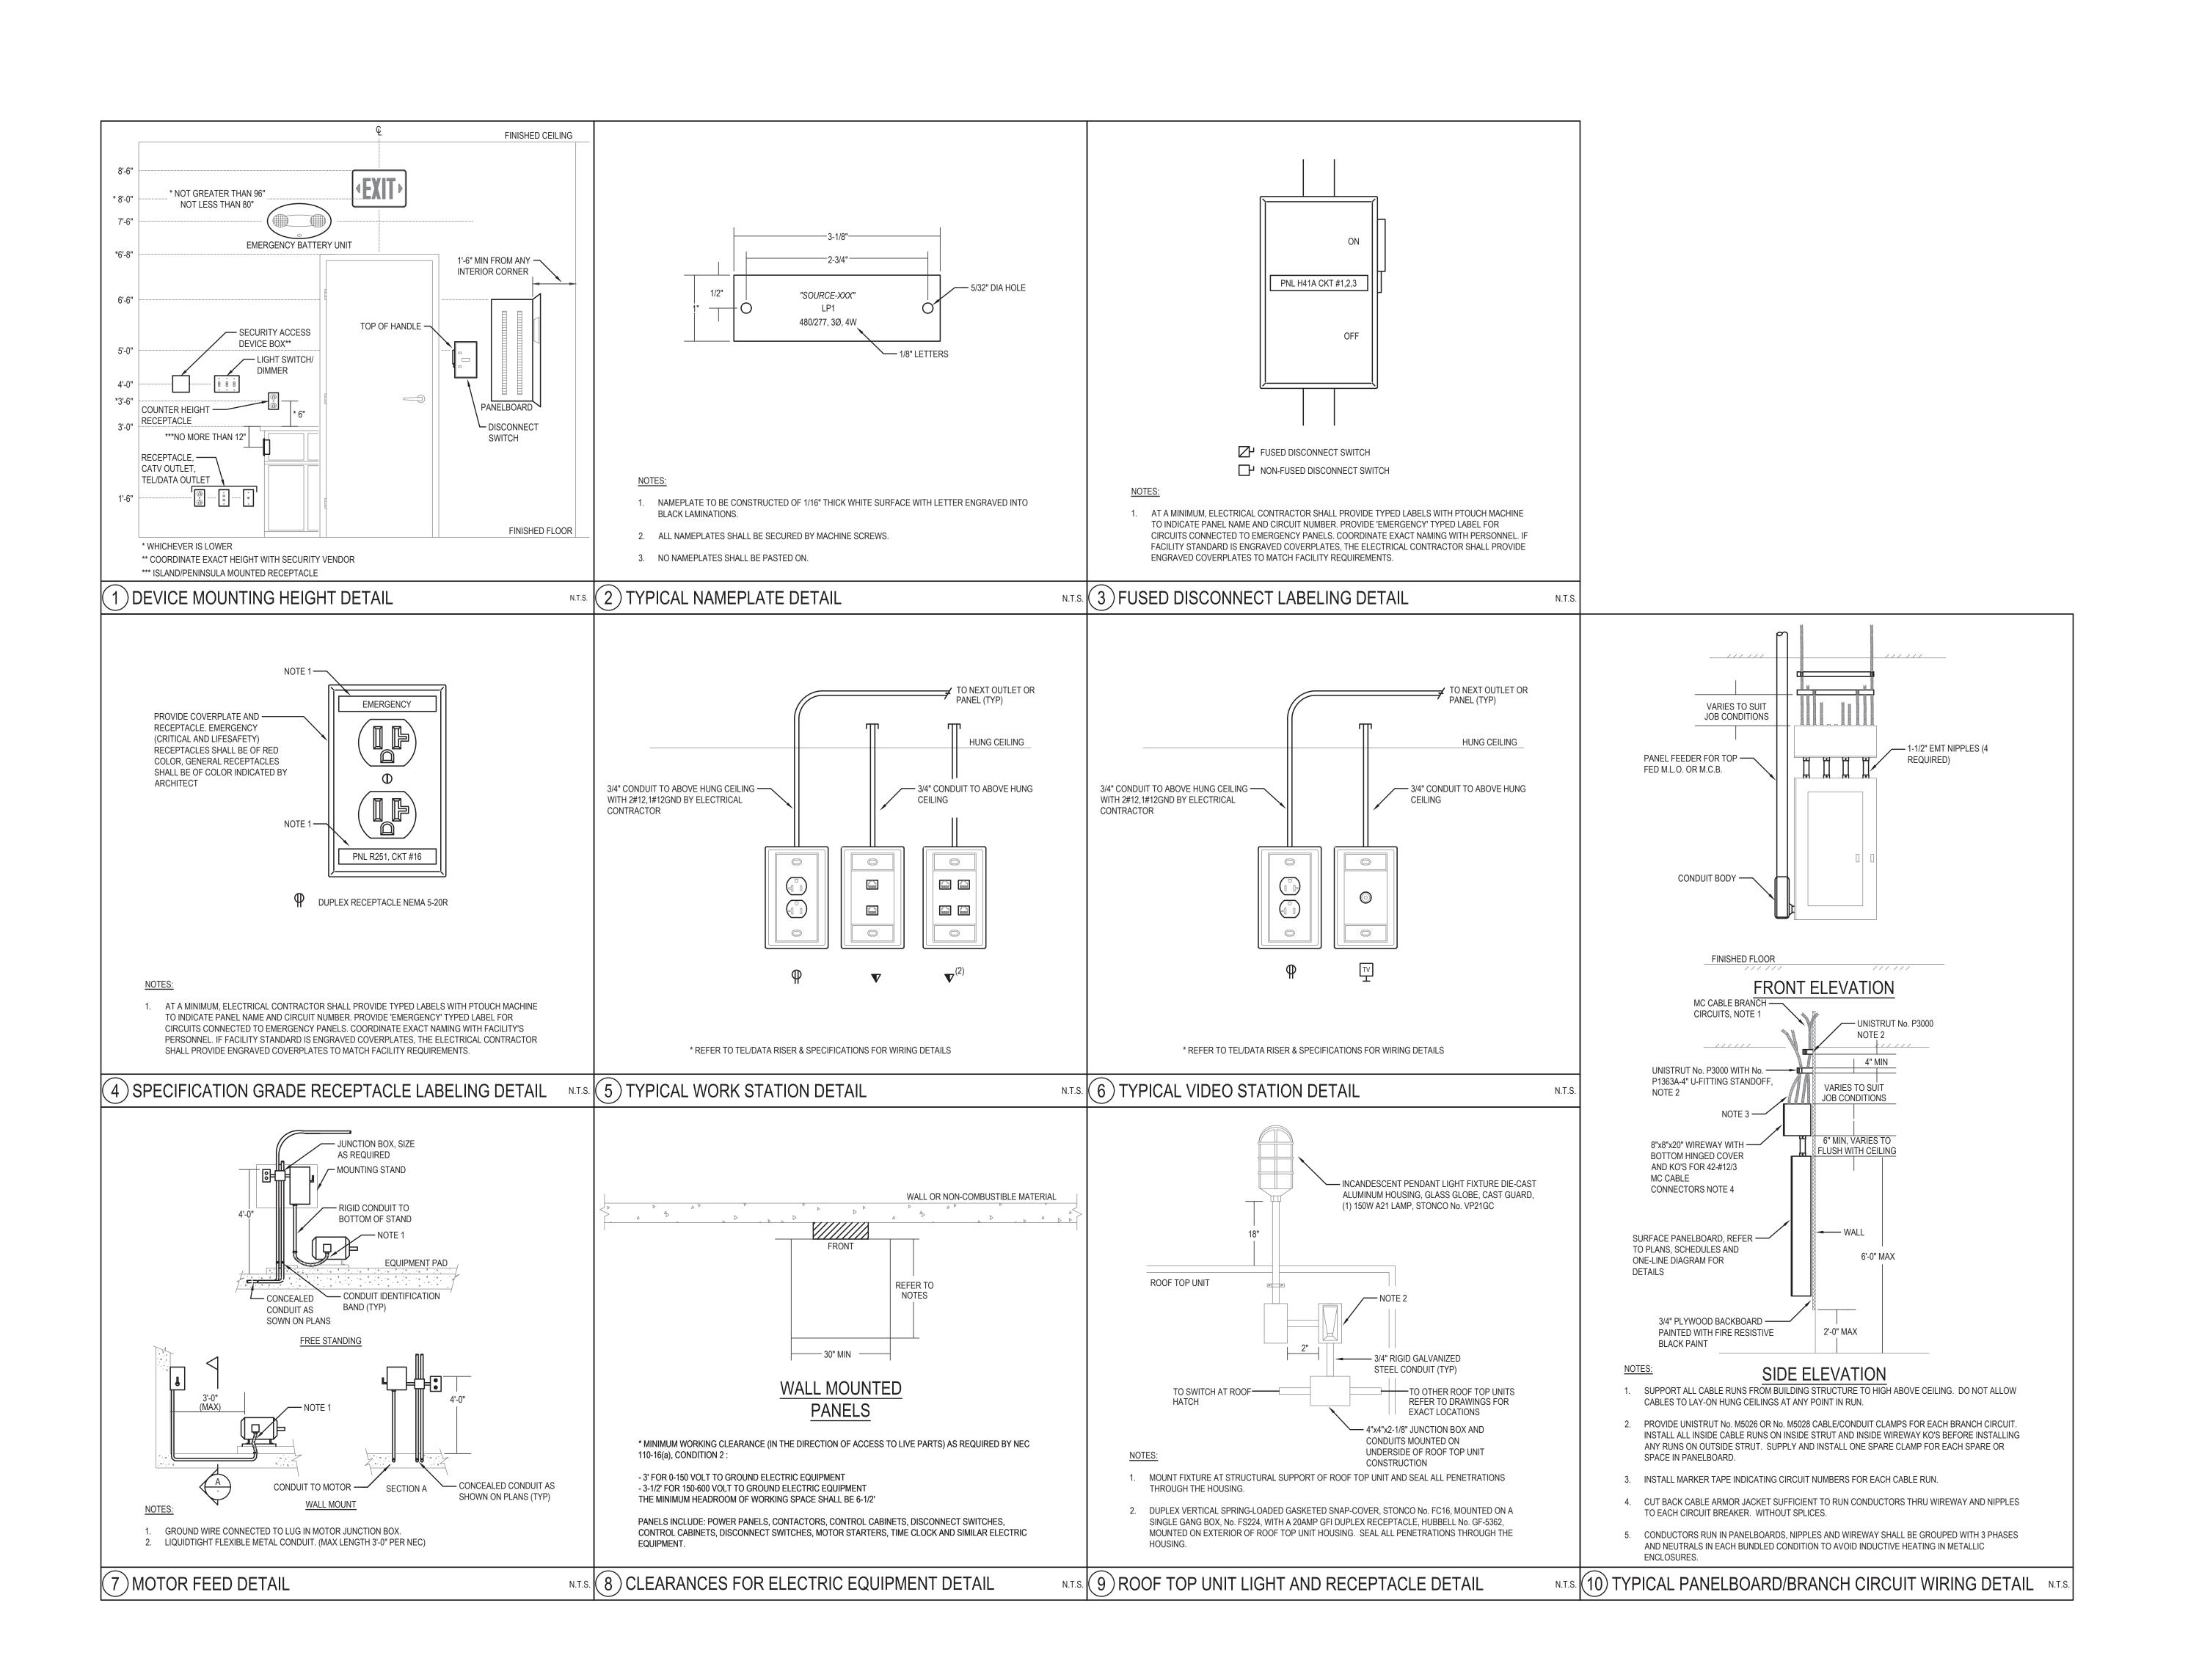




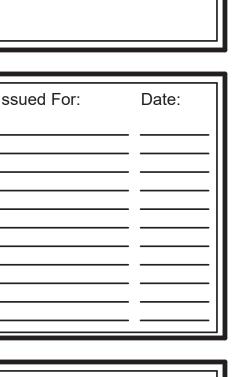

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FIRST FLOOR LIGHTING	
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E-101	

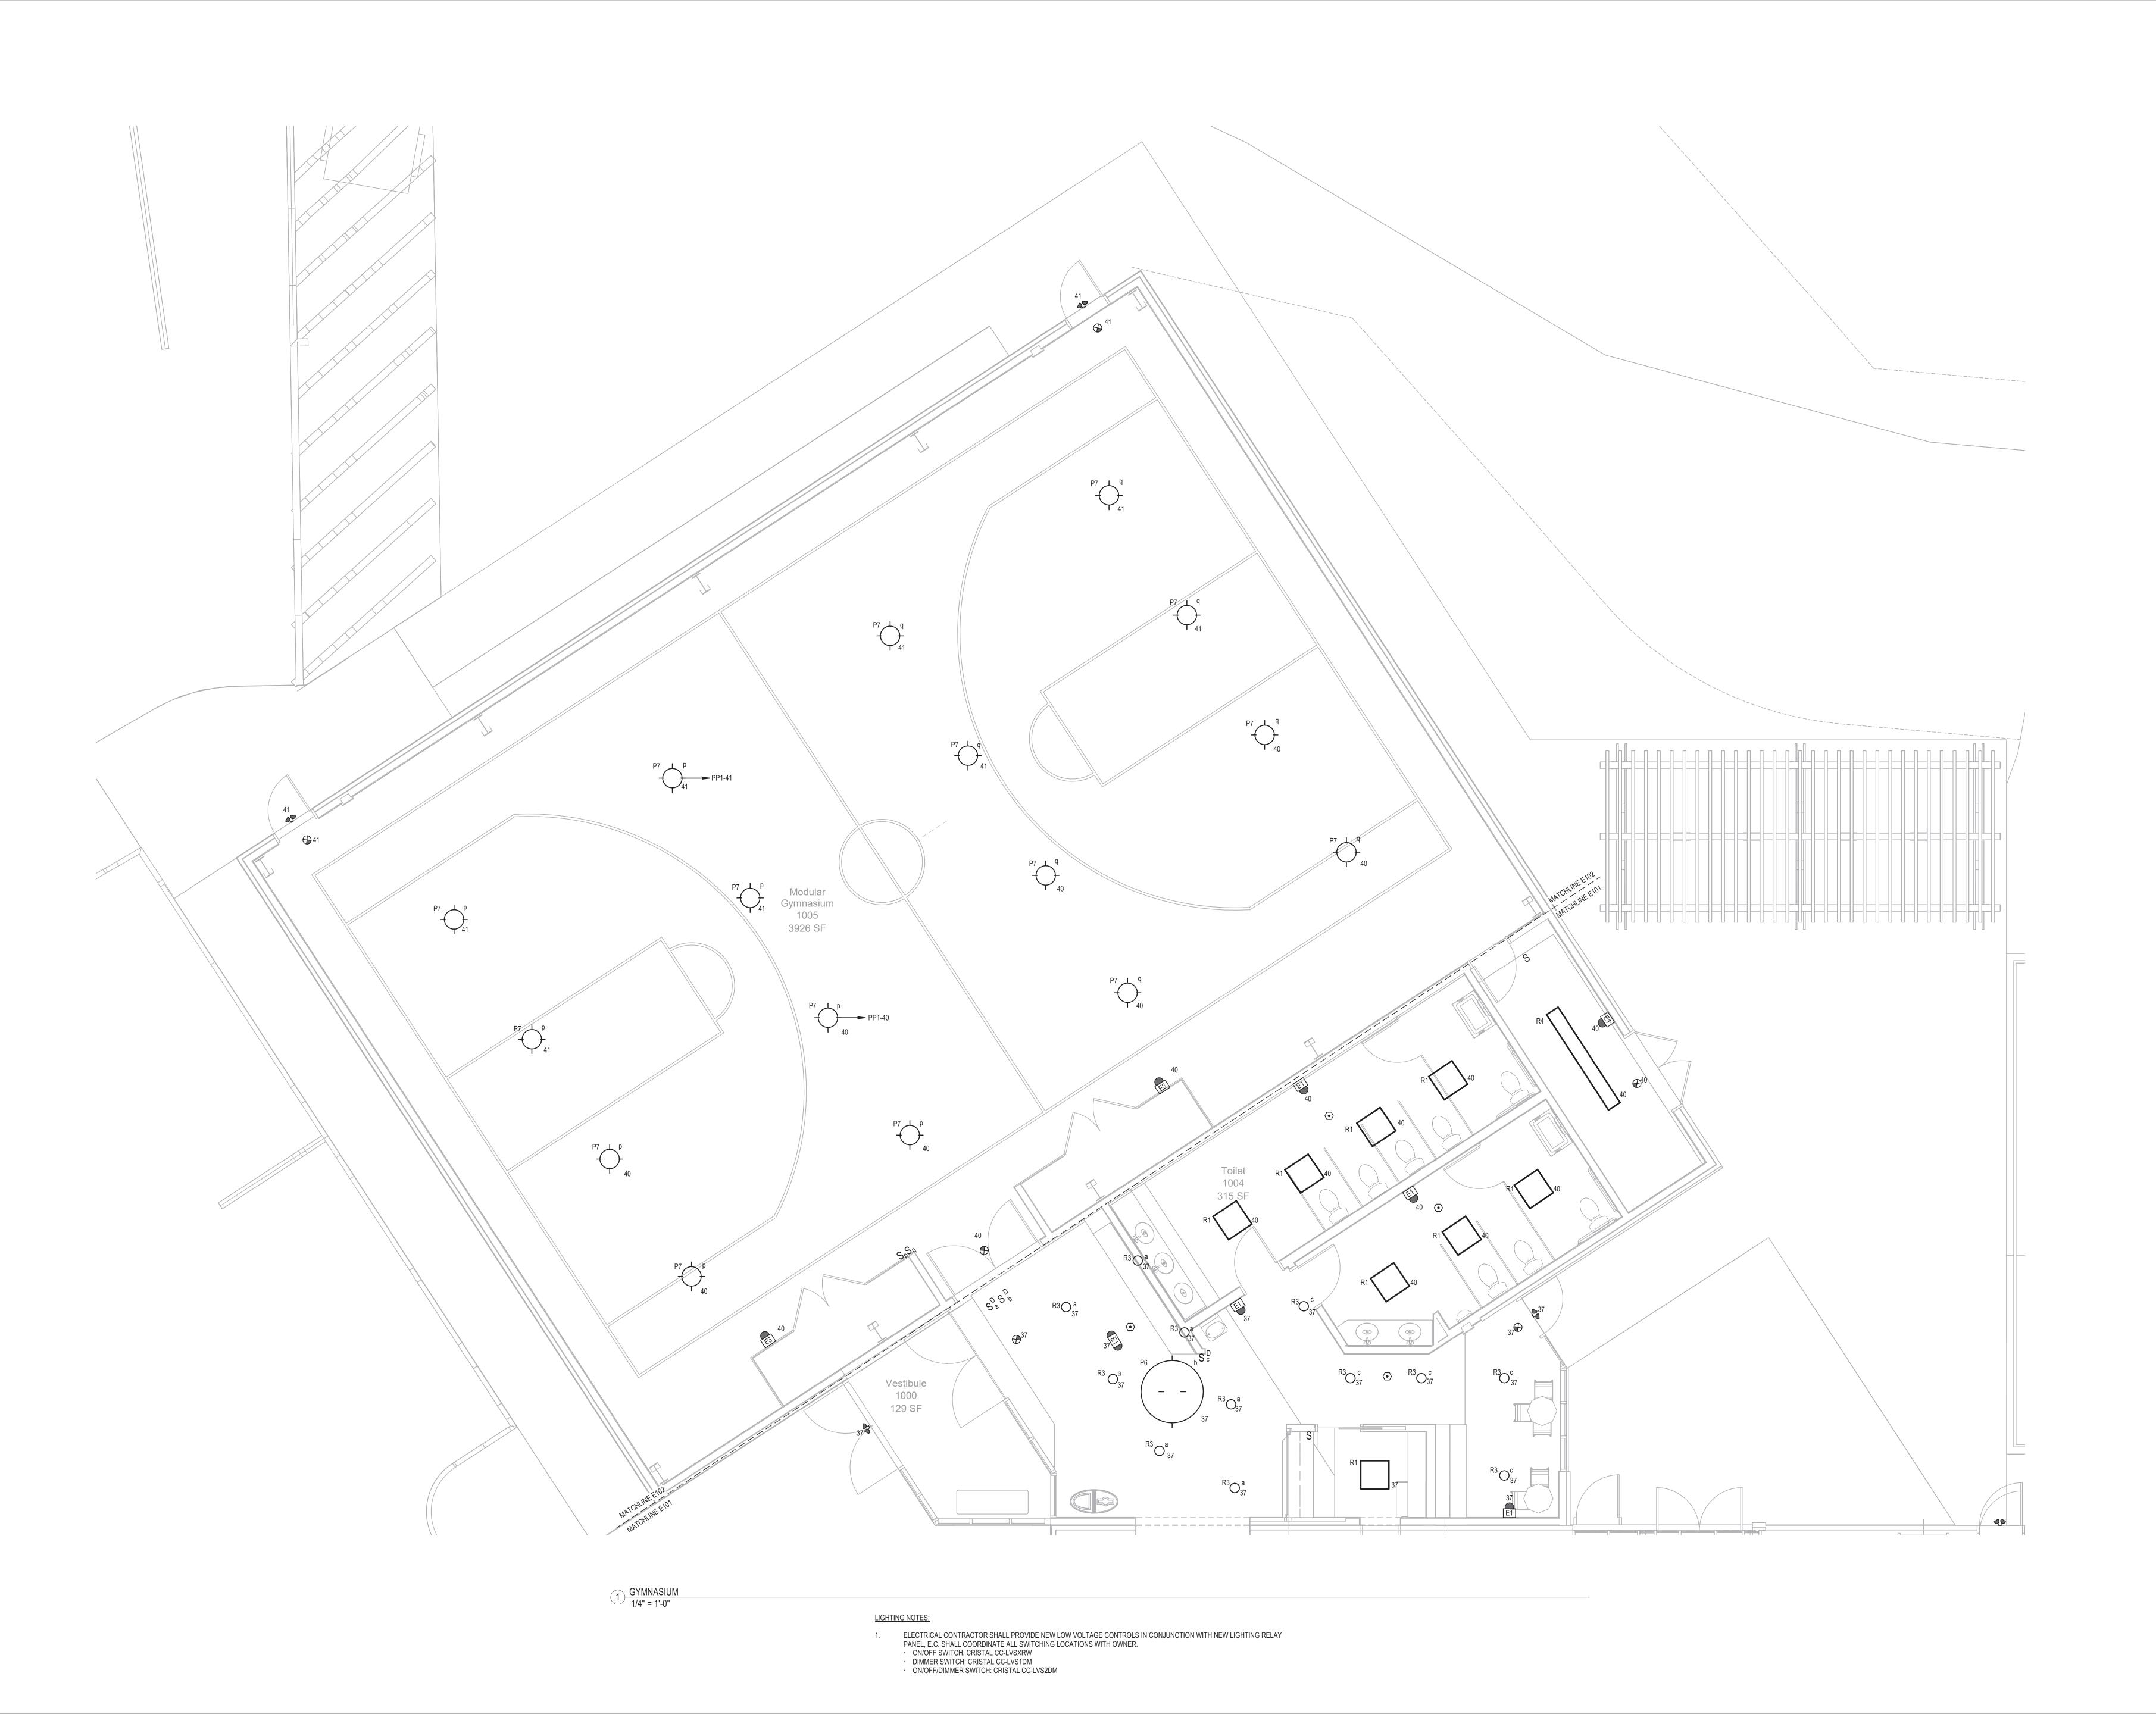


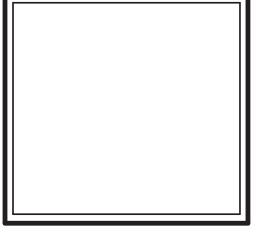





STRUCTURAL ENGINEER:
Shelley Engineering
MEP ENGINEER:
BLW Engineers
INTERIOR DESIGNER:
WDC Interiors

Newburyport Youth Service 59 Low Street Newburyport, MA 01950

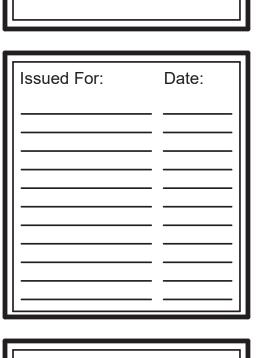

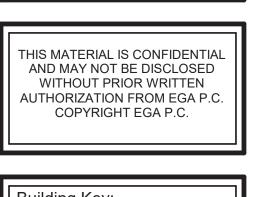


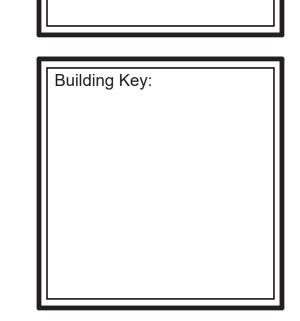

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GYMNASIUM
LIGHTING

Sheet Number: E-102

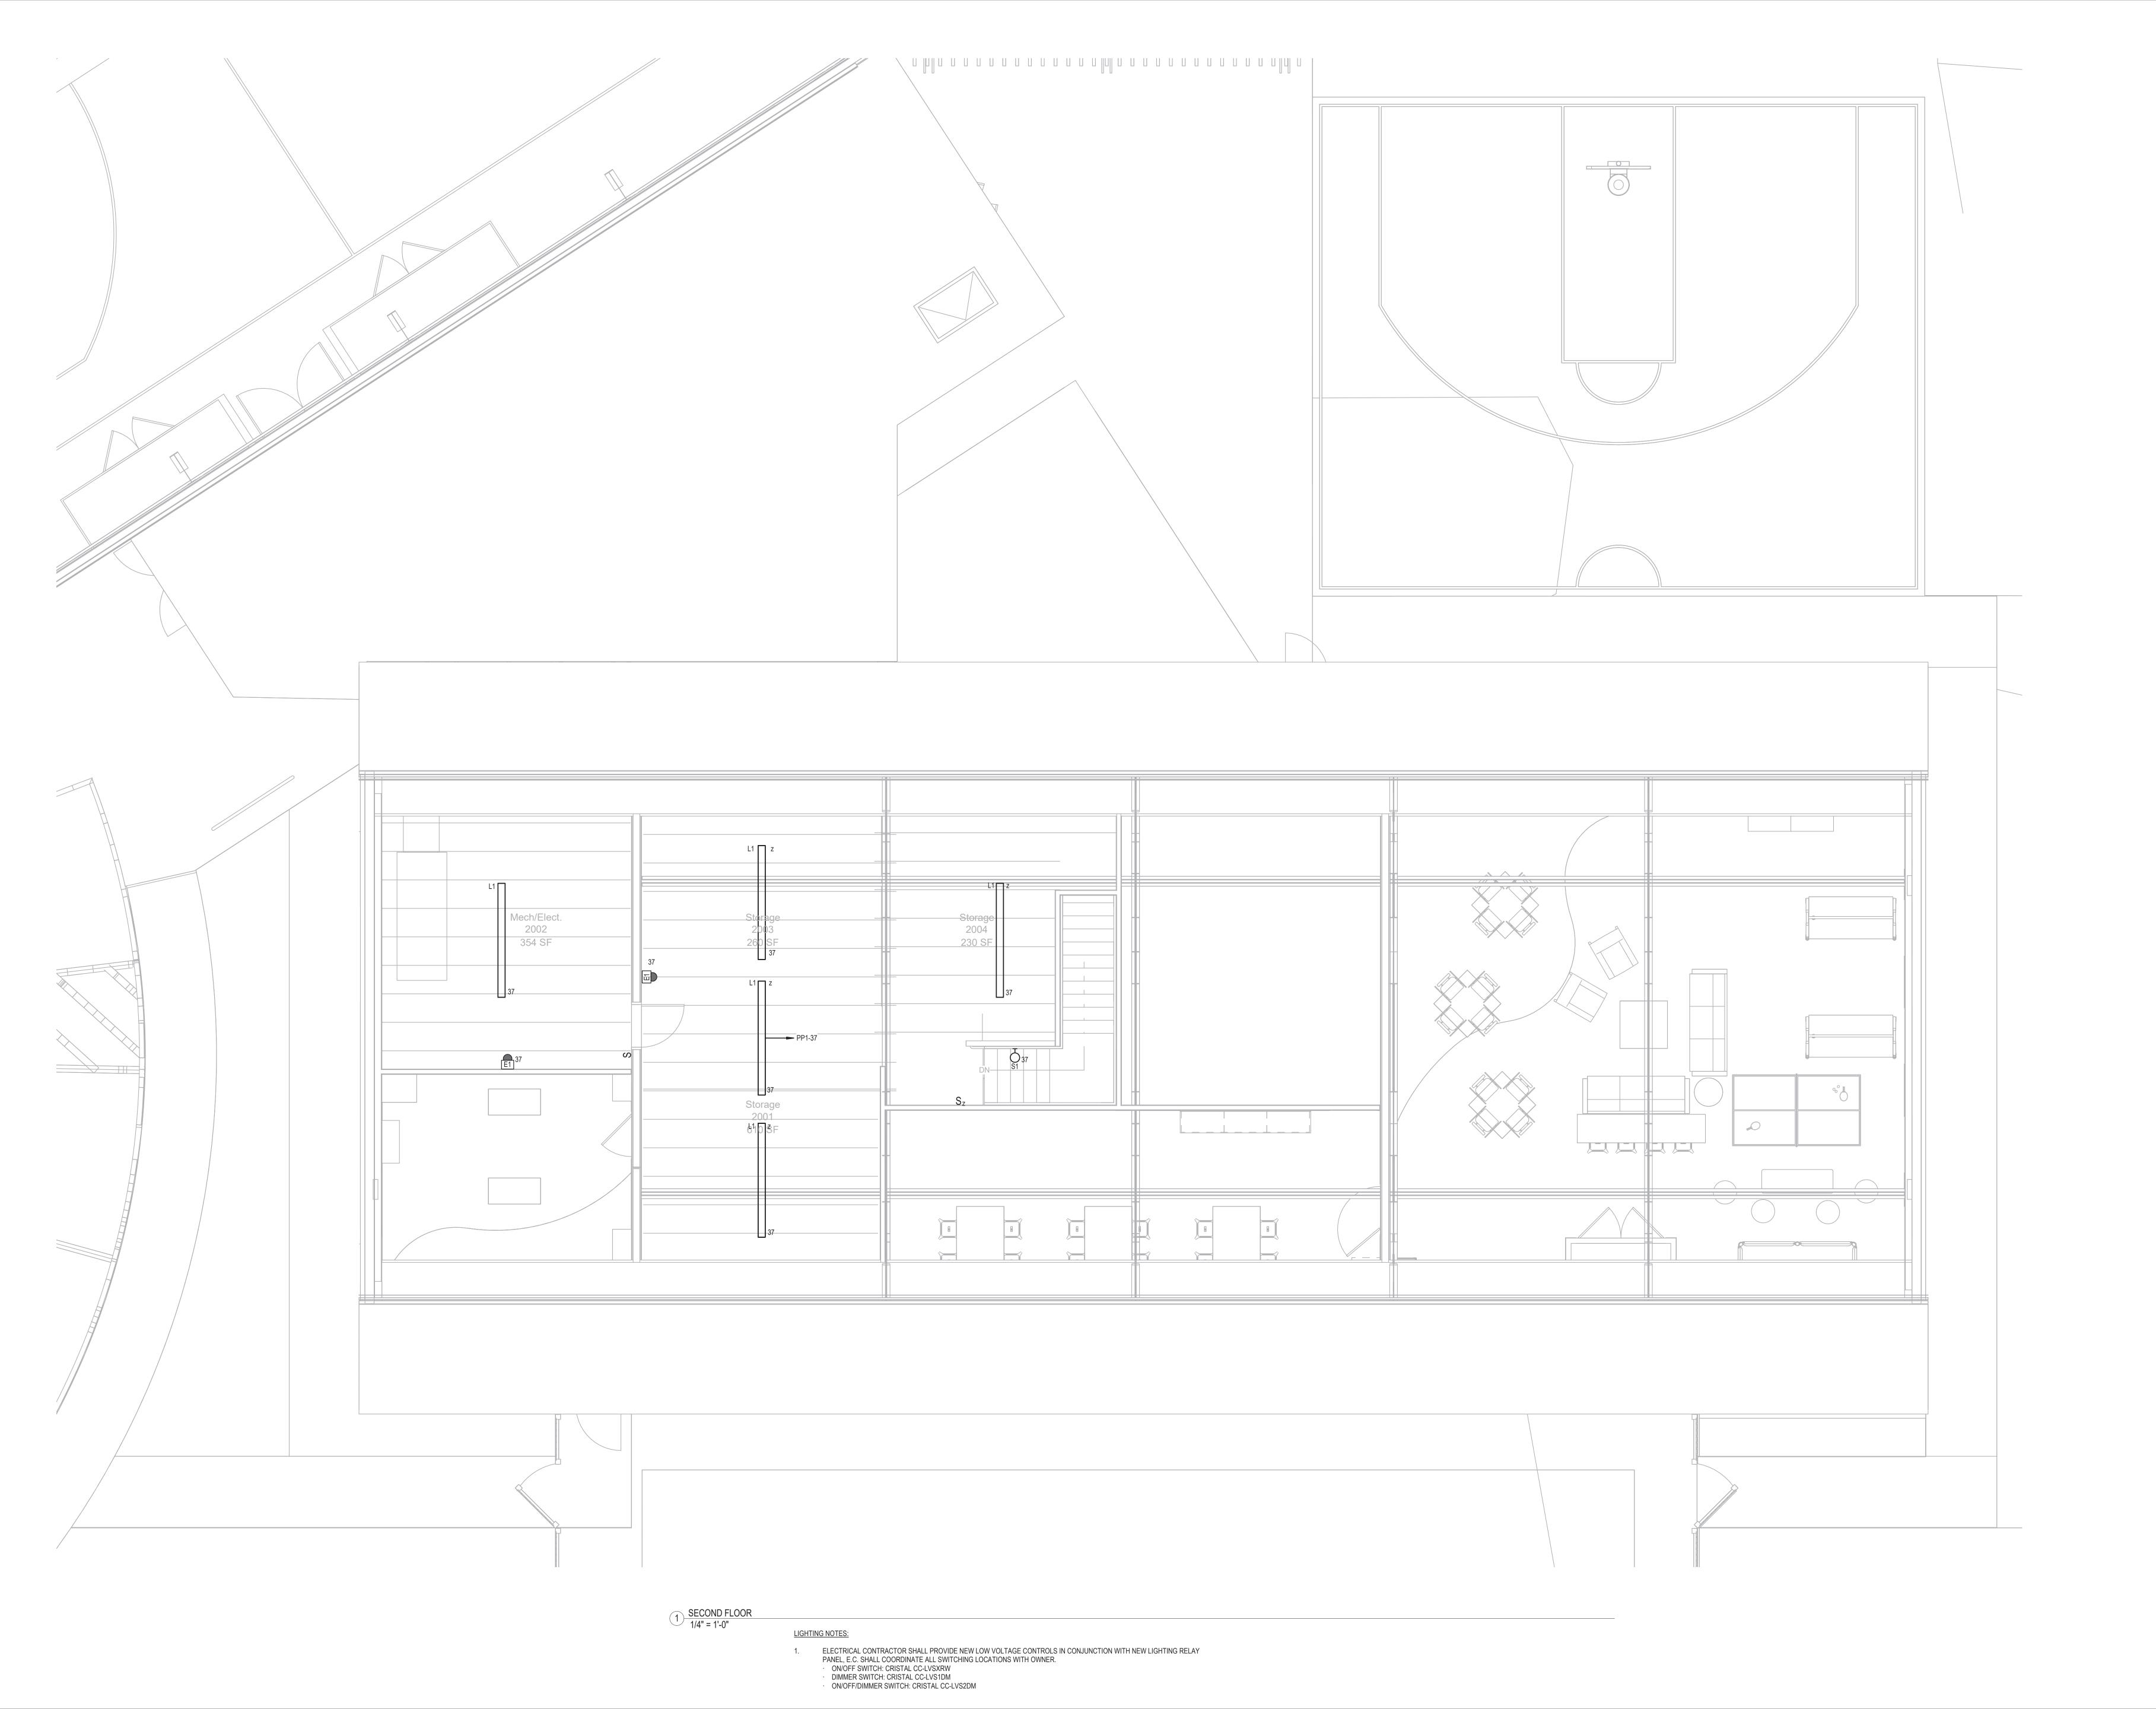

Sheet Title:

SECOND FLOOR
LIGHTING

Sheet Number:


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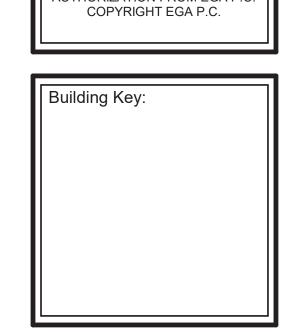
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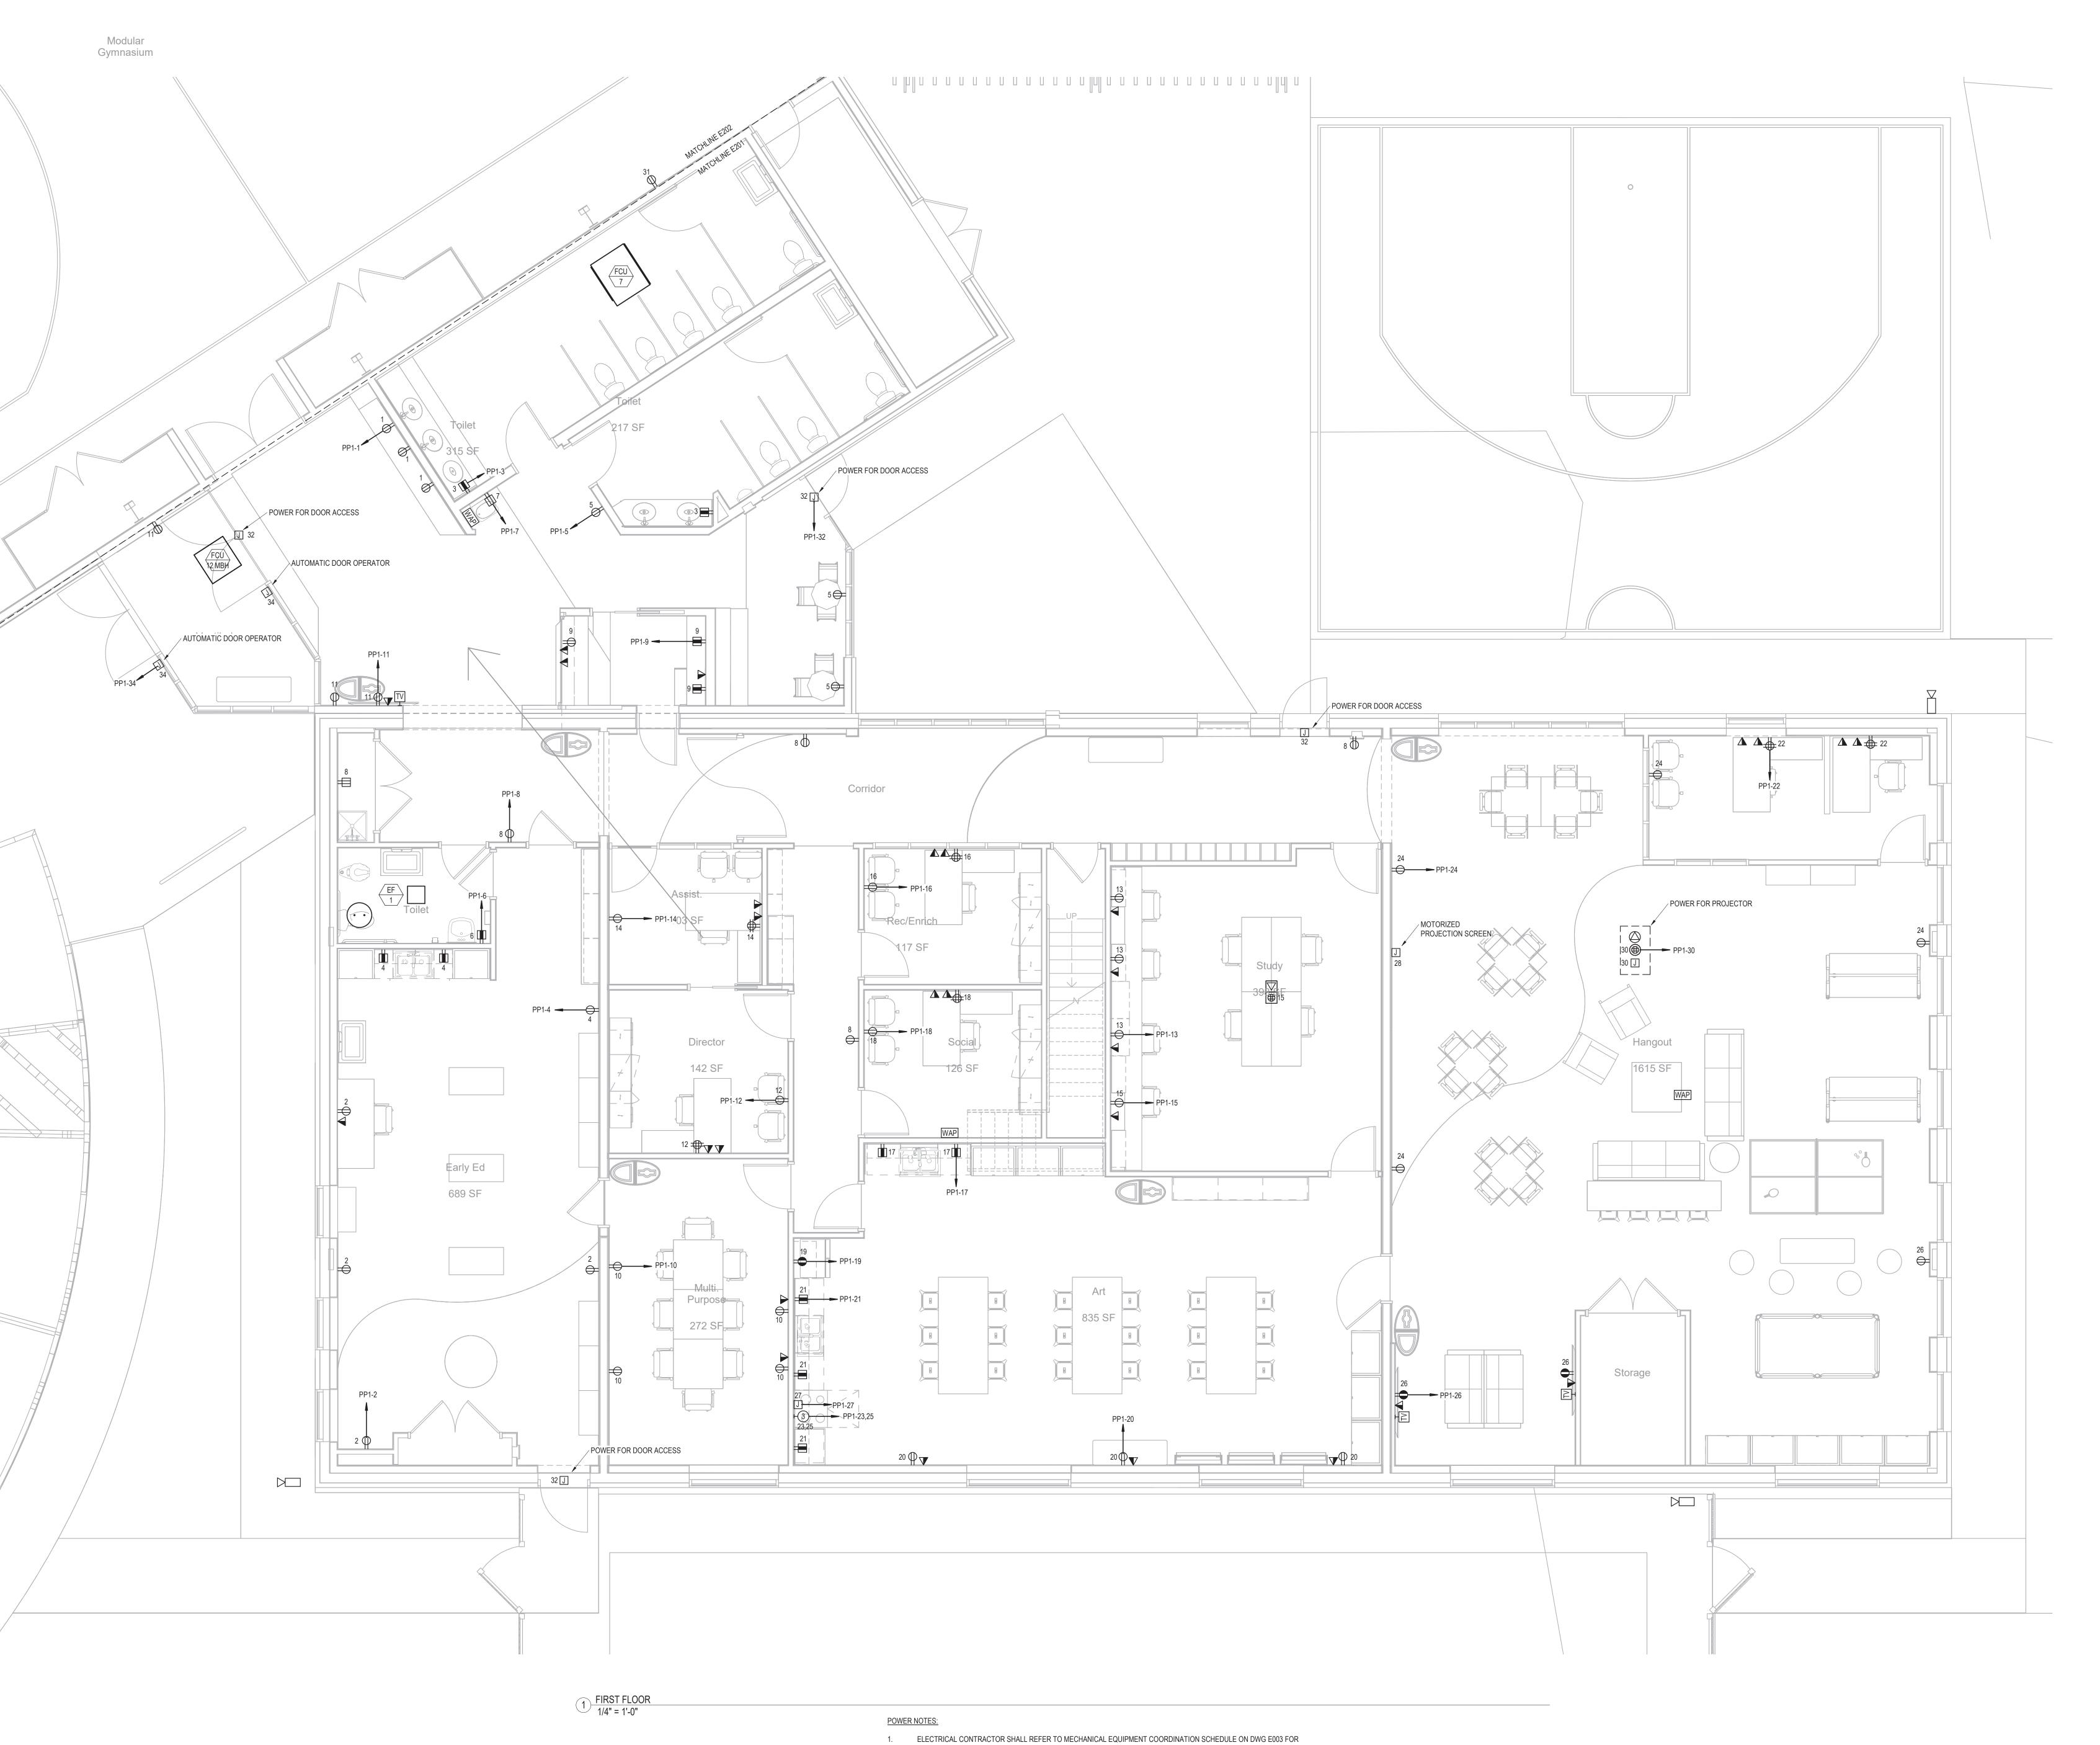
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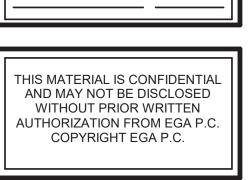





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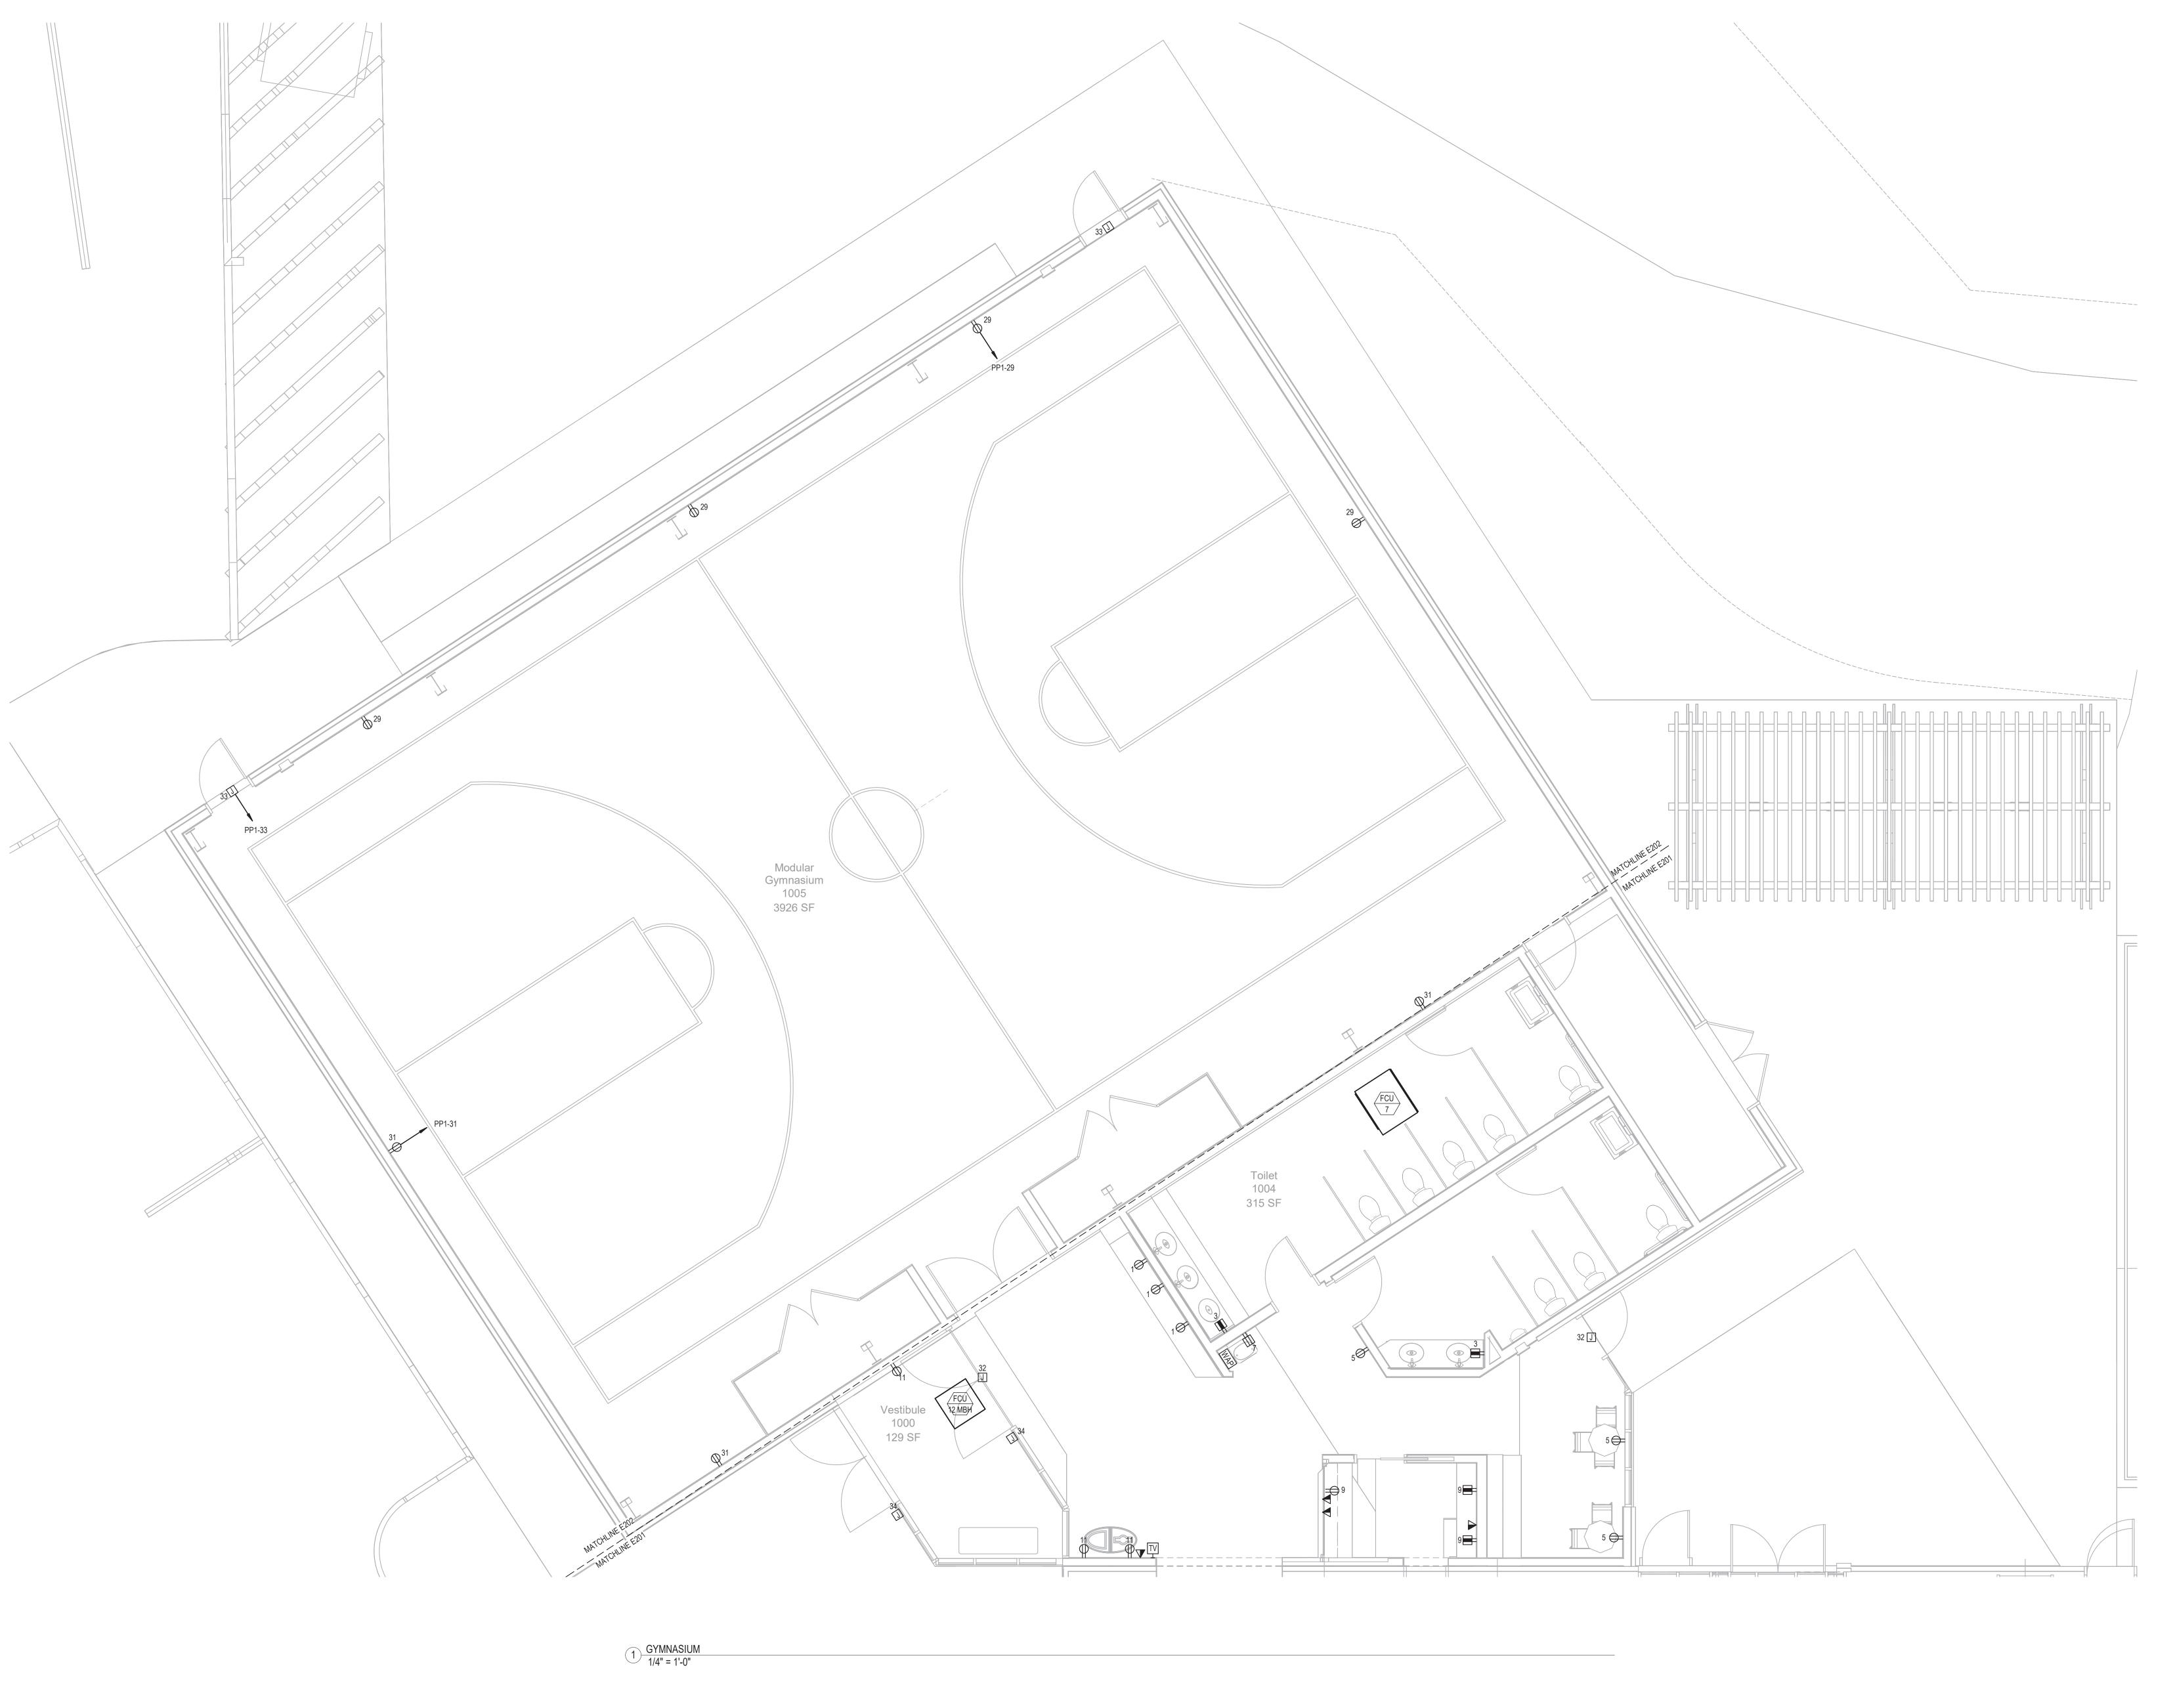




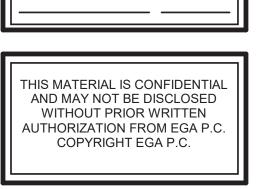


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FIRST FLOOR POWER
Sheet Number:
E-201

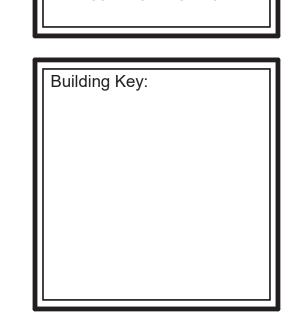MECHANICAL EQUIPMENT CONECTION DETAILS, BRANCH CIRCUITRY, DISCONNECTS, CIRCUIT BREAKERS, ETC.





POWER NOTES:


1. ELECTRICAL CONTRACTOR SHALL REFER TO MECHANICAL EQUIPMENT COORDINATION SCHEDULE ON DWG E003 FOR MECHANICAL EQUIPMENT CONECTION DETAILS, BRANCH CIRCUITRY, DISCONNECTS, CIRCUIT BREAKERS, ETC.

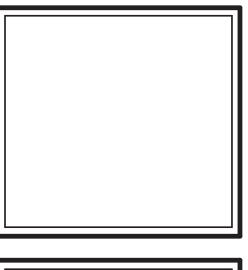





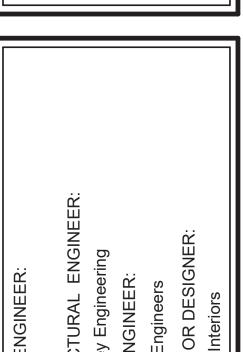

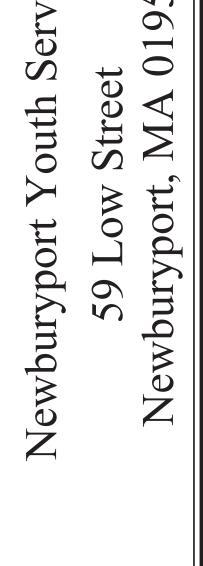


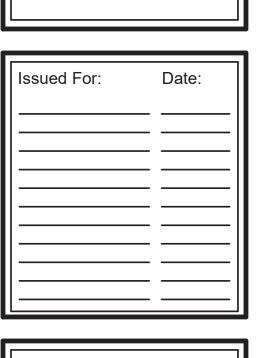


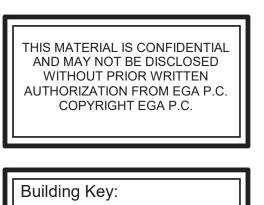

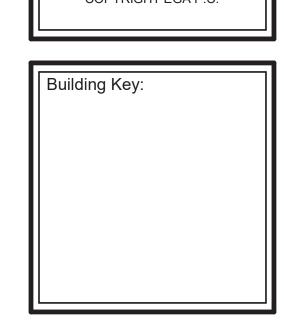


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	GYMNASIUM POWER
Shee	t Number:
	E-202

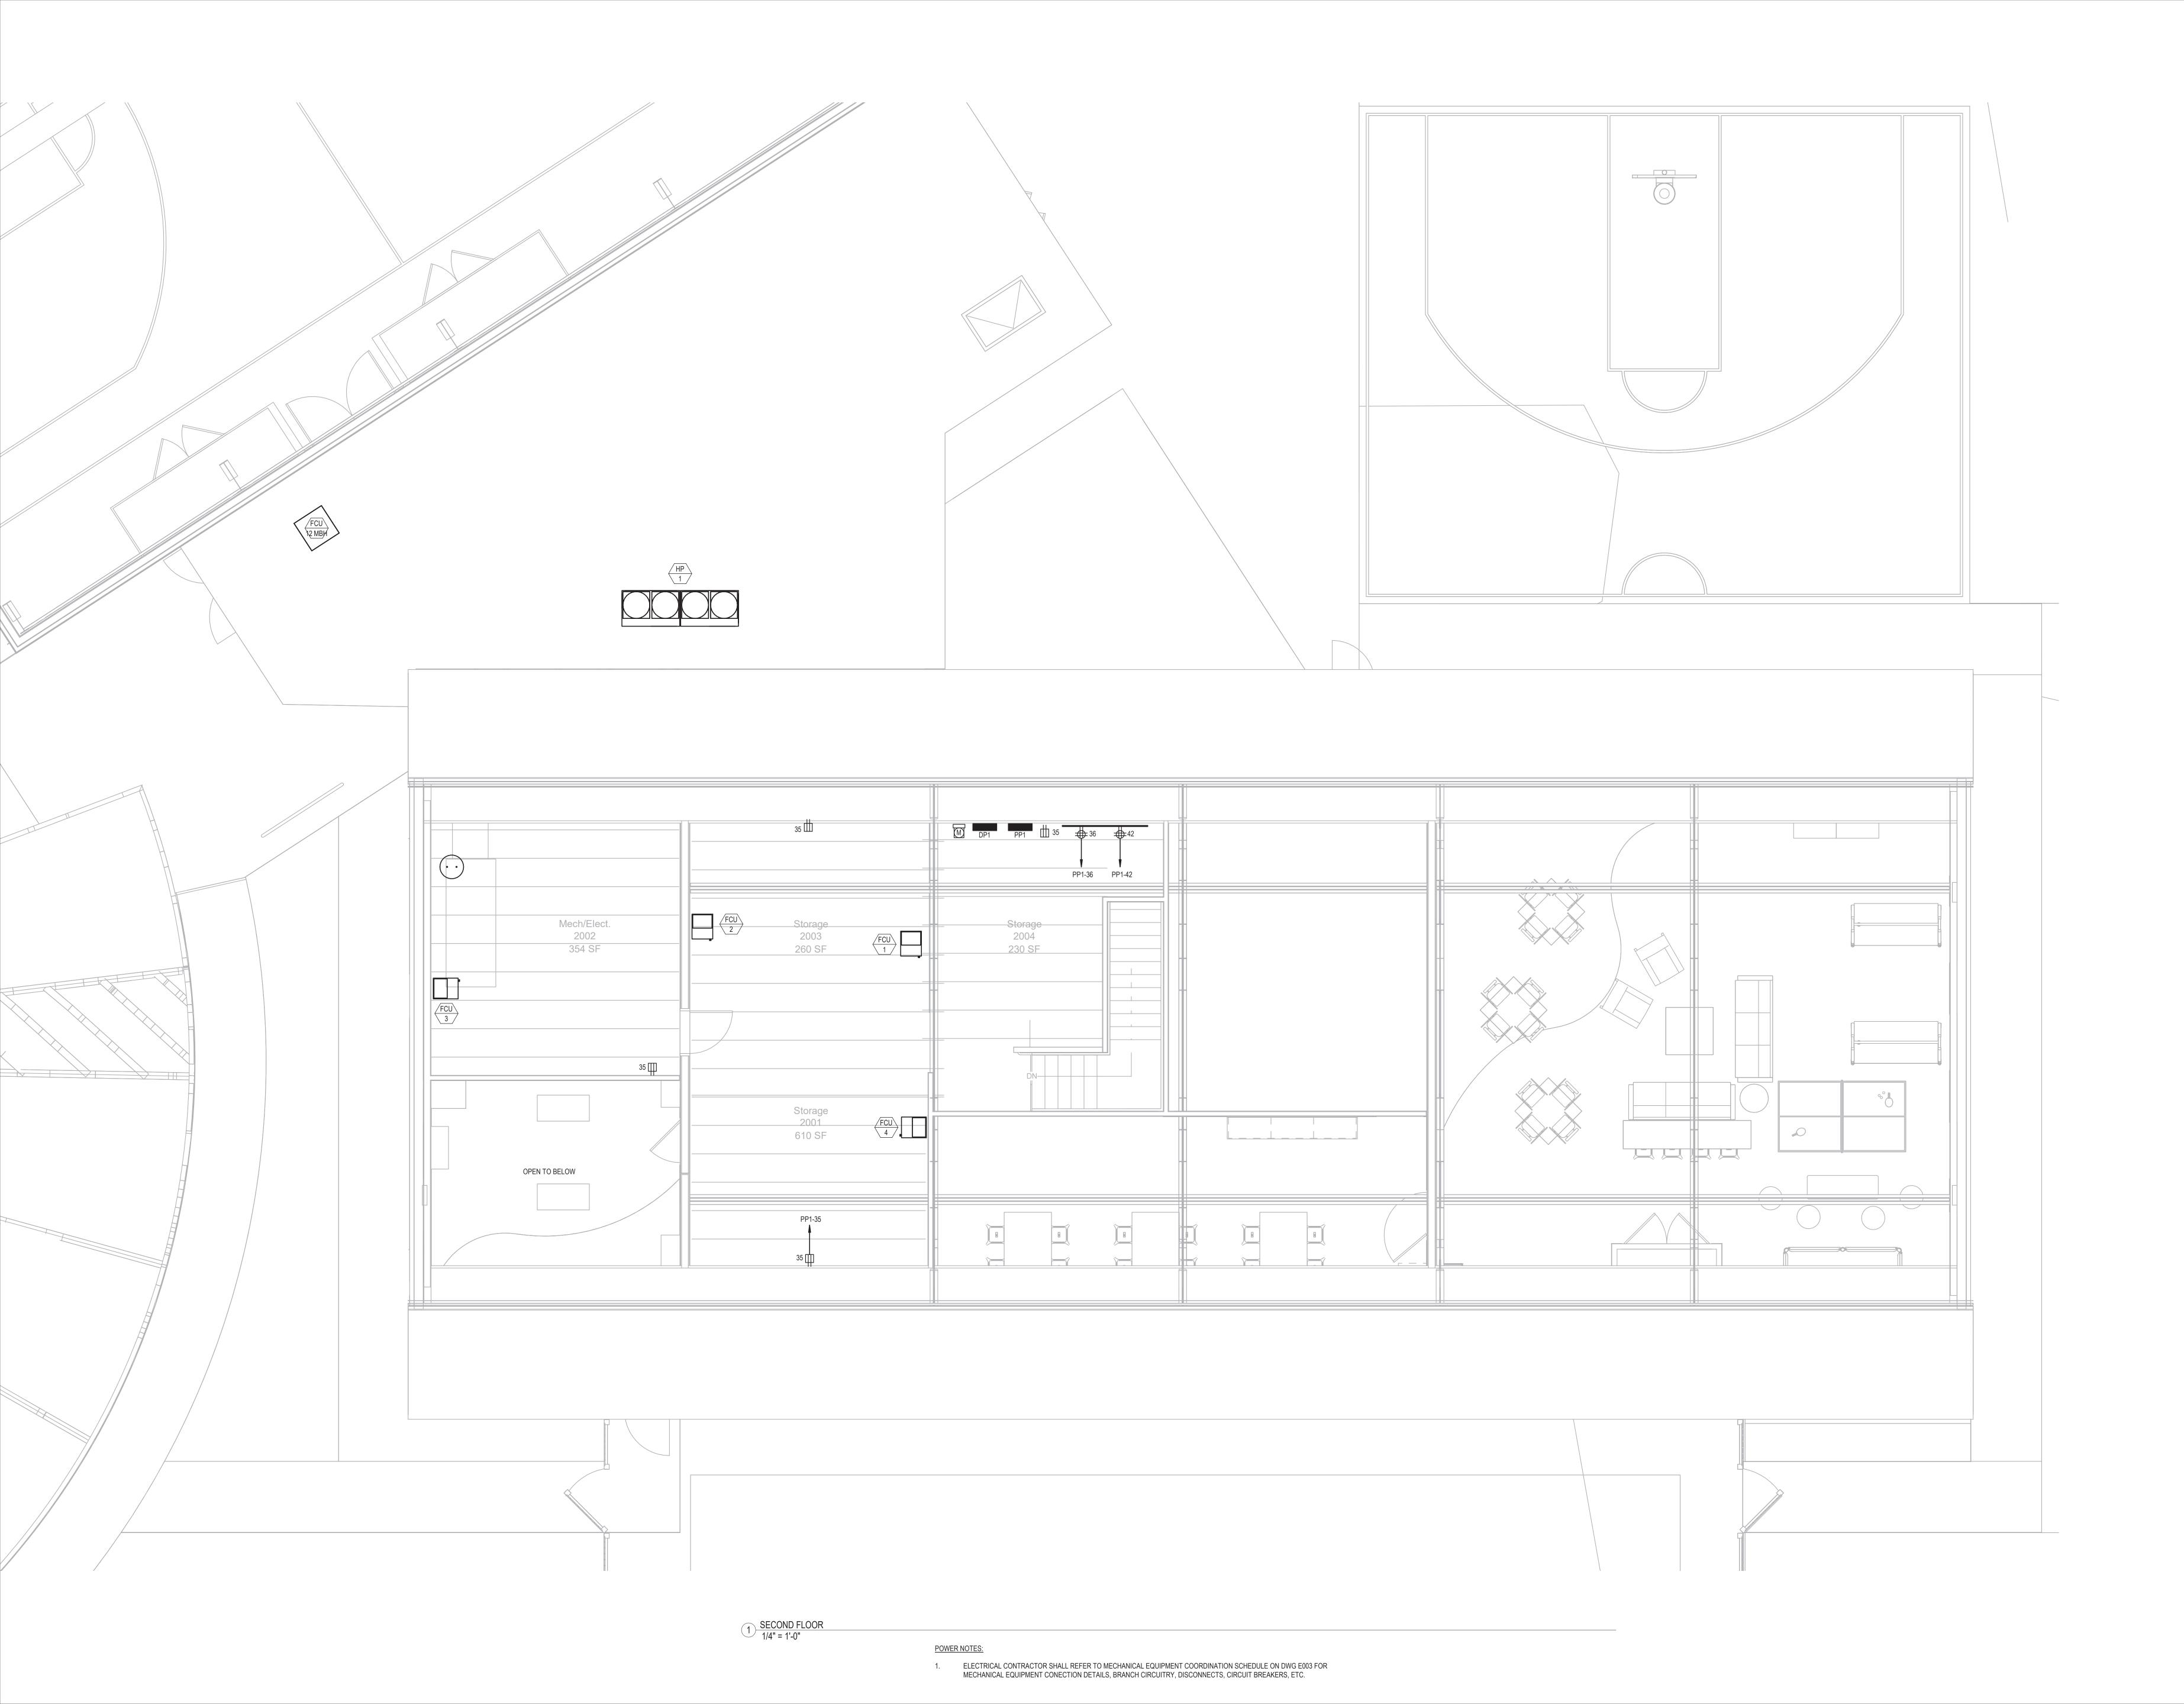


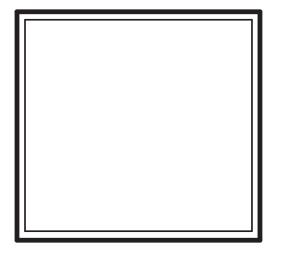





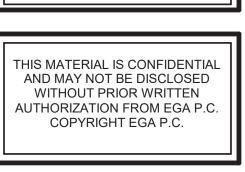

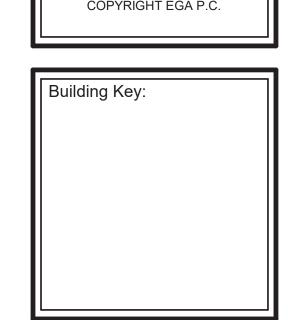

Sheet Title:
SECOND FLOOR POWER
Sheet Number: E-203

FIRE ALARM SPECIFICATION

 FIRE DETECTION AND ALARM SYSTEM 1.1. GENERAL

1.1.1. REFER TO FRONT END ELECTRICAL SPECIFICATIONS SHEETS FOR ALL PROJECT REQUIREMENTS.

AT NO TIME DURING CONSTRUCTION SHALL THE BUILDING BE WITHOUT FIRE ALARM PROTECTION. THE CONTRACTOR MUST OBTAIN A PERMIT FROM THE FIRE DEPARTMENT PRIOR TO COMMENCEMENT OF EQUIPMENT

INSTALLATION. ALL WORK SHALL BE DONE IN CONFORMANCE WITH THE LOCAL FIRE DEPARTMENT INSTALLATION REQUIREMENTS ALL FIRE ALARM WORK BEYOND THE MASTER BOX AND INSIDE OF THE BUILDING SHALL BE THE RESPONSIBILITY OF THE

CONTRACTOR. ABSOLUTELY NO CONNECTIONS SHALL BE MADE TO THE MUNICIPAL FIRE ALARM CIRCUITS, EXCEPT BY THE LOCAL 1.1.5. ALL FIRE ALARM DEVICES AND EQUIPMENT USED SHALL BE APPROVED FOR USE BY THE LOCAL FIRE DEPARTMENT.

THE CONTRACTOR SHALL FURNISH, INSTALL AND PLACE IN OPERATION AN ADDRESSABLE, SUPERVISED, GENERAL EVACUATION FIRE ALARM SYSTEM FOR THE COMPLETE BUILDING, UNLESS NOTED OTHERWISE.

THE COMPLETED FIRE ALARM SYSTEM SHALL MEET ALL LOCAL AND STATE CODES.

EQUIPMENT AND COMPLETED INSTALLATION SHALL BE U.L. LISTED OR APPROVED AND SHALL MEET APPROVAL OF THE LOCAL FIRE DEPARTMENT, STATE FIRE MARSHALL, AUTHORITIES HAVING JURISDICTION AND SHALL BE IN ACCORDANCE WITH THE APPLICABLE SECTIONS OF THE LATEST EDITION OF THE NATIONAL ELECTRICAL CODE, ADA CODE, NFPA 70, 72 AND 72E. THE COMPLETE SYSTEM SHALL CONTAIN SMOKE DETECTION, AUDIO/VISUAL ALARMS, PULL STATIONS, DUCT SMOKE DETECTORS,

WATER AND TAMPER FLOW SWITCHES AND OTHER DEVICES INCLUDING POWER SUPPLIES AS REQUIRED FOR A COMPLETE 1.1.10. THE OWNER SHALL BE RESPONSIBLE FOR TELEPHONE CONNECTION COMPANY CHARGES AND/OR SECOND PARTY MONITORING

COMPANY FEES. DEVICE ADDRESSES SHALL BE LEGIBLE WITHOUT REMOVAL OF THE DETECTOR. THE DETECTOR ADDRESS SHALL BE CONCEALED WHEN PLACED INTO THE BASE.

1.1.12. THE CONTRACTOR SHALL BE RESPONSIBLE FOR INSTALLATION OF DEDICATED TELEPHONE HOMERUN WIRING. 1.2. MAIN FIRE ALARM CONTROL PANEL (FACP)

ELECTRICAL CONTRACTOR SHALL PROVIDE AN ADDRESSABLE MAIN FIRE ALARM CONTROL PANEL. CONTROL PANEL SHALL CONTAIN THE REQUIRED NUMBER OF SUPERVISED INITIATING AND INDICATING CIRCUITS FOR THE BUILDING. THE SYSTEMS SHALL HAVE BUILT-IN 24 VOLTS DC POWER SUPPLY AND INTEGRAL BATTERY CHARGER.

TWENTY-FOUR (24) HOURS OF BATTERY STANDBY POWER SHALL BE PROVIDED WITH FIFTEEN (15) MINUTES - VOICE OF ALARM SIGNALING AT THE END OF THIS TWENTY-FOUR (24) HOUR PERIOD, AS REQUIRED BY NFPA 72. ALSO PROVIDE 20% ADDITIONAL BATTERY CAPACITY

LIGHTNING PROTECTION SHALL BE INCLUDED WITHIN THE FACP TO PROTECT THE PANEL FROM LIGHTNING SURGES ON THE 120 VOLT SUPPLY CIRCUIT. THE FACP SHALL TRANSMIT AN ALARM SIGNAL (VIA PRIMARY AND BACK-UP MEANS) TO THE LOCAL FIRE DEPARTMENT VIA

METHODS COORDINATED WITH THE LOCAL FIRE DEPARTMENT. IN ACCORDANCE WITH NFPA 72, COMMON METHODS ARE THE FACP SHALL HAVE A DIGITAL ALARM COMMUNICATOR TRANSMITTER (DACT) TO ENABLE AUTOMATIC TRANSMISSION OF THE ALARM SIGNAL TO THE FIRE DEPARTMENT.

1.2.5.2. DACT CELLULAR COMMUNICATOR 1.2.5.3. AES MESH NETWORK COMMUNICATOR PER LOCAL FIRE DEPARTMENT REQUIREMENTS

BECAUSE OF THE TIME DELAY BETWEEN DESIGN AND CONSTRUCTION AND COMMUNICATION METHOD CHANGES BY LOCAL FIRE DEPARTMENTS, FOR BOTH PRIMARY AND BACK MEANS OF TRANSMISSION THE CONTRACTOR SHALL COORDINATE EXACT METHODS WITH THE LOCAL FIRE DEPARTMENT DURING CONSTRUCTION.

1.3. SEQUENCE OF OPERATIONS: REFER TO SEQUENCE OF OPERATIONS INPUT/OUTPUT MATRIX

1.4. REMOTE DEVICES

SMOKE DETECTORS SHALL BE ADDRESSABLE PHOTOELECTRIC TYPE (UNLESS NOTED OTHERWISE) AND SHALL OPERATE AT 24 VOLTS DC. PROVIDE DOUBLE CONTACT BASE FOR SMOKE DETECTORS USED FOR ELEVATOR RECALL AND TO OPERATE REMOTE

HEAT DETECTORS SHALL BE ADDRESSABLE (UNLESS NOTED OTHERWISE), LOW PROFILE, MATTE WHITE, 200 DEGREE FIXED TEMPERATURE OR 135 DEGREES RATE OF RISE TYPE.

DUCT SMOKE DETECTORS SHALL BE ADDRESSABLE PHOTOELECTRIC TYPE. COMPLETE WITH REMOTE TEST STATIONS AND SAMPLING TUBES. REMOTES TEST STATIONS SHALL HAVE RED LED INDICATING LIGHT AND STAINLESS STEEL FACEPLATE. DUCT SMOKE DETECTORS SHALL SHUT OFF ASSOCIATED AIR HANDLING UNIT UPON ACTIVATION. DETECTORS SHALL BE PURCHASED BY

THE ELECTRICAL CONTRACTOR AND INSTALLED BY THE MECHANICAL CONTRACTOR. PROVIDE AND INSTALL ALL NECESSARY WIRE, CONDUIT, RELAYS AND CONNECTIONS FROM ALL DUCT SMOKE DETECTORS TO THEIR ASSOCIATED RETURN AND SUPPLY FAN CONTROLLERS. UPON ACTIVATION OF A DUCT SMOKE DETECTOR, IN ADDITION TO SOUNDING THE GENERAL ALARM, THE DUCT SMOKE DETECTOR SHALL IMMEDIATELY SHUT DOWN THE

HORN/STROBE DEVICES SHALL BE PROVIDED IN A COMMON ENCLOSURE. THE VISIBLE STROBE SHALL MEET ALL THE

PULL STATIONS SHALL BE ADDRESSABLE (UNLESS NOTED OTHERWISE), SEMI-FLUSH, DOUBLE ACTION.

REQUIREMENTS OF THE ADA. MONITOR MODULES SHALL BE PROVIDED TO MONITOR AND CONNECT CONVENTIONAL INITIATING DEVICES ONTO THE

EXTERIOR ALARM BELLS SHALL BE 120 VOLTS AC, 6 INCH DIAMETER RED, SUITABLE FOR WET LOCATION. BELLS ARE PROVIDED BY FPC, 120 VOLT WIRED BY ELECTRICAL CONTRACTOR.

REMOTE ALARM INDICATORS SHALL BE LED INDICATORS ON SINGLE PLASTIC PLATES.

CONTROL & RELAY MODULES SHALL BE USED TO CONTROL CONVENTIONAL DEVICES (NOTIFICATION CIRCUITS, AHU'S, DOOR HOLDERS, ETC). OVER THE ADDRESSABLE LOOP. MODULES SHALL BE PROVIDE A SUPERVISED OUTPUT RATED FOR 2 AMP AT 24

VOLTS DC AND 0.5 AMP AT 120 VOLT. PROVIDE A SUPERVISED EXTERIOR ROTATING BEACON 24 VOLTS DC WITH A RED LENS. BEACON SHALL MEASURE OVER FIVE (5)

INCHES IN HEIGHT FOR VISIBILITY. LOCATION SHALL BE DETERMINED BY THE LOCAL FIRE DEPARTMENT. KNOX BOX SHALL BE SURFACE MOUNTED NEAR THE FRONT ENTRY. BOX SHALL BE ALUMINUM WITH TAMPER SWITCH.

ELECTRICAL CONTRACTOR. SHALL PURCHASE THROUGH LOCAL FIRE DEPARTMENT. STROBE ONLY DEVICES SHALL BE PROVIDED AND SHALL MEET ALL REQUIREMENTS OF NFPA AND ADA CODES.

PROVIDE LED TYPE REMOTE ANNUNCIATOR, POSITIONED AS SHOWN ON THE DRAWINGS. THE ANNUNCIATOR SHALL BE FLUSH MOUNTED TYPE AND SHALL BE SUPERVISED FOR SYSTEM TROUBLE. ALL ALARM LED'S AND WIRING SHALL BE SUPERVISED. THE

NUMBER OF ZONES SHALL BE AS SHOWN ON THE DRAWINGS. 1.5. WIRING ALL FIRE ALARM WIRE AND CABLE SHALL BE UL LISTED FOR FIRE ALARM USE.

THE FIRE ALARM SYSTEM SHALL BE A COMPLETE AUTOMATIC AND MANUAL, CLOSED CIRCUIT, CLASS A, 4 WIRE, CONNECTED AND

FOR FIRE ALARM WIRING IN ENCLOSED SPACES, PROVIDE PLENUM RATED, TYPE FPLP, WITH RED OUTER JACKET. INSTALLATION SHALL MEET REQUIREMENTS OF NEC ARTICLE 770 AND 725. CONDUCTORS SHALL BE SOLID COPPER #14 MINIMUM, WITH LOW

FOR FIRE ALARM WIRING IN EXPOSED AREAS, PROVIDE TYPE THHN INSULATION. WIRE SIZE SHALL BE #14 AWG MINIMUM. ALL SURFACE MOUNTED WIRING RELATED TO THE FIRE ALARM SYSTEM SHALL BE INSTALLED IN TYPE EMT/RGS CONDUIT.

ALL JOINTS AND CONNECTIONS SHALL BE IN JUNCTION BOXES. ALL CONNECTIONS NOT ON APPROVED TERMINAL STRIPS SHALL BE SOLDERED AND TAPED. ALL JUNCTION BOXES SHALL BE PAINTED RED.

1.6. MANUFACTURERS COMPLETE SYSTEMS SHALL BE MANUFACTURED BY AUTOCALL, FCI (FIRE CONTROL INSTRUMENTS), EDWARDS, NOTIFIER OR

1.7. TESTING 1.7.1. THE CONTRACTOR SHALL BE RESPONSIBLE FOR ALL FIRE ALARM TESTING AND CERTIFICATION CHARGES.


CERTIFY THE INSTALLATION WITH ACCEPTANCE TESTING. THE ELECTRICAL CONTRACTOR SHALL CONDUCT THE ACCEPTANCE TEST WITH THE LOCAL FIRE DEPARTMENT IN ACCORDANCE WITH NFPA 72. TEST INCLUDE BUT MAY NOT BE LIMITED TO THE FOLLOWING: MEGGER (INSULATION) TESTING, LOOP CONTINUITY, GROUND, SHORT, OPEN CIRCUIT, A WRITTEN REPORT SHALL BE SUBMITTED DETAILING THE RESULTS OF THE PRELIMINARY TESTS SHALL ACCOMPANY THE REQUEST FOR FINAL ACCEPTANCE

	FIRE ALARM
AL DEVICE ANNO 15" INDICATES (DTATION: CANDELA RATING
F 15	AUDIO / VISUAL DEVICE "F" INDICATES HORN / VISUAL "S" INDICATES SPEAKER / VISUAL
□ 15	VISUAL ONLY DEVICE "L" INDICATES WHITE LENS FOR FIRE "C" INDICATES AMBER LENS FOR CARBON MONOXIDE
1 5	CEILING MOUNTED AUDIO / VISUAL DEVICE "F" INDICATES HORN / VISUAL "S" INDICATES SPEAKER / VISUAL
1 15	CEILING MOUNTED VISUAL ONLY DEVICE
F	MANUAL PULL STATION
⑤ _R	SMOKE DETECTOR "D" INDICATES DUCT SMOKE DETECTOR "R" INDICATES ELEVATOR RECALL "NS" INDICATES NON-SYSTEM DEVICE, 120V HARDWIRED WITH BATTERY BACKUP
FS	FIRE PROTECTION SYSTEM INTERFACE DEVICE "FS" INDICATES FLOW SWITCH MONITOR MODULE "TS" INDICATES TAMPER SWITCH MONITOR MODULE "PS" INDICATES PRESSURE SWITCH MONITOR MODULE "PIV" INDICATES POST INDICATOR VALVE MONITOR MODULE
FACP	FIRE ALARM DEVICE "FACP" INDICATES FIRE ALARM CONTROL PANEL "ANN" INDICATES FIRE ALARM ANNUNCIATOR PANEL "DACT" INDICATES DIGITAL ALARM COMMUNICATOR TRANSMITTER "CELL" INDICATES CELLULAR COMMUNICATOR "RADIO" INDICATES RADIO COMMUNICATOR "CM" INDICATES CONTROL MODULE "MM" INDICATES MONITOR MODULE "KB" INDICATES KEY BOX "RTS" INDICATES REMOTE TEST STATION
ŒΉ	FIRE ALARM ANNUNCIATION DEVICE "B" INDICATES ALARM BELL, 120V HARDWIRED, EXTERIOR MOUNTED, WEATHERPROOF "F" INDICATES RED INDICATING BEACON, EXTERIOR MOUNTED, WEATHERPROOF "R" INDICATES REMOTE AREA LED INDICATOR

	SYSTEM OUTPUTS			CONTROL UNIT ANNUNCIATION						NOTIFICATION							REQUIRE LIFE SAFETY CONTROL				
	FIRE ALARM SYSTEM OPERATION SCHEDULE	ACTUATE COMMON ALARM SIGNAL INDICATOR	ACTUATE AUDIBLE ALARM SIGNAL	ACTUATE COMMON SUPERVISORY SIGNAL INDICATOR	ACTUATE AUDIBLE SUPERVISORY SIGNAL	ACTUATE COMMON TROUBLE SIGNAL INDICATOR	ACTUATE AUDIBLE COMMON TROUBLE SIGNAL	ACTUATE FIRE FLOOR ALARM INDICATOR	ACTUATE EVACUATION SIGNALS ON ALL FLOORS	ACTUATE LOCAL AUDIBLE TEMP-3 PATTERN FIRE SIGNAL	ACTUATE LOCAL ADA VISUAL ALARM	DISPLAY/PRINT CHANGE OF STATUS	TRANSMIT FIRE ALARM SIGNAL TO SUPERVISING STATION	TRANSMIT SUPERVISORY SIGNAL TO SUPERVISING STATION	TRANSMIT TROUBLE SIGNAL TO SUPERVISORY STATION	RELEASE MAGNETICALLY HELD SMOKE DOORS	CLOSE FIRE/SMOKE DAMPER ON ASSOCIATED FIRE FLOOR	SHUT DOWN ALL ASSOCIATED HVAC EQUIPMENT	OVERRIDE MUSIC SYSTEM (MUTE)	OVERRIDE TELEVISION SYSTEM (TURN OFF)	OVERRIDE DIMMING SYSTEM (LIGHTS TO FULL BRIGHT)
	SYSTEM INPUTS	А	В	С	D	Е	F	G	Н	I	J	K	L	М	N	0	Р	Q	R	S	Т
1	MANUAL FIRE ALARM BOXES	•	•					•	•	•	•	•	•			•			•	•	•
2	SMOKE DETECTORS	•	•					•	•	•	•	•	•			•	•		•	•	•
3	HEAT DETECTORS	•	•					•	•	•	•	•	•			•			•	•	•
4	WATERFLOW	•	•					•	•	•	•	•	•			•			•	•	•
5	SPRINKLER CONTROL VALVE			•	•							•		•							
6	DUCT SMOKE DETECTORS			•	•							•		•				•			
7	FIRE ALARM AC POWER FAILURE					•	•					•			•						
8	FIRE ALARM SYSTEM LOW BATTERY					•	•					•			•						
9	OPEN CIRCUIT					•	•					•			•						
10	GROUND FAULT					•	•					•			•						
11	NOTIFICATION APPLIANCE SHORT CIRCUIT					•	•					•			•						
12	SUPERVISORY			•	•							•		•							
13	TROUBLE					•									•						

1. ALL EVENTS SHALL BE RECORDED AT THE FIRE ALARM CONTROL PANEL AND SHALL INDICATE TIME AND DATE OF OCCURRENCE AND LIST DEVICE INITIATED.

2. TROUBLE AND SUPERVISORY SIGNALS SHALL BE MONITORED IN ACCORDANCE WITH 780CMR 903.4.1.

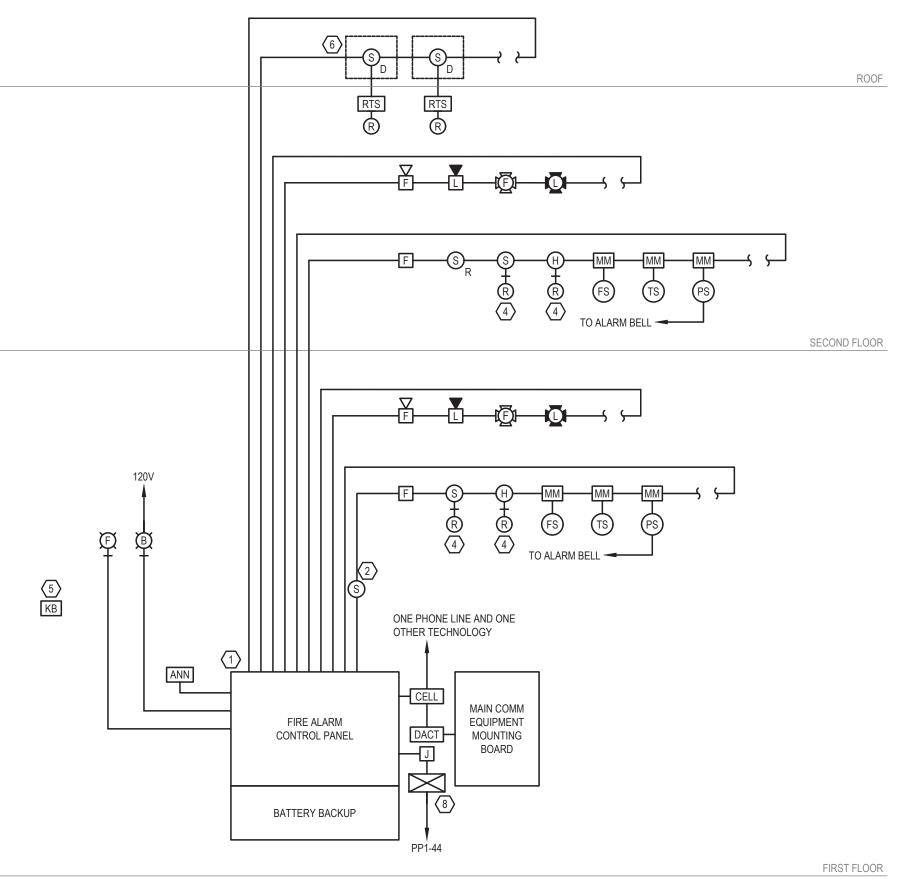


FIRE ALARM RISER DIAGRAM (3)

\(\psi \) \(\frac{\pmathrm{FIRE ALARM RISER DIAGRAM NOTES:}{} \)

- 1. ELECTRICAL CONTRACTOR SHALL PROVIDE CIRCUIT BREAKER HANDLE-LOCK ON ALL 120 VOLT FIRE ALARM POWER CIRCUITS. HANDLE LOCK SHALL ALLOW THE CIRCUIT BREAKER TO TRIP, BUT PREVENT SWITCHING OF THE CIRCUIT BREAKER TO THE "OFF"
- 2. PROVIDE SMOKE DETECTOR IN VICINITY (WITHIN 2'-0") OF FIRE ALARM CONTROL PANEL, AND ALL FIRE ALARM BOOSTER PANELS AND COMMUNICATORS. SMOKE DETECTORS IN ELEVATOR LOBBY SHALL BE PROGRAMMED AND/OR PROVIDED WITH ELEVATOR
- 3. RISER DIAGRAM DOES NOT SHOW ENTIRE SYSTEM. REFER TO FLOOR PLANS FOR EXACT QUANTITIES AND LOCATIONS OF ALL
- 4. PROVIDE REMOTE ALARM INDICATOR OVER DOOR OF EACH LOCKED ROOM THAT CONTAINS A SMOKE OR HEAT DETECTOR WHETHER OR NOT SHOWN ON THE FLOOR PLANS: SUCH AS, ELEVATOR MACHINE ROOMS, ELECTRIC ROOMS, MECHANICAL ROOMS, IT ROOMS, ETC.
- 5. PROVIDE SURFACE KEY BOX. ELECTRICAL CONTRACTOR SHALL PURCHASE THROUGH LOCAL FIRE DEPARTMENT.
- 6. TO AUXILIARY CONTACTS IN RESPECTIVE AIR-HANDLING UNIT STARTER FOR UNIT SHUTDOWN ON ALARM. DUCT SMOKE DETECTOR SHALL BE PROVIDED AND WIRED BY ELECTRICAL CONTRACTOR, INSTALLED BY MECHANICAL CONTRACTOR. DUCT SMOKE DETECTORS SHALL BE INSTALLED AS IN ACCORDANCE WITH INTERNATIONAL MECHANICAL CODE: SMOKE DETECTORS SHALL BE INSTALLED IN RETURN AIR SYSTEMS WITH A DESIGN CAPACITY GREATER THAN 2,000 CFM, IN
 - THE RETURN AIR DUCT OR PLENUM UPSTREAM OF ANY FILTERS, EXHAUST AIR CONNECTIONS, OUTDOOR AIR CONNECTIONS, OR DECONTAMINATION EQUIPMENT AND APPLIANCES. WHERE RETURN AIR RISERS SERVE TWO OR MORE STORIES AND SERVE ANY PORTION OF A RETURN AIR SYSTEM HAVING A DESIGN CAPACITY GREATER THAN 15,000 CFM, SMOKE DETECTORS SHALL BE INSTALLED AT EACH STORY. SUCH SMOKE DETECTORS SHALL BE LOCATED UPSTREAM OF THE CONNECTION BETWEEN THE RETURN AIR RISER AND ANY AIR DUCTS
 - SMOKE DETECTORS SHALL BE INSTALLED IN THE SUPPLY AIR SYSTEM FOR ALL MAKE-UP AIR UNITS WITH A DESIGN CAPACITY GREATER THAN 2,000 CFM AS IN ACCORDANCE WITH NFPA 90A.
- 7. DUCT SMOKE DETECTORS SHALL BE PROVIDED DOWNSTREAM OF THE STAIR PRESSURIZATION FANS PRIOR TO THE FIRST INJECTION POINT IN ACCORDANCE WITH NFPA 72, SECTION 6.4.6.2.1.
- 8. PROVIDE A 20AMP, 120VOLT, 1 PHASE SURGE PROTECTOR EQUAL TO MCG SURGE PROTECTION MODEL NO. 415. SURGE PROTECTOR SHALL BE INSTALLED BETWEEN THE CIRCUIT BREAKER IN THE PANEL AND THE FIRE ALARM PANEL, AND IN ACCORDANCE WITH MANUFACTURER'S WIRING RECOMMENDATIONS.


9. IT SHALL BE THE RESPONSIBILITY OF THE CONTRACTOR TO PROVIDE ALL REQUIRED POWER SUPPLIES FOR A COMPLETE AND

OPERABLE SYSTEM. POWER SUPPLY CALCULATIONS SHALL BE INCLUDED IN FIRE ALARM SHOP DRAWINGS.

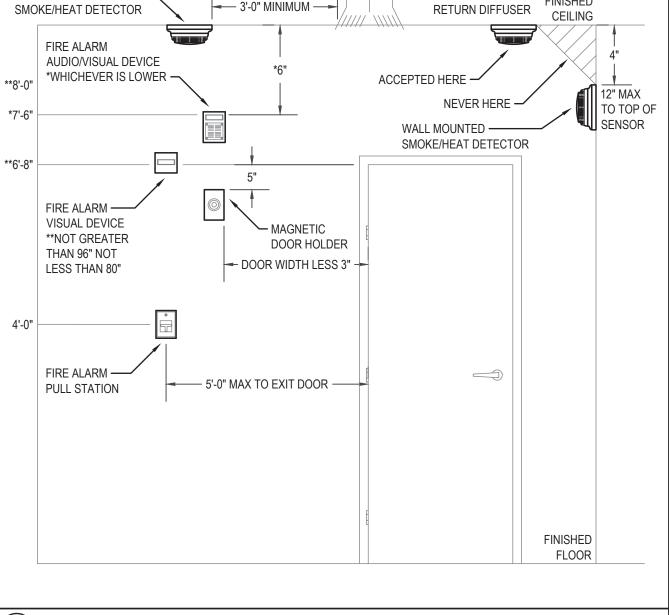


→ A/C SUPPLY OR

CEILING MOUNTED -

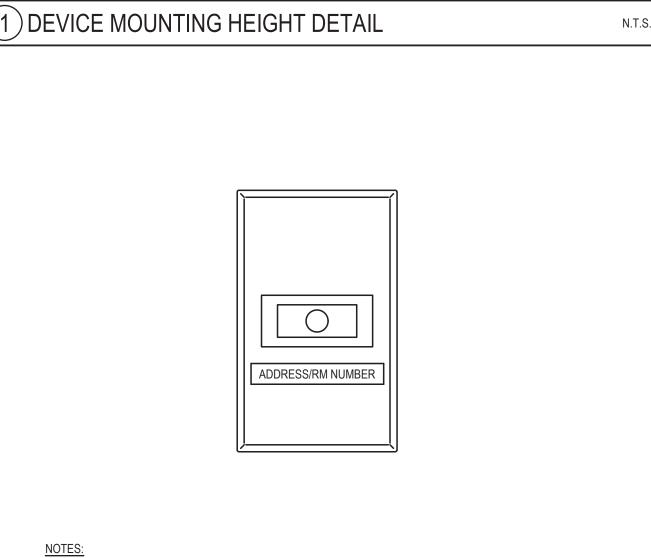


1. AT A MINIMUM, ELECTRICAL CONTRACTOR SHALL PROVIDE TYPED LABELS WITH PTOUCH MACHINE TO INDICATE ADDRESS OF FIRE ALARM DEVICE WITHIN ENCLOSED ROOM OR ROOM NUMBER IF SYSTEMS IS ZONED. LABELING SYSTEM SHALL BE APPLIED BUT NOT LIMITED TO THE FOLLOWING DEVICES: AUDIBLE/VISUAL DEVICE, VISUAL DEVICE, SMOKE DETECTOR, REMOTE TEST STATION, REMOTE ALARM INDICATOR, FLOW SWITCH, TAMPER SWITCH, ETC.

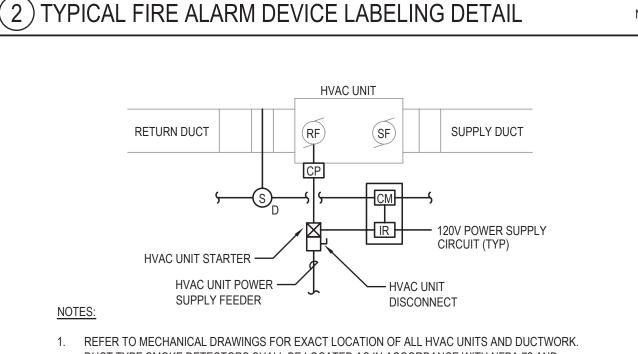


- DUCT TYPE SMOKE DETECTORS SHALL BE LOCATED AS IN ACCORDANCE WITH NFPA 72 AND COORDINATED WITH MECHANICAL CONTRACTOR.
- 2. TO AUXILIARY CONTACTS IN RESPECTIVE AIR-HANDLING UNIT STARTER FOR UNIT SHUTDOWN ON ALARM. DUCT SMOKE DETECTOR SHALL BE PROVIDED AND WIRED BY ELECTRICAL CONTRACTOR, INSTALLED BY MECHANICAL CONTRACTOR. DUCT SMOKE DETECTORS SHALL BE INSTALLED AS IN ACCORDANCE WITH INTERNATIONAL MECHANICAL CODE:
- SMOKE DETECTORS SHALL BE INSTALLED IN RETURN AIR SYSTEMS WITH A DESIGN CAPACITY GREATER THAN 2,000 CFM, IN THE RETURN AIR DUCT OR PLENUM UPSTREAM OF ANY FILTERS, EXHAUST AIR CONNECTIONS, OUTDOOR AIR CONNECTIONS, OR DECONTAMINATION
- EQUIPMENT AND APPLIANCES. WHERE RETURN AIR RISERS SERVE TWO OR MORE STORIES AND SERVE ANY PORTION OF A RETURN AIR SYSTEM HAVING A DESIGN CAPACITY GREATER THAN 15,000 CFM, SMOKE DETECTORS SHALL BE INSTALLED AT EACH STORY. SUCH SMOKE DETECTORS SHALL BE LOCATED UPSTREAM OF THE CONNECTION BETWEEN THE RETURN AIR RISER AND ANY AIR DUCTS OR PLENUMS.
- SMOKE DETECTORS SHALL BE INSTALLED IN THE SUPPLY AIR SYSTEM FOR ALL MAKE-UP AIR UNITS WITH A DESIGN CAPACITY GREATER THAN 2,000 CFM AS IN ACCORDANCE WITH NFPA 90A.

(3) TYPICAL DUCT SMOKE DETECTOR MOUNTING DETAIL

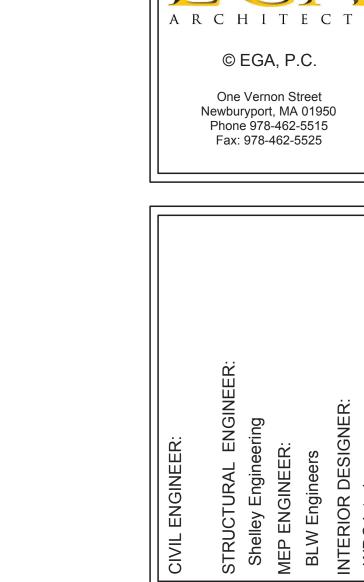

Issued For:	Date:


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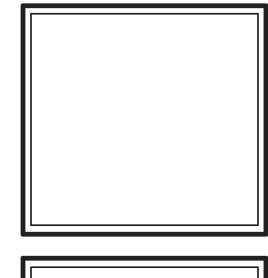


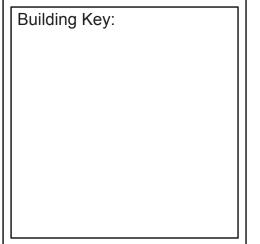LEGEND, RISER AND NOTES

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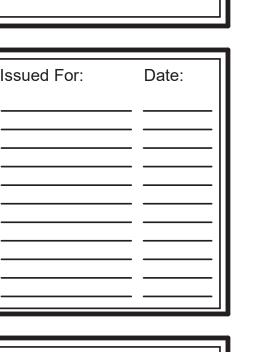





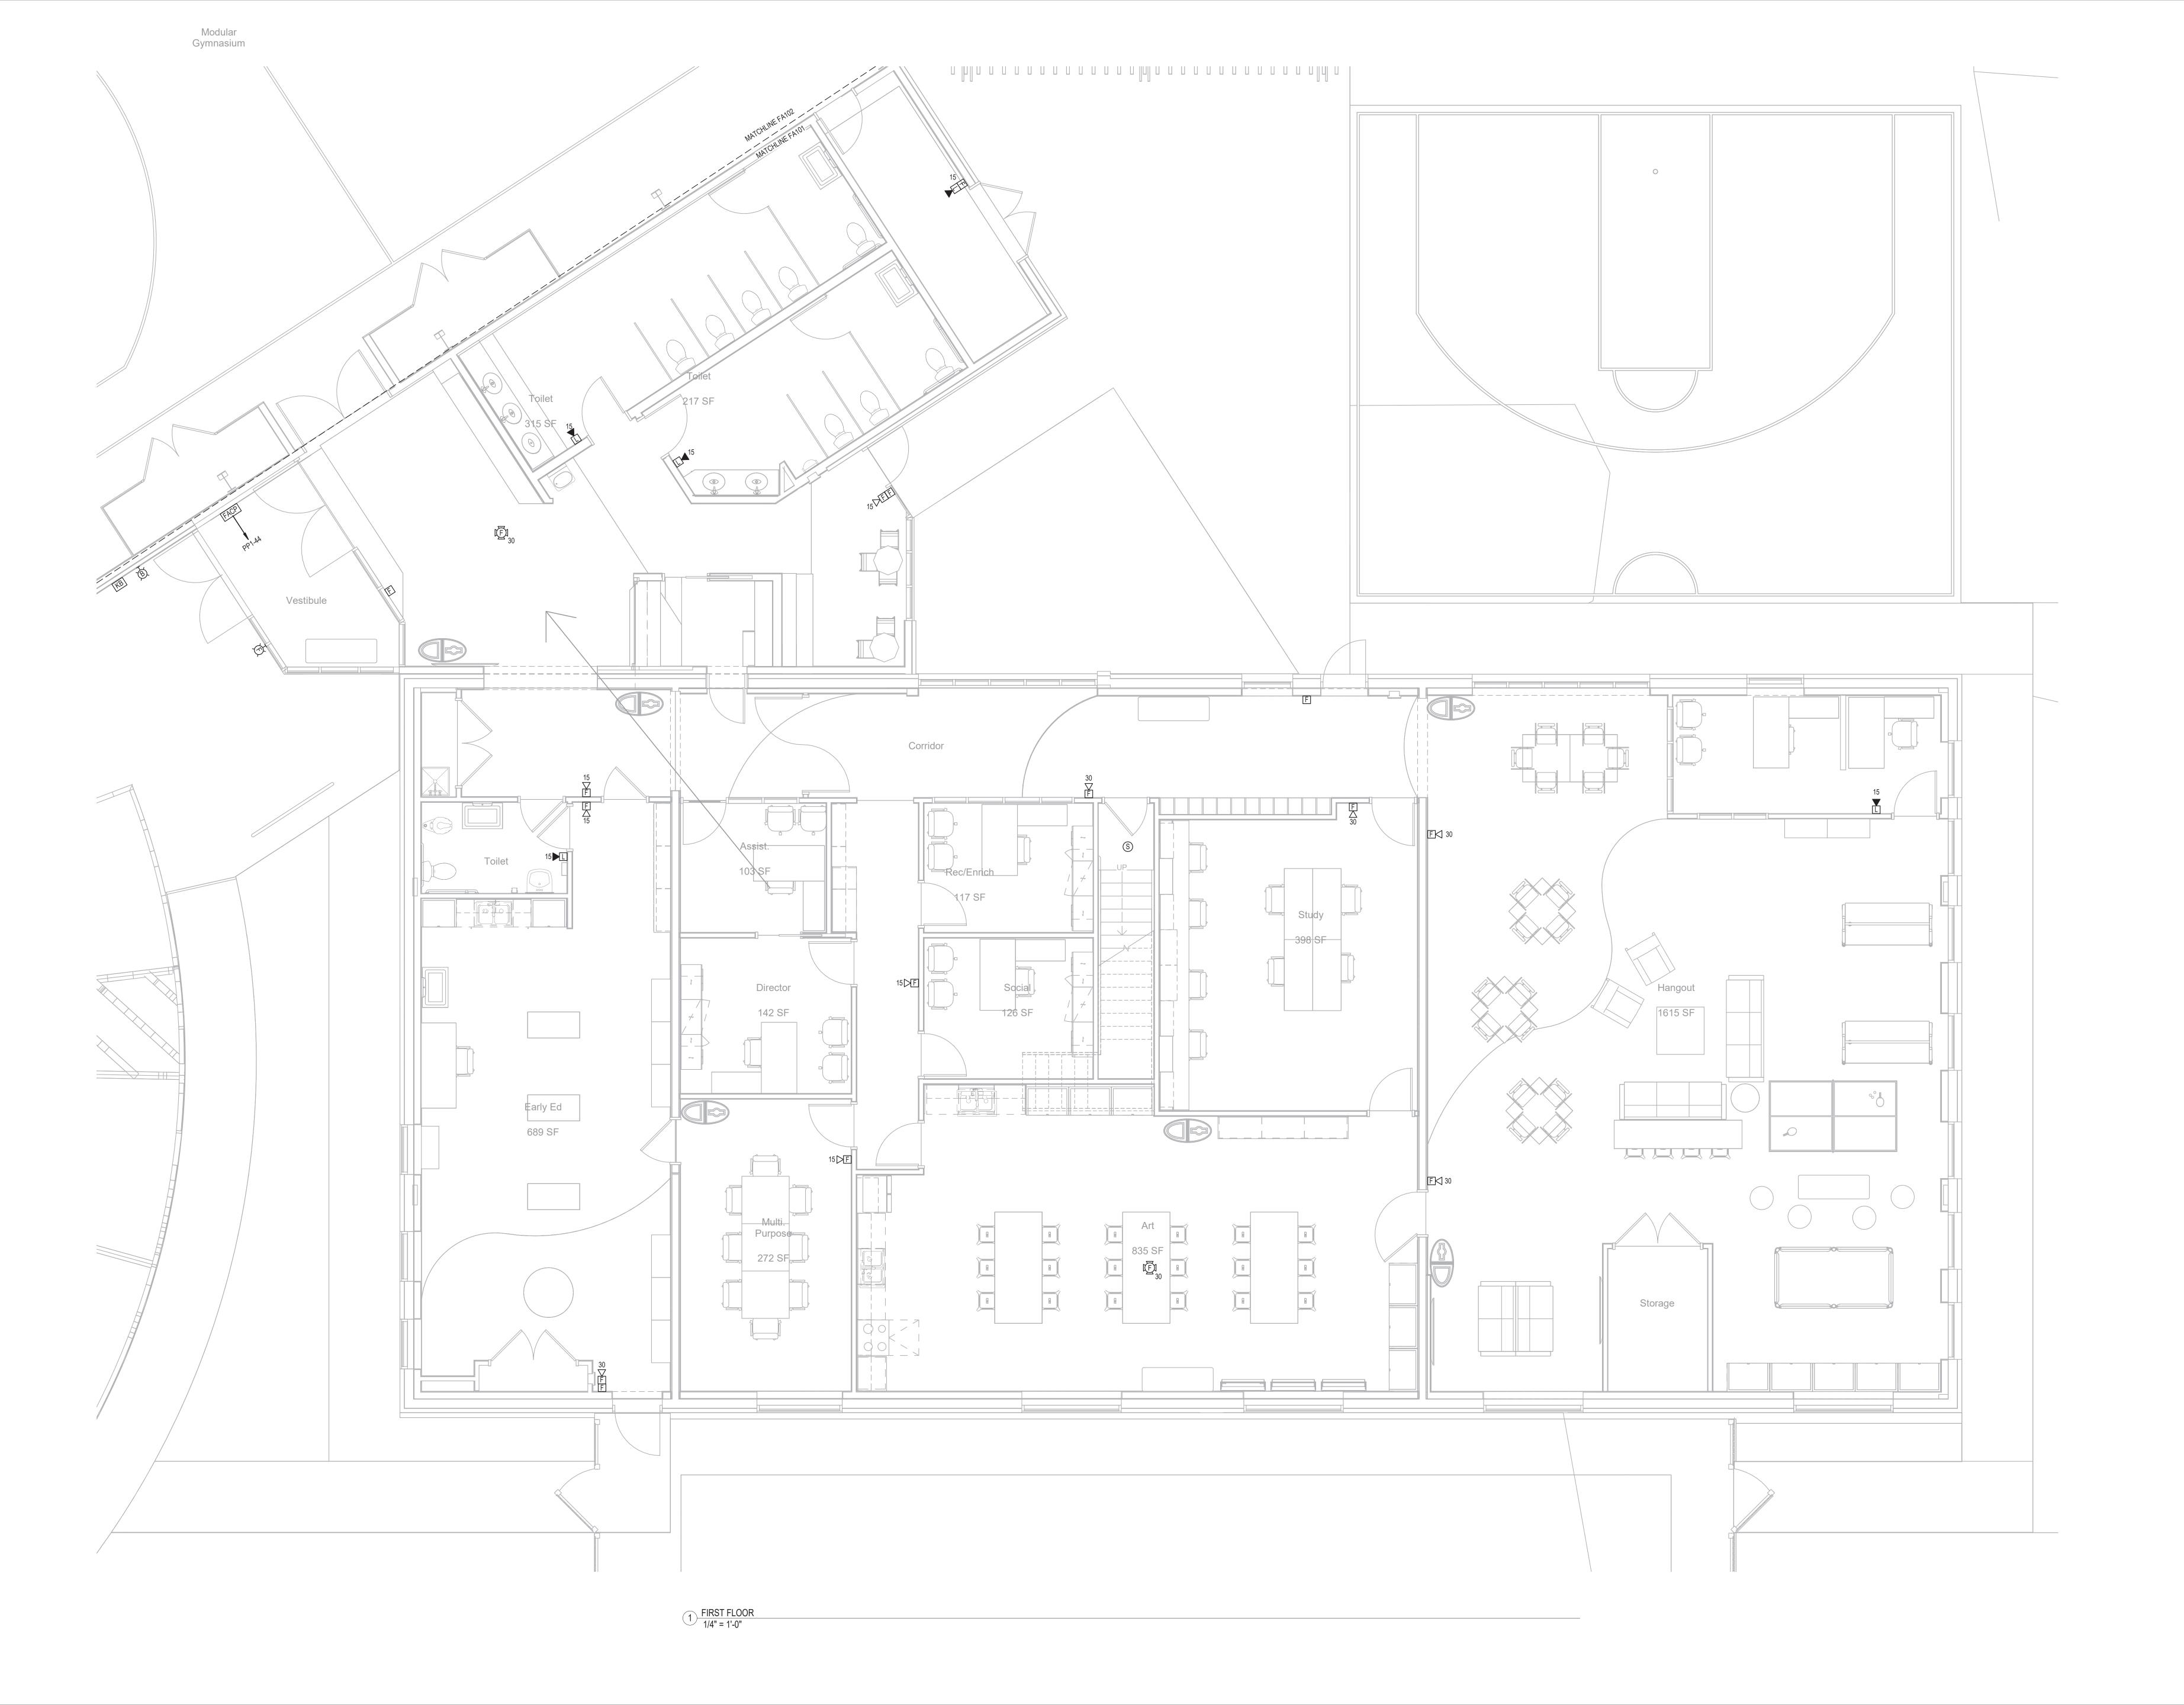


CTURAL ENGINEER:
celley Engineering
P ENGINEER:
W Engineers
ERIOR DESIGNER:
DC Interiors

Newburyport Youth Services
59 Low Street
Newburyport, MA 01950




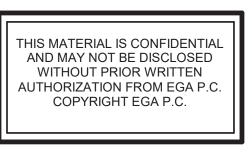


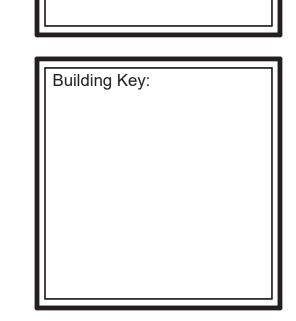

Sheet Title:
FIRST FLOOR
PLAN

Sheet Number:
FA-101

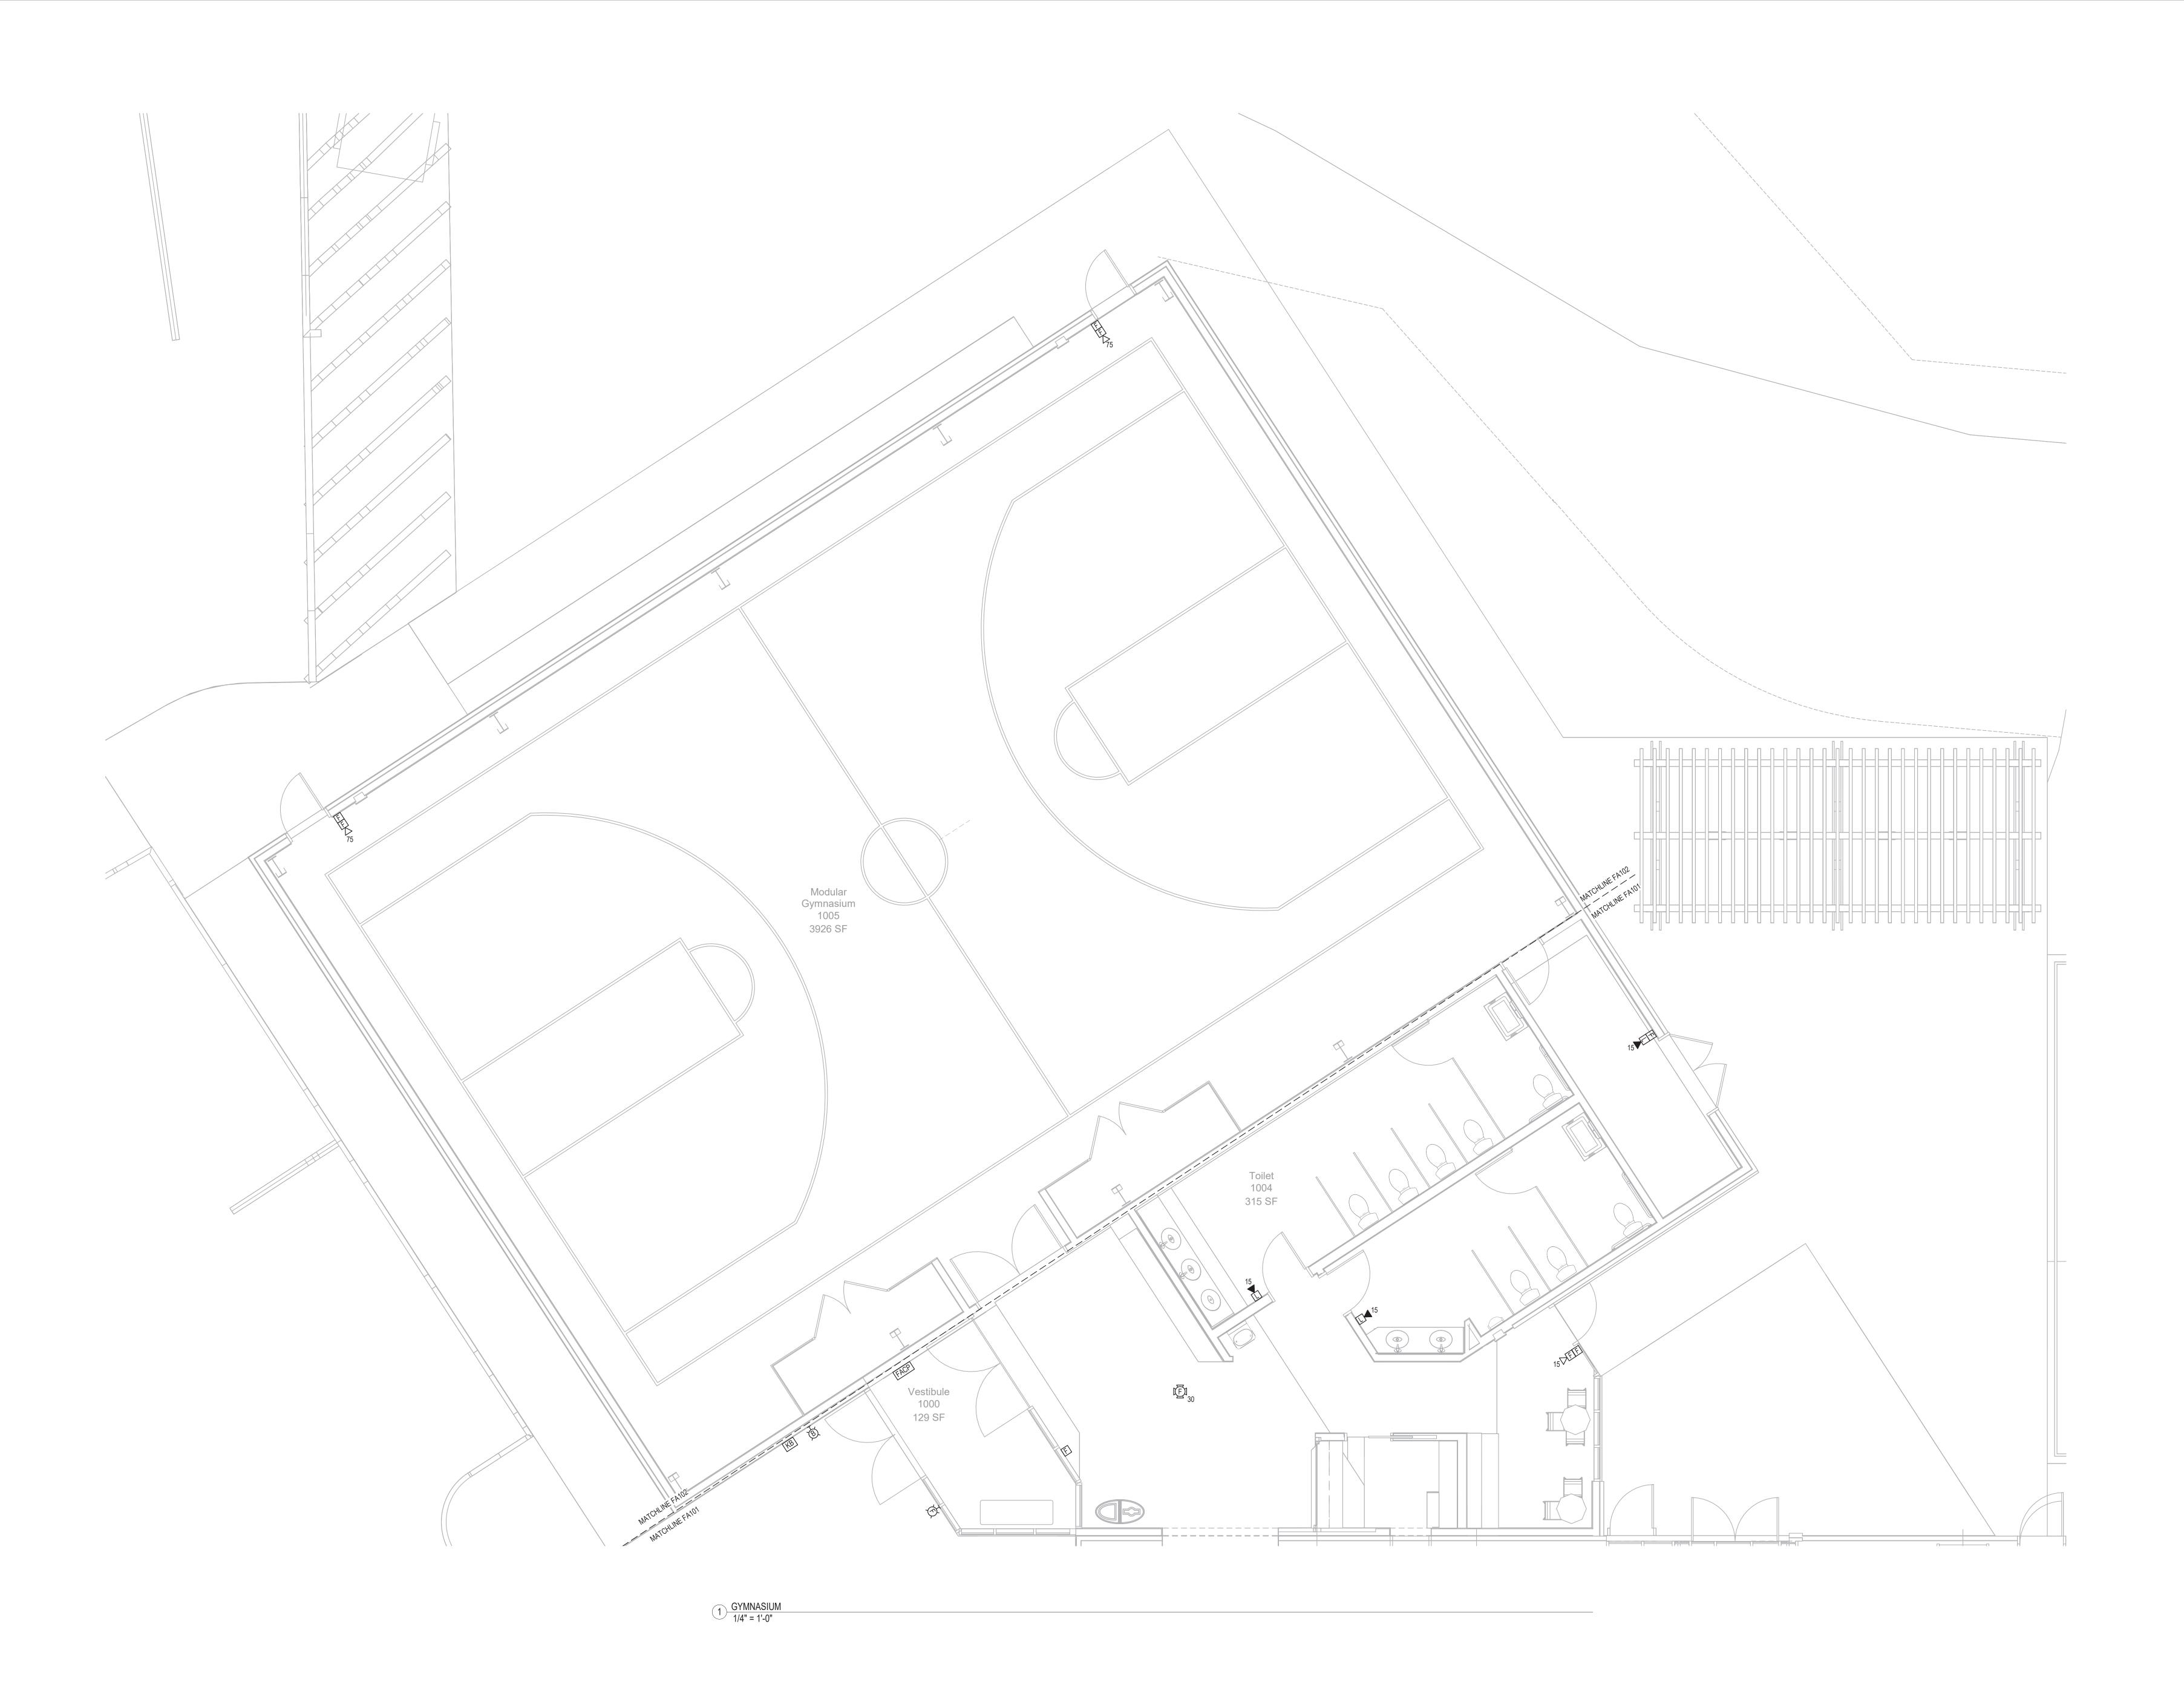


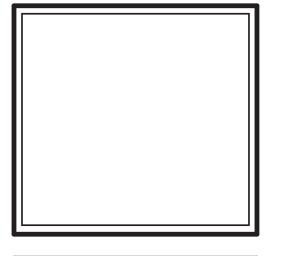






STRUCTURAL ENGINEER:
Shelley Engineering
MEP ENGINEER:
BLW Engineers
INTERIOR DESIGNER:
WDC Interiors


Newburyport Youth Service 59 Low Street
Newburyport, MA 01950

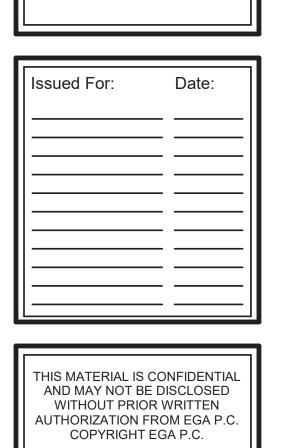

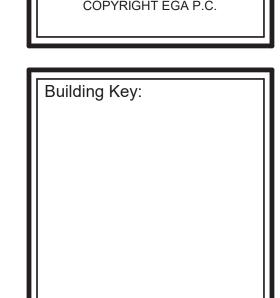

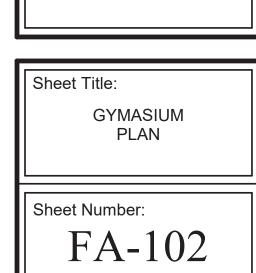


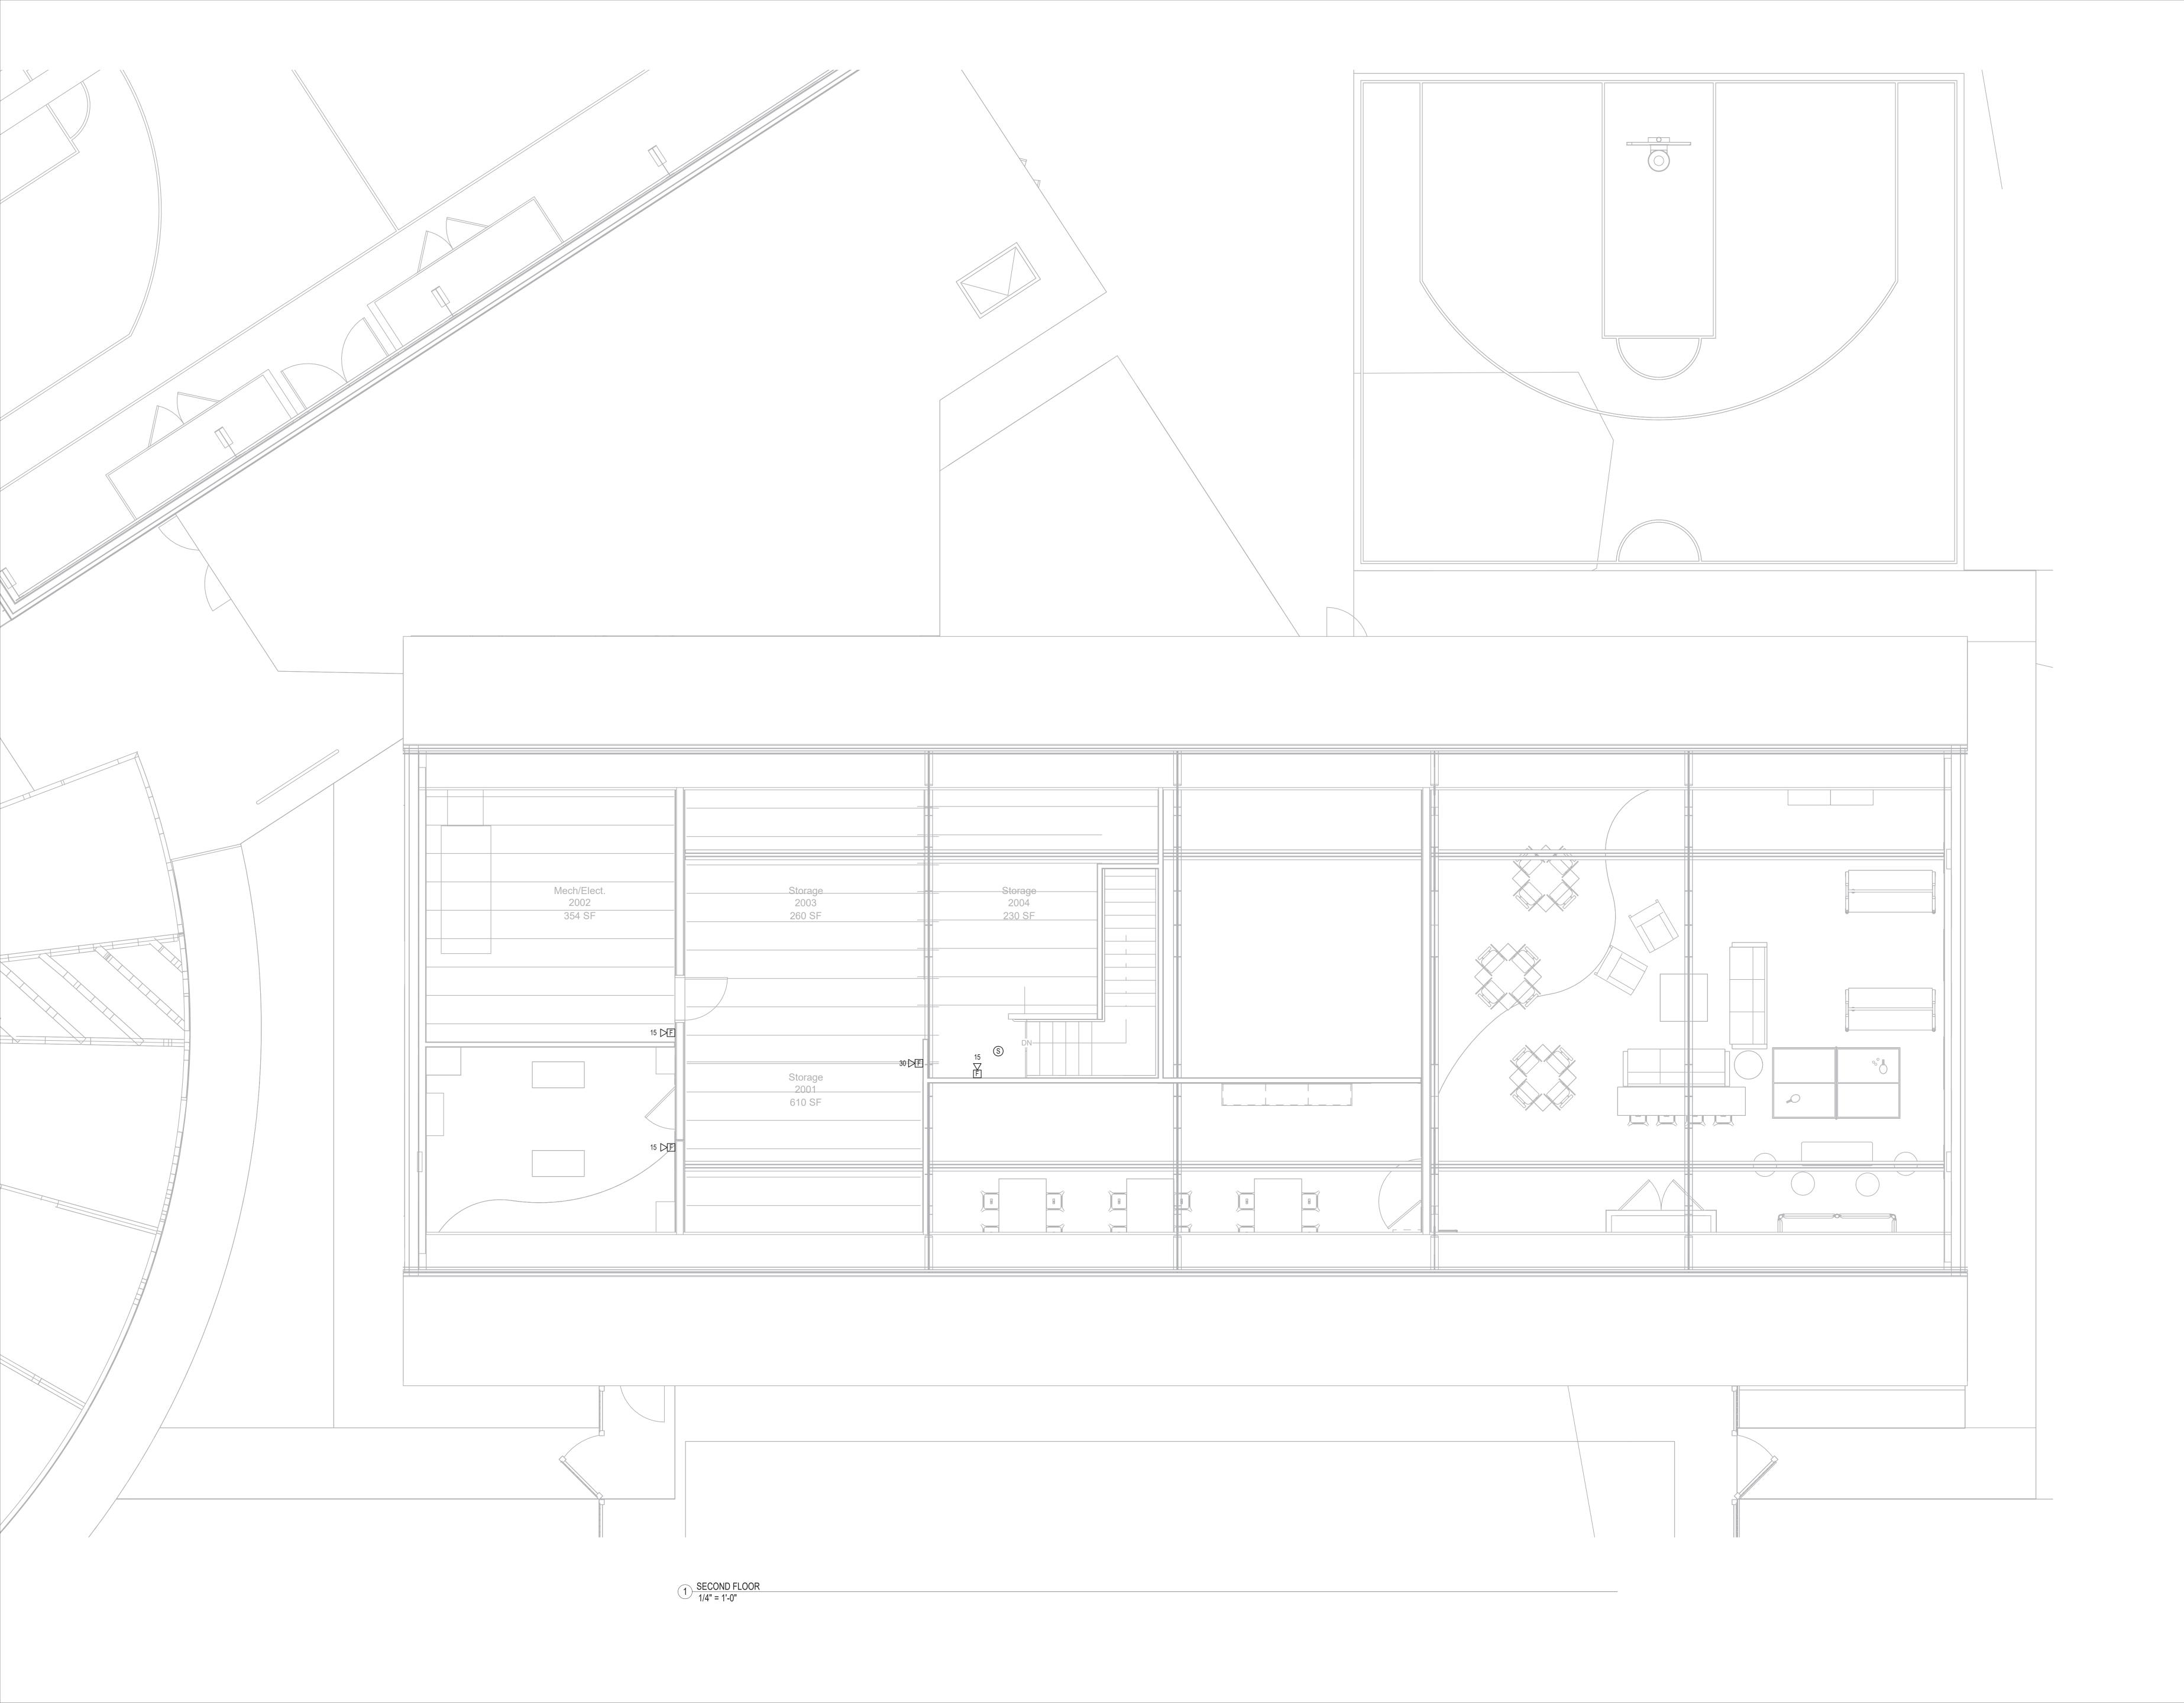


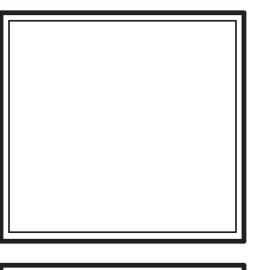





59 Low S Newburyport,

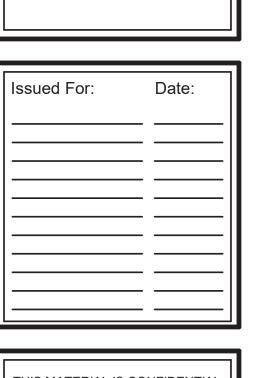

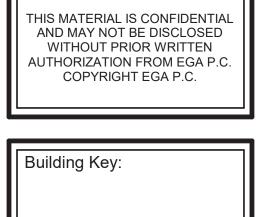

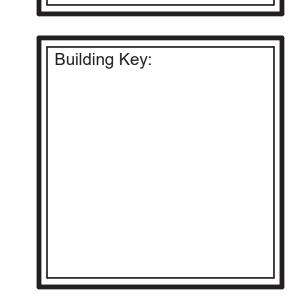

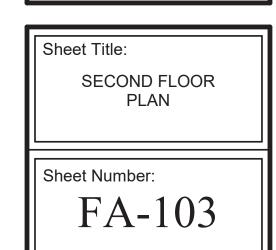

SPECIFICATIONS

FOR

NEWBURYPORT YOUTH SERVICES 59 LOW STREET NEWBURYPORT, MA

DD Pricing Set

September 07, 2023



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DIVISION 0 - GENERAL CONDITIONS

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SECTION 00 0120 - PROJECT DIRECTORY

OWNER

City of Newburyport Contact: Kim D Turner 60 Pleasant Street Tel: 978-465-4413

Newburyport, MA 01950 Email: kturner@cityofnewburyport.com

ARCHITECT

EGA Architects, P.C. Contact: Scott Hall, RA
One Vernon Street Pat Mixdorf, RA

Newburyport, MA 01950 Tel: 978-462-5515 Email: shall@ega.net

pmixdorf@ega.net

CONTRACTOR

Contact: Tel: Email:

MECHANICAL, ELECTRICAL & PLUMBING ENGINEER

Contact: Tel: Email:

DIVISION 1

SECTION 01 1000- SUMMARY

Scope: Newburyport Youth Services – 59 Low Street, Newburyport, MA 01950

There will also be a new entrance at the main entrance of the building.

The building will be designed and built to the MA Building Codes as well as ADA and MA HC

Codes.

SECTION 01 2300 – ALTERNATES

Scope: Refer to drawings for Option A, B, C & D wall types. Provide pricing for each type of walls

shown.

SECTION 01 2500 - CONTRACT MODIFICATION PROCEDURES

Scope: Standard language for clarification, proposals for change and changes to the contract.

SECTION 01 2900 - PAYMENT PROCEDURES

Scope: Standard procedures for submitting schedule of values and application for payment.

SECTION 01 3100 - PROJECT MANAGEMENT AND COORDINATION

Scope: Project coordination, coordination drawings.

SECTION 01 3200 - PROGRESS DOCUMENTATION

Scope: Construction log, permits, project record documents and construction photographs.

SECTION 01 3250 - PROGRESS SCHEDULES AND REPORTS

Scope: Progress schedule, project sequencing drawings.

SECTION 01 3300 - SUBMITTAL PROCEDURES

Scope: Standard procedures for progress and closeout submittals.

SECTION 01 4000 - QUALITY REQUIREMENTS

Scope: Comply with all applicable codes, regulations, laws, rules, ordinances and similar governmental

restrictions.

SECTION 01 4200 - REFERENCES

Scope: Standard list of reference standards, abbreviations and acronyms.

SECTION 01 4300 - QUALITY ASSURANCE PROCEDURES

Scope: Standard requirements for general quality control, workmanship, mockups and manufacturer's field

services.

SECTION 01 4500 - TESTING AND INSPECTION SERVICES

Scope: Standard requirements for testing and inspection. Refer to Section 01210 – Allowances.

SECTION 01 5000 - TEMPORARY FACILITIES AND CONTROLS

Scope: Standard requirements for utilities, sanitary facilities, security, barriers, enclosures, etc. used on site

during construction.

SECTION 01 5210 - FIELD OFFICES AND SHEDS

Scope: Standard requirements for double wide trailer with conference room, phone service, etc.

SECTION 01 5690 - TREE AND PLANT PROTECTION

Scope: Standard requirements for preservation of trees, plants, wetlands, etc.

SECTION 01 5710 - SNOW REMOVAL

Scope: Standard requirements for site snow removal.

SECTION 01 5800 - PROJECT SIGNS

Scope: Provide one 32sf sign at entrance.

SECTION 01 6000 - PRODUCT REQUIREMENTS

Scope: Standard requirements for products used in construction and products list.

SECTION 01 6300 - PRODUCT SUBSTITUTION PROCEDURES

Scope: Standard requirements and procedures for product substitution.

SECTION 01 6310 - SUBSTITUTION REQUEST FORM

Scope: Standard form included to facilitate Substitution Request.

SECTION 01 6600 - PRODUCT STORAGE, HANDLING AND PROTECTION

Scope: Standard requirements for storing and handling products on site.

SECTION 01 7000 - EXAMINATION

Scope: Standard requirements for determining acceptable conditions for installation.

SECTION 01 7250 - FIELD ENGINEERING

Scope: Standard requirements for survey and buyout procedures.

SECTION 01 7329 - CUTTING AND PATCHING

Scope: Standard requirements.

SECTION 01 7400 - CLEANING

Scope: Standard requirements for site, progress and final cleaning.

SECTION 01 7700 - CLOSEOUT PROCEDURES

Scope: Standard requirements for procedures for substantial completion.

SECTION 01 7880 - WARRANTIES AND BONDS

Scope: Standard requirements.

SECTION 01 7890 - SPARE PARTS AND EXTRA MATERIALS

Scope: Standard requirements.

SECTION 01 8100 - COMMISSIONING PROCEDURES

Scope: Standard requirements for start-up and adjustment of equipment.

DIVISION 2 – LANDSCAPING

SECTION 02 8110 - UNDERGROUND SPRINKLER SYSTEM

Scope: Design and Installation of underground sprinkler system including:

- A. Pipe and fittings.
- B. Sprinkler heads.
- C. Control system and connection to electrical supply.
- D. Trenching, installation of system and connection to water source, testing and backfilling.
- E. Design and construction of irrigation pump station including below grade pump pit structure and cover and manifold system.

SECTION 02 9300 - LAWNS

Scope: Provide all aspects of the following:

- A. Topsoil including screening stripped and stockpiled existing soil on site and spreading.
- B. Provide any new tops soil required.
- C. Provide and maintain adequate surface and subsurface drainage of topsoils and subsoils.
- D. All soil amendments, fertilizers and mulches.
- E. Rough grading.
- F. Fine grading.
- G. Seeding and sodding.
- H. Maintenance and guarantee.

Products: Stripped topsoil must be screened to a maximum stone size of 3/4".

Soil Amendments:

- A. Sand, Lime, Fertilizer, Superphosphate, Water, Herbicides, Bone Meal Manure Peat Pesticides and Fungicides.
- B. Hydroseeding.
- C. Lawn Maintenance: water, weed, mow and edge.
- D. Clean up: Leave no debris. Remove any excavated material. Repair any damage.

SECTION 02 9500 - PLANTING

Scope:

All landscaping and related work including planting of trees, shrubs, groundcovers, vines and perennials.

Maintenance and guarantee. Refer to Section 01210 – Allowances for allowance amount applied to work of this Section.

DIVISION 3 – CONCRETE

SECTION 03 3000 - CAST-IN-PLACE CONCRETE

Scope:

Provide structural concrete footings, foundations, slabs, decks, equipment bases, and housekeeping pads. See Structural drawings for additional specifications.

A. Cast-in-Place Concrete

- Quality, placing, consolidation, curing and protection Conform to ACI 301, ACI
 318
- 2. Ready-Mixed manufacture and delivery ASTM C94.
- 3. 28 day compressive strength (ASTM C94):
 - a. Unless otherwise specified, 3000 psi for foundations, footings and interior slabs.
 - b. 4000psi at garage slabs, sidewalks, patios.
- 4. Air entrainment: Concrete exposed to freeze/thaw during construction will be air entrained at 6% plus or minus 1% (not used at troweled floors). Air-Entraining Admixture: ASTM C 260
- 5. Slump: slabs: 3"-5".
- 6. Fine and coarse aggregates: ASTM C33 3/4" max.
- 7. Max. Water-cement ratio.
 - a. Non-air entrained: 0.58 for 3000 psi concrete.
 - b. Air entrained: 0.46 for 3000 psi concrete.
- 8. See structural drawings for reinforcing requirements and slab thickness. 9. Provide heavy duty sealer at slabs in the health care portion of building.

B. Forms

1. Smooth formed plywood or metal - oiled and sealed.

C. Accessories

- 1. Vapor barrier: 5 ply nylon or poly cord reinforced poly sheet. 10 mil.
- 2. Floor and Slab Treatments Penetrating Liquid Floor Treatment (for all slabs)
- 3. Reference Soils Report for water stop requirements in concrete work.
 - a. For this pricing, assume a bentonite water stop at the perimeter of the basement slab, installed below the slab at the intersection with the foundation wall or top of footing.
 - (1) Volclay waterstop RX-101RH 1" x ³/₄"
 - (2) Volclay WB-adhesive to secure product in place.

- (3) Provide waterproofing and damproofing. See Div. 7
- 4. Curing and sealing compound: ASTM C 1315, type 1, Class A-"ChemMasters."
- 5. Joint fillers: Asphalt saturated cellulosic fiber ASTM D 1751.
- 6. Water stops bulb type or bentonite.
- 7. Fibermesh reinforcing for slabs on grade only.
- D. Provide cold weather protection when temperatures fall below 32 F. Concrete shall not be placed in water or on frozen ground.
- E. Finishes
 - 1. Sidewalks and patios: trowel + light broom.
 - 2. Interior Slabs: float + steel trowel.
 - 3. Garages: trowel & light broom.

SECTION 03 5413 - GYUPSUM CEMENT UNERLAYMENT

Scope: Provide 1" of gypsum cement at entire existing building.

Product: Maxxon Gyp-Crete 2500 or equal.

DIVISION 4

SECTION 04 7200 - MASONRY

Scope: Provide reworking of CMU and brick where indicated on elevations as shown on Drawings.

Products: Basis-of-Design – Reuse – or Match Existing Blend CMU and brick at front entrance.

Option A Wall will have openings to be infilled with CMU and brick.

DIVISION 5

SECTION 05 5000 - METAL FABRICATIONS

Scope: Provide lavatory counter supports, masonry lintels, concrete filled pipe bollards and miscellaneous

supports bracing clips, seismic clips, steel ledger angles as needed and/or as indicated on the

drawings.

Products: Provide work fabricated from standard steel shapes. For work exposed to view, provide AISC

Architecturally Exposed Steel with all seams and joints fully welded and dressed smooth, to be invisible after priming. Hot dip galvanize all exterior ferrous metals; prime paint all interior work.

DIVISION 6

SECTION 06 1000 - ROUGH CARPENTRY

Scope: Provide wood stud walls, rough carpentry blockings, curbs, cants, edgings, grounds, nailers,

furring, strapping, sheathing, underlayments, etc., required for all trades, including bath

accessories, drapery rods, mirrors, cabinets, etc.

Provide wood stair 44" wide, stringers, treads, risers to mezzanine. Provide handles for each side.

SECTION 06 1000 - SHEATHING

Scope: Provide continuous wall insulation under Division 7 on exterior walls. (See wall types for

location and layers)

Provide 5" vented nail base on roof (Hunter Panel).

Products:

SECTION 06 2023 - INTERIOR FINISH CARPENTRY

Scope: Provide standing and running trim where noted.

Products: Provide Premium Grade materials and workmanship for all work. Paint grade trim shall be super

cut poplar as manufactured by Brosco, Horner Millwork or equal. Wood to receive painted finish

or equal.

SECTION 06 4250 - FIBERGLASS REINFORCED PLASTIC PANELS

Scope: Provide fiberglass reinforced plastic (FRP) panels in the janitor's closet (wet wall 48" AFF)

Products:

- A. Acceptable manufacturers:
 - 1. Marlite, Dover, OH
 - 2. BP Chemicals, Inc. Florence, KY
 - 3. Kemlite Co., Joliet, IL
- B. Flame spread: Class A
- C. Sign: 4"x9'x3/32"
- D. Surface: High gloss, pebble surface, standard color.

DIVISION 7

SECTION 07 1300 - DAMPROOFING

Scope: Provide damproofing at all new frost walls.

SECTION 07 2100 - THERMAL INSULATION

Scope: Provide insulationat locations noted. Provide sound insulation as scheduled into walls of non-fire

rated assemblies. See Wall Options B, C and D.

Products:

A. At exterior walls, provide insulation where indicated.

- B. Flat roof areas add spray insulation to R Value indicated; coordinate installation with sprinkler piping in attic and spray insulation.
- C. Provide 3-1/2" thick unfaced, friction fit fiberglass sound attenuation batts in non-fire rated interior partition walls at offices, mechanical rooms and toilets.
- D. Provide fiberglass insulation in R Value indicated on wall type sheet.
- E. Provide 4" rigid under slabs of Addition and Gym. Provide 15mil vapor barrier.

SECTION 07 5323 - ROOFING

Scope: Provide a complete weather tight TPO roofing and insulation system over the "flat" roof deck areas.

Provide Plumbing/HVAC Boots as necessary for MEP penetrations.

Products: Provide fully adhered White TPO roofing system as manufactured by Carlisle Tire and Rubber or equal with 15-year manufacturer's guarantee on water tightness. Provide tapered polyisocyanurate insulation over "flat" roof areas. Color – white.

polyisocyanarate insulation over that 1001 areas. Color – winter

SECTION 07 7150 - GUTTERS AND DOWNSPOUTS

Scope: Provide gutters and downspouts at areas above entrances and exits to the building and at gymnasium.

Existing gutters at existing building to remain.

Products: Prefinished aluminum, .032 gauge 5" half round gutters with appropriate hangers, end pieces, etc.

Prefinished metal downspouts, 4" with expansion ridges. Provide all necessary components for

complete system.

SECTION 07 9200 - JOINT SEALANTS

Scope: Provide all sealants needed to create a completely watertight and weathertight building. Provide

sealants between all interior and exterior dissimilar materials, and in all expansion and control joints.

Products: Provide two-part non-sag polyurethane for typical exterior joints. Provide self-leveling two part

polyurethane in floor joints. Provide mildew resistant silicone sanitary sealant for plumbing fixtures and tile control joints in tile work. Provide acrylic latex for typical interior joints at door frames, windows and elsewhere as needed. Provide acoustical sealant at outlet boxes and top, bottom, and

edge joints in party wall assemblies.

DIVISION 8

SECTION 08 1113 - HOLLOW METAL DOORS AND FRAMES

Scope: Provide primed steel interior doors and frames and galvanized steel exterior doors and frames.

Provide fire-rated doors and frames in fire-rated assemblies. As manufactured by Jeld Wen,

Benchmark or approved equal.

Products:

- A. Interior Doors
 - 1. Primed; See Section 09 9100 Painting.
 - 2. Fire-rated; 1 3/4 inch ANSI A151.1,
 - a. 20 min at corridor doors.
 - b. 60 minute doors at stairs.
 - c. 90 minute horizontal exits between buildings.
 - 3. 24 ga. flat panel.
 - 4. Acoustically insulated; expanded polystyrene.
- B. Interior Frames
 - 1. Primed; see Section 09 9100 Painting.
 - 2. Fire-rated; 20 min and 1 1/2 hour.
 - a. 20 min at corridor doors.
 - b. 60 minute at stairs.
 - c. 90 minute horizontal exits between buildings
 - 3. 18 gauge; cold-rolled or hot-rolled.
 - 4. Knock-down frames
 - 5. Flat flange return; to receive wood casing.
 - 6. See wall schedule for size.
- C. Exterior Doors
 - 1. Galvanized: See Section 09 9100 Painting.
 - 2. Thermal insulation: Expanded polystyrene.
 - 3. Door thickness: 1³/₄"
 - a. 18 gauge: flat panel.
- D. Exterior Frames
 - 1. Galvanized; see Section 09 9100 Painting.

- 2. 16 gauge; cold-rolled or hot-rolled.
- 3. Knock down frames
- 4. Standard steel casing profile.
- 5. See wall schedule for size.

SECTION 08 1400 - SOLID WOOD DOORS

Scope: Interior doors shall be solid flush 1 3/4" maple doors prefinished in hollow metal frames (painted).

Product: Craftwood or equal.

SECTION 08 3113 - ACCESS DOORS AND FRAMES

Scope: Provide access doors as required for mechanical, electrical, and other access.

Products: Milcor, 24" x 24", B-45 label, with key lock.

24" x 30" Attic Access.

SECTION 08 4113 - ALUMINUM FRAMED ENTRANCES AND STOREFRONT

Scope: Provide aluminum framed entrances and storefronts as indicated on the drawings, new vestibule and

and new windows at existing building, addition and gymnasium.

Products: Based on Kawneer Trifab VersaGlaze 601 Ultra Thermal Framing System (or equal)

6" center glazed, anodized with color choice to be selected by Architect.

Includes framing and associated glazing.

Single swing doors to be same Kawneer system with door pulls. Provide auto operators on all doors. Provide overhead concealed operators HD-Swing S4800 as manufactured by Horton with push

button operators on both sides of doors.

SECTION 08 5400 - WINDOWS

Scope: See aluminum storefront system above.

SECTION 08 7100 - DOOR HARDWARE

- A. Products: Hardware Groups: (Basis of Design Commons: Satin Chrome)
 - 1. Common Areas: Schlage AL Series Grade 2 Interchangeable Core Large Format Neptune Lever Design.
 - 2. *Note: match finish in adjacent areas new areas to receive US26D. New common spaces isolated from existing hardware to be USD26D.

Qty.	Description	Manufacturer Model Number	Finish	Manuf.
SET#	<u> U1 – Apartment Entry</u>			
1	Pair of Spring Hinges	4 1/2 X 4 ½	*Note 2	Ives
1	5 Knuckle Hinges	4 1/2 X 4 1/2	*Note 2	Ives
1	Corridor	Classroom Lock Entry	*Note 2	Schlage
1	Protection Plate	8" x 1" less width of door CSK	*Note 2	Ives
1	Concave Wall Bumper	WS406CCV	*Note 2	Ives
1	Door Viewer (2 at HC units) 622-DCRM	*Note 2	Rockwood

1 3	Smoke Seal Door Silencers	5020CL (Head and Jambs) SR64	GREY	NGP Ives
1	Notes: 1. Prep lock and ba	ackset for 1-3/8" door or 1-3/4" door per door s	schedule	
	<u>U2 – Bathroom -Swinging</u>	4.77.4	********	-
3	Hinges	4 X 4	US26D	Ives
1	Privacy	TTTG 10 (G GT T	US26D	Schlage
1	Concave Wall Bumper	WS406CCV	US26D	Ives
SET#	U3 - Closet-Single			
3	Hinges	4 X 4	US26D	Ives
1	Passage Set		US26D	Schlage
1	Door Stop	70Z-619E	US26D	Ives
1		ackset for 1-3/8" door or 1-3/4" door per door s		
	•	-		
	<u>U4 - Closet-Pair</u>			-
6	Hinges	4 X 4	US26D	Ives
2	Dummy Trim	2250	US26D	Schlage
2	Roller Catch	335B	US26D	Schlage
1	Notes: 1. Prep lock and ba	ackset for 1-3/8" door or 1-3/4" door per door s	schedule	
SET#	U5 Apartment - Bedroom(s)			
3	Hinge	4 X 4	US26D	Ives
2	Corridor	Privacy Set (shared unit only)	US26D	Schlage
1	Concave Wall Bumper	WS406CCV	US26D	Ives
•	U6 Bifold Closet Door - DL			-
2	Bifold Bypass Door Hardware	Bifold Door Manufacturer	227B15 pulls	Ives
SET #	U7 Bifold Closet Door - SL			
1		Bifold Door Manufacturer	227B15 pull	Ives
1	Bifold Bypass Bool Hardware	Billora Boot Managacturer	227B13 puii	1705
SET #1 -	Interior Stairwell			
3	Hinges	4 1/2 X 4 1/2	*Note 2	Ives
1	Exit Device-Passage	98F Rim w/07 Lever	*Note 2	Von Duprin
1	Closer	4040XP EDA	*Note 2	LCN
1	Concave Wall Bumper	WS406CCV	*Note 2	Ives
1	Perimeter Seal	S88		Pemko
1	Door Bottom	315		Pemko
]		ackset for 1-3/8" door or 1-3/4" door per door s	schedule	
	2. Provide Mag lo	ck and keypad override at LG Stair.		
SET #	2 – DL Opposite Swing			
<u>5Ε1 π</u>	Standard Hinge	4 ½" x 4 ½"	*Note 2	Ives
1	Exit Device	9947EO-F-LBR KIT US26D LH 36"x84" Door	*Note 2	Von Duprin
1	Exit Device	9947EO-F-LBR KIT US26D RH 36"x84" Door	*Note 2	Von Duprin
1	Astragal	Pemko 29310CPK 84"	C	Pemko
2	Surface Closer	LCN 1461 Rw/PA AL 4040XP EDA	*Note 2	LCN
2	Kick Plate	Ives 8400 US32D 8x34	*Note 2	Ives
2	Wall Door Stop	Ives WS406/407CCV US32D	*Note 2	Ives
2		Rixson 989 24VAC 900-100 689	689	Rixson
2	Weatherstripping	Pemko 315CN36		Pemko
1	Weatherstripping	Pemko S88 D21	D	Pemko
	11 0			
	- Entry/Activity (Classroon		da r	_
3	Hinges	4 1/2 X 4 1/2	*Note 2	Ives

1 Classroom Lockset 1 Closer 1 Concave Wall Bumpe 3 Door Silencers	4040XP EDA r WS406CCV SR64 ad backset for 1-3/8" door or 1-3/4" doo	*Note 2 *Note 2 *Note 2 GREY	Schlage LCN Ives Ives
Notes. 1. Trep lock at	id backset for 1-5/6 door of 1-5/4 doo	n per door senedure	
SET #4 – Office w/Closer			
3 5 Knuckle Hinges	4 1/2 X 4 1/2	*Note 2	Ives
1 Office Lockset		*Note 2	Schlage
1 Closer	4040XP EDA	*Note 2	LCN
 Concave Wall Bumpe 	r WS406CCV	*Note 2	Ives
3 Door Silencers	SR64	*Note 2	Ives
Notes: 1. Prep lock an	nd backset for 1-3/8" door or 1-3/4" doo	or per door schedule	
SET #5 - Office			
3 5 Knuckle Hinges	4 1/2 X 4 1/2	*Note 2	Ives
 Office Lockset 		*Note 2	Schlage
 Concave Wall Bumpe 	r WS406CCV	*Note 2	Ives
3 Door Silencer	SR64	GREY	Ives
Notes: 1. Prep lock ar	nd backset for 1-3/8" door or 1-3/4" doo	or per door schedule	
-		_	
SET #6 – Passage with Closer			
3 5 Knuckle Hinges	4 1/2 X 4 1/2	*Note 2	Ives
1 Passage Set		*Note 2	Schlage
1 Protection Plate	8" x 1" less width of door CSK	*Note 2	Ives
1 Concave Wall Bumpe	r WS406CCV	*Note 2	Ives
3 Door Silencer	SR64	GREY	Ives
1 Closer	4040XPEDA	*Note 2	LCN

CET #	7 Paggaga			
3	<u>7 – Passage</u> 5 Knuckle Hinges	4 1/2 X 4 1/2	*Note 2	Ives
1	Passage Set	4 1/2 X 4 1/2	*Note 2	Schlage
1	Protection Plate	8" x 1" less width of door CSK	*Note 2	Ives
1	Concave Wall Bumper	WS406CCV	*Note 2	Ives
3	Door Silencer			
3	Door Stiencer	SR64	GREY	Ives
SFT #	8 - Passage – Office			
3	Hinges	4 1/2 X 4 1/2	*Note 2	Ives
1	Protection Plate	18" x 1" less width of door CSK	*Note 2	Ives
1	Closer	4040XP EDA	*Note 2	LCN
1	Concave Wall Bumper	WS406CCV	*Note 2	Ives
3	Door Silencer	SR64	GREY	Ives
1	Deadbolt Double cylinde		*Note 2	Schlage
		packset for 1-3/8" door or 1-3/4" door per door		Schlage
1	Notes. 1. Trep lock and t	ackset for 1-3/8 door of 1-3/4 door per door	schedule	
SET#	9 – Passage – Kitchen - NC	OT USED		
<u>DL111</u>	7 Tussage Tenenen Tve	VI OBED		
SET#	10 - Firewall - Pair			
6	Hinges	4 1/2 X 4 1/2 NRP	*Note 2	Ives
1	Dust Proof Strike	DP1	*Note 2	Ives
2	Mag Hold Openers			
2	Closer	4040XP EDA	*Note 2	LCN
2	Door Silencer	SR64	GREY	Ives
2	Exit Devices	98F W/07 Lever (positive latch)	01221	1100
		packset for 1-3/8" door or 1-3/4" door per door	schedule	
-	11 11 op 10 om mine 0	desired for a great of a great per deer		
SET#	11 - Janitor/Storage - Singl	e		
3	5 Knuckle Hinges	4 1/2 X 4 1/2	*Note 2	Ives
1	Storeroom Lockset		*Note 2	Schlage
1	Closer	4040XP EDA	*Note 2	LCN
1	Concave Wall Bumper	WS406CCV	*Note 2	Ives
3	Door Silencer	SR64	GREY	Ives
		packset for 1-3/8" door or 1-3/4" door per door		
	1	1		
SET#	12 - EMR/Electrical - Sing	l <u>e</u>		
3	5 Knuckle Hinges	4 1/2 X 4 1/2	*Note 2	Ives
1	Storeroom Lockset		*Note 2	Schlage
1	Exit Device	98F Rim w/07 Lever	*Note 2	Von Duprin
1	Closer	4040XP EDA	*Note 2	LCN
1	Concave Wall Bumper	WS406CCV	*Note 2	Ives
3	Door Silencer	SR64	GREY	Ives
SET#	13 – Electrical - DL			
6	5 Knuckle Hinges	4 1/2 X 4 1/2	*Note 2	Ives
1	Storeroom Lock		*Note 2	Schlage
2	Closer	4040XP EDA	*Note 2	LCN
6	Door Silencer	SR64	GREY	Ives
1	Flush Bolt		*Note 2	Ives

CET #11	Launder Daggaga			
	<u>- Laundry - Passage</u> Knuckle Hinges	4 1/2 X 4 1/2	*Note 2	Ives
	assage Set	7 1/2 X 7 1/2	*Note 2	Schlage
	loser	4040XP EDA	*Note 2	LCN
	oncave Wall Bumper	WS406CCV	*Note 2	Ives
	oor Seal	S88	Note 2	Pemko
	001 0001	ackset for 1-3/8" door or 1-3/4" door per door so	chadula	Telliko
Note	es. 1. Thep lock and ba	tekset for 1-3/8 door of 1-3/4 door per door so	chedule	
SET #15 -	Toilet - Single			
3 5	Knuckle Hinges	4 1/2 X 4 1/2	*Note 2	Ives
1 Pr	rivacy Set		*Note 2	Schlage
1 Cl	loser	4040XPED	*Note 2	LCN
1 Pr	rotection Plate	4" x 1" less width of door	*Note 2	Ives
1 Co	oncave Wall Bumper	WS406CCV	*Note 2	Ives
	oor Silencer	SR64	GREY	Ives
Note	es: 1. Prep lock and ba	ackset for 1-3/8" door or 1-3/4" door per door se	chedule	
		connection to closure and all items for comple		
	- Passage – Set Pair	T. 074 4 4 4 5 TT 4 4 10	43.7	_
	Knuckle Hinges	TA2714 4 1/2 X 4 1/2	*Note 2	Ives
	assage Set	an (1	*Note 2	Schlage
	oor Silencer	SR64	GREY	Ives
	otection Plate	36"x1" less door width XCSK	*Note 2	Ives
1 F1	ush Bolt		*Note 2	Ives
SET #17 -	- MC Fitness/Activity			
	inges	4 1/2 X 4 1/2	*Note 2	Ives
	orridor	Classroom Lock	*Note 2	Schlage
1 Cl	loser	4040XP EDA	*Note 2	Norton
1 Co	oncave Wall Bumper	WS406CCV	*Note 2	Ives
	_			
SET #18 -		1.1/2.77	da r	_
	inges	4 1/2 X 4 1/2	*Note 2	Ives
	xit Device - Classroom	98 F Rim w/07 Lever	*Note 2	Von Duprin
	loser	4040XP EDA	*Note 2	LCN
	rotection Plate	12" x 1" less width of door x CSK	*Note 2	Ives
	oncave Wall Bumper	WS406CCV	*Note 2	Ives
	erimeter Seal	S88		Pemko
	oor Bottom	315		Pemko
Note	es: 1. Prep lock and ba	ackset for 1-3/8" door or 1-3/4" door per door so	chedule	
SET #19 -	Exterior			
		4 1/2 X 4 1/2	*Note 2	Ives
	inges xit Device - Classroom	98 F Rim w/07 Lever		
		4040XP EDA	*Note 2	Von Duprin
	loser		*Note 2	LCN
	mb Weatherstrip	290	*Note 2	Pemko
	ead Weatherstrip	2891	*Note 2	Pemko
	oor Bottom	216	*Note 2	Pemko
1 Th	hreshold	253	*Note 2	Pemko

SET #20 – Exterior (Service)

3	Hinges	4 1/2 X 4 1/2	*Note 2	Ives
1	Mech Push Button	5010 Kaba Simplex	*Note 2	Kaba
1	Exit Device	compatible w/Kaba lock	*Note 2	Von Duprin
1	Closer	4040XP EDA	*Note 2	LCN
2	Jamb Weatherstrip	290	*Note 2	Pemko
1	Head Weatherstrip	2891	*Note 2	Pemko
1	Door Sweep	18061	*Note 2	Pemko
1	Threshold	253	*Note 2	Pemko

SET #21 – Secure Door – SL

3	Hinges	4 1/2 X 4 1/2	*Note 2	ves
1	Exit Device	by others	*Note 2	
1	Closer	4040XP EDA	*Note 2 I	LCN
2	Keypad	by others	*Note 2	
1	Mag Door Lock	by others	*Note 2	

^{*}ELECTRONIC LOCKS NEED TO BE VERIFIED WITH OWNER/STANLEY

SET #22 – Singular Barn Door

Provide Hafele Flatec barn door system with bottom guide, door stop hanger and bolts, upper track wall attachment for complete system finish selected by Architect.

SET #23 – Pocket Door - DL

2	Track/Hanger	9850-96" AL	*Note 2	Hager
2	Door Pull	102-RKW Type 5 HD	*Note 2	Rockwood
1	Accessory	9639XU52C	*Note 2	Hager

Finish to be selected by Owner

SECTION 08 8000 - GLAZING (Must meet MA Code)

Scope: Provide glass for all glazed doors and bathroom mirrors. Provide tempered safety glass where

required.

Products:

A. Interior doors and partition: 1/4" clear, tempered, float glass.

Interior fire-rated doors: FireLite glass.

Exterior windows: 5/8" insulating glass clear/clear. Mirrors: 1/4" framed mirrors, with full silver coating.

SECTION 08 9000 - LOUVERS AND VENTS

Scope: Provide architectural, fixed extruded aluminum louvers, insulation adjustable louvers, acoustical

louvers and area way louvers – Wall vents per HVAC plans.

A. Provide above louvers as manufactured by Airolite Company, Greenheck, Fypon or approved equal. Sizes and locations as shown on Drawings. Colors selected by Architect.

DIVISION 9

SECTION 09 2900 - GYPSUM BOARD

Scope: Provide:

A. Metal framing and furring for gypsum board.

B. Metal suspension systems for gypsum board ceilings.

- C. Sound attenuation insulation.
- D. Gypsum board.
- E. Acoustical sealants.
- F. Assume 24" spacing for studs. (Non-load-bearing walls)

Products:

- A. Interior non-bearing partitions: Interior bearing walls, exterior walls, and other fire rated assemblies: 5/8" Type X or Type C, per Code and Tested Assembly requirements.
- B. Floor/ceiling assemblies: 5/8" Type X or Type C over resilient channels, per Code and test Assembly requirements. 2 layers 5/8" Type X or Type C at roof/ceiling assembly.
- C. Suspended soffit areas: 5/8" regular over metal suspension and framing systems. Fire-rated (Type X or C) where shown on Drawings or required by Code.
- D. Baths, Restrooms: Water resistant type (MR) in the thickness and fire resistant class as required to maintain fire resistance of wall assembly.
- E. Provide 5/8" Goldbond gypsum board for all exterior sheathing.
- F. Insulation: USG "Thermafiber" where required for fire ratings. Ordinary thermal insulation not permitted. (Continued on next page)
- G. Accessories: Resilient channels, corner beads, casing beads and fasteners as required.
- H. Sealant: USG Acoustical Sealant around entire perimeter of each wythe of drywall of each section of each sound-rated party wall.

SECTION 09 3000 - TILING

Scope: Provide tile floors, base, at common and bathrooms.

In public toilets provide tile floor and walls (48" aff.) Size, color of tile selected by Owner.

Products: Tile: Tile with square edges. Provide matching cove wall base. Colors/type selected by Owner.

Setting methods: Thinset floors complying with TCA F113. Thinset walls complying with TCA W223 with latex Portland cement grout, except in kitchen with epoxy mortar and grout.

SECTION 09 5000 - ACOUSTICAL WALL & CEILINGS

Scope: On wall dividing preschool and muti purpose room, provide polyester acoustical panels.

On wall between hangout room and art, and ceiling of hangout room, provide polyester acoustical

panels on wall and ceiling.

Product: Poly Max acoustical wall and ceiling tiles by Acoustical Surfaces, Inc. or equal.

Color(s) selected by Architect.

SECTION 09 5113 - ACOUSTICAL PANEL CEILINGS

Scope: Provide acoustical ceilings in public spaces, and corridors as scheduled.

Products: Acoustic Ceiling Schedule:

A. Commons Rooms where noted:

24" x 24" white steel grid; Armstrong Dune, Beveled Tegular, fine texture.

B. Public Corridors:

24" x 24" white steel grid; Armstrong Dune, Beveled Tegular, fine texture.

C. Corridors:

24" x 48" white steel grid; Armstrong Dune.

D. <u>Bathrooms:</u>

Washable 24" x 24" white steel grid, Armstrong.

Note: To be verified with Owner.

SECTION 09 6519 - RESILIENT TILE FLOORING

Scope: See Interior Design Drawings Legends and Schedules

Products:

See Interior Design Drawings

SECTION 09 6816 - CARPET

Scope: See Interior Design Drawings

SECTION 09 9100 - PAINTING

Scope: Paint and finish all interior surfaces except surfaces to receive tile or FRP, finished metals,

acoustical ceilings finished cabinets and millwork. Final color selections by Owner. Low voc paint

required. Sherwin Williams - Basis of design.

Products:

A. Gypsum board ceilings: 1 coat primer; 2 coats flat latex; roller texture fin. coat.

 $B. \quad Gypsum\ board\ walls-1\ coat\ primer;\ Paint\ finish:\ 2\ coats\ eggshell\ latex.$

C. Gypsum board walls - Vinyl fabric finish: 1 coat vinyl-acrylic primer.

D. Painted wood trim interior: 1 coat undercoat. 2 coats semi - gloss enamel.

DIVISION 10

SECTION 10 1400 - SIGNAGE

Scope: By Owner.

SECTION 10 2800 - TOILET, BATH, AND LAUNDRY ACCESSORIES

Scope: Provide residential quality toilet accessories as scheduled:

Products: AJ Washroom, HD Supply, as noted.

Schedule:

Typical Single Public Toilet Room (EACH)

<u>Item</u>	<u>Manufacturer</u>	<u>Number</u>	<u>Finish</u>
Surface Toilet Paper Holder	HD Supply		Chrome
Grab Bar 2 @ 42"	HD Supply		St. Stl. (peened)

(1) Auto Paper Towel Dispenser Georgia Pacific enMotion 89480 Smoke

(1)Waste Receptacle AJ Washroom U440

Framed Mirror 24"W x32"H Highgate MR-W White (1) Horizon Baby Changing Koala Kare KB200-01 Gray

Station (3 Total)

SECTION 10 4413 - FIRE EXTINGUISHER CABINETS

Scope: Provide fire extinguishers cabinets at each stair door on each floor, and in corridors and other spaces,

as required by NFPA code.

Products:

A. Cabinets:

- 1. Recessed extinguisher cabinet at corridors: Larsen (2½") with return trim and vision panel door
- 2. Surface mounted extinguisher in mechanical, maintenance, electrical rooms and kitchen, receiving and trash, elevator machine room.

SECTION 10 4416 - FIRE EXTINGUISHERS

Scope: Provide fire extinguishers at each new cabinet in corridors and other spaces, as required by NFPA

code.

Products: Fire extinguishers: Multipurpose dry chemical; 10lb.UL Standard 299, UL rating 4A-60BC and

kitchen type K.

SECTION 10 5113 - METAL LOCKERS

Scope: Provide triple tier lockers in following:

Gym 12w x 3h, Corridor 12w x 3h, Preschool 5w x 3h.

Products: Lyon "Triple Tier Quiet Lockers" with the following:

A. Locks: Standard handles with latch and eye for padlock by Owner.

B. Tops: Continuous sloped top matching locker face.

C. Base: "Z" Type, 12 gage, 4" high base, finished to match lockers.

D. Identification: Standard etched plates.

E. Fillers: As required to match lockers.

SECTION 10 5613 - WIRE STORAGE SHELVING

Scope: Provide wire shelving and clothes racks in closets shown. Provide shelving as indicated.

Products: Closet Maid vinyl-coated steel shelving.

A. Janitor Closet:

12" linen shelf No. 7315.

B. Reach in closets

12" No. 7300 shelf and rod.

DIVISION 11

SECTION 11 3100 - APPLIANCES

Scope: Provide appliances as scheduled.

Schedule:

KITCHEN

Item	Manufacturer	Number	Color
(1) Refrigerator (French Door)	GE	GFE26JMFS	St. Stl.
(1) Slide In Range	GE	JS645SLSS	St. Stl.
(1)Microwave/Hood	GE	PVM9225SRSS	St. Stl.
(1)Toaster Oven	GE	G90AABSSPSS	St. St.

DIVISION 12

SECTION 12 2200 - BLINDS

Scope: General contractor is to provide all blocking as required to install window drapery hardware.

General contractor to provide black out roller blinds in hang out room. Color selected by Owner.

SECTION 12 3530 - CASEWORK

Scope: Provide base, wall-hung, and vanity cabinets. See interior design drawings.

Products:

- A. Preschool, Concession, Kitchenette, Art, Kitchen printer to be
 - 1. Wolfe Cabinets Wolfe raised panel Owner to confirm finish.
 - 2. Cabinet types and sizes as shown on drawings.
 - 3. Pulls: Satin nickel plated wire pull on all doors and drawers.
 - 4. Provide finished ends and panels on all exposed cabinet ends or surfaces. No cabinet base frame shall be exposed at final installation. All finishes shall be wood veneer to match basic cabinet finish.
 - 5. Provide fillers, hardware and all accessories for a complete installation.
- B. Countertops: solid-surface with under-mount sinks. Public Toilets: Provide solid-surface counter and undermount sink (or equal).
- C. Kitchenette and Kitchen: Quartz and backsplash.
- D. Provide Rakks inside wall mount brackets (EH) at counters.

SECTION 12690 - ENTRANCE MATS

Scope: See Interior Design Plans

DIVISION 13

SECTION 13 0000 - VINYL FENCE

Scope: Provide 6' high vinyl fence at early ed play area. Provide 3' gate tied into fire alarm.

Product: CertainTeed Bufftech Galveston with CertaGrain texture or equal. Color: custom to match green

selected by Architect.

SECTION 26 - ELECTRICAL

SECTION 26 000 - WI-FI

Scope: Provide Wi-Fi system for entire complex, existing and new additions. Provide Sonos speaker

system with coverage throughout existing and new additions.

END OF SPECIFICATIONS