

July 15, 2022

City of Newburyport Historical Commission Attn: Katelyn Sullivan, Planner 60 Pleasant Street Newburyport, MA 01950 (978) 465-4400 ext 2 planning@cityofnewburyport.com

**Subject:** Invitation to Comment

4BN1531C / Forrester Prof Bldg (L600)

37 1/2 Forrester Street, Newburyport, Essex County, Massachusetts

EBI Project # 6122006263

Dear Katelyn Sullivan:

Pursuant to Section 106 of the National Historic Preservation Act, the regulations promulgated thereunder and interagency agreements developed thereto, EBI Consulting, Inc., on behalf of T-Mobile, provides this notice of a proposed telecommunications facility installation at the address listed above.

EBI would like to inquire if you would be interested in commenting on this proposed project. Please refer to the attached plans for additional details.

Please note that we are requesting your review of the attached information as part of the Section 106 process only and not as part of the local zoning process. We are only seeking comments related to the proposed project's potential effect to historic properties.

Please submit your comments regarding the proposed project's potential effect on historic properties to EBI Consulting, to my attention at 21 B Street, Burlington, MA 01803, or contact me via telephone at the number listed below. Please reference the EBI project number. We would appreciate your comments as soon as possible within the next 30 days.

Note that this project will be entered into the Federal Communication Commission's e106 System, which will send notifications of the project throughout the Section 106 process.


Respectfully Submitted,

Emily Giacomarra Architectural Historian egiacomarra@ebiconsulting.com

Emily Giacomarra

T (774) 258-0042

Attachments - Drawings and Maps

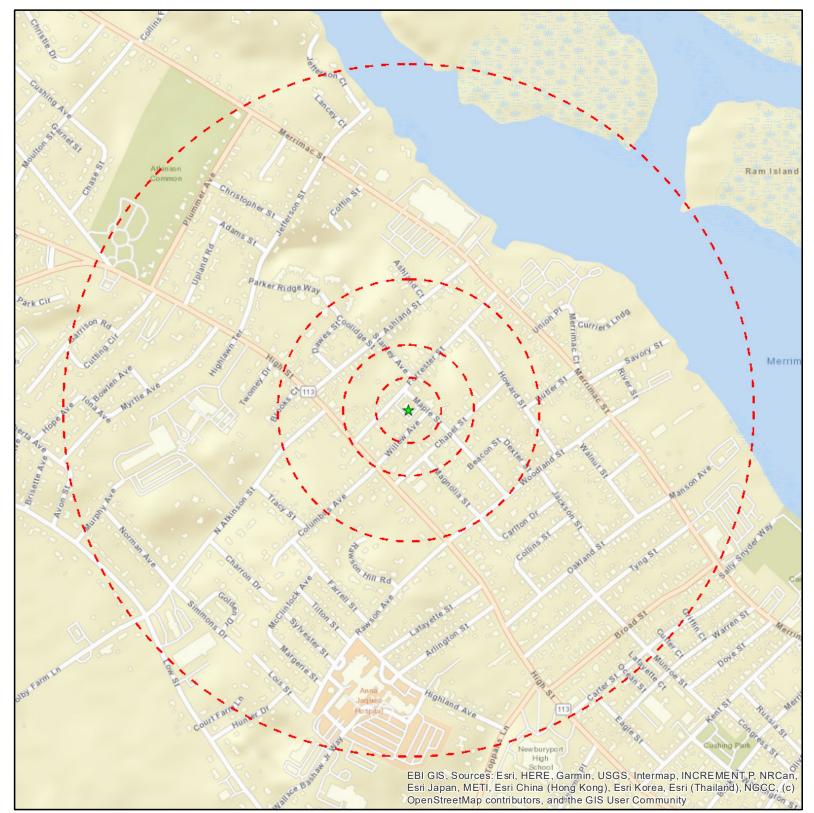

Legend

**Project Site** 


Site Radius at 250', 500', 1000' and ½ mile

Figure 1: Site Location Map

4BN1531C FORRESTER PROF BLDG (L600) **37 1/2 FORRESTER STREET NEWBURYPORT, MA 01950** 



Date: 6/15/2022

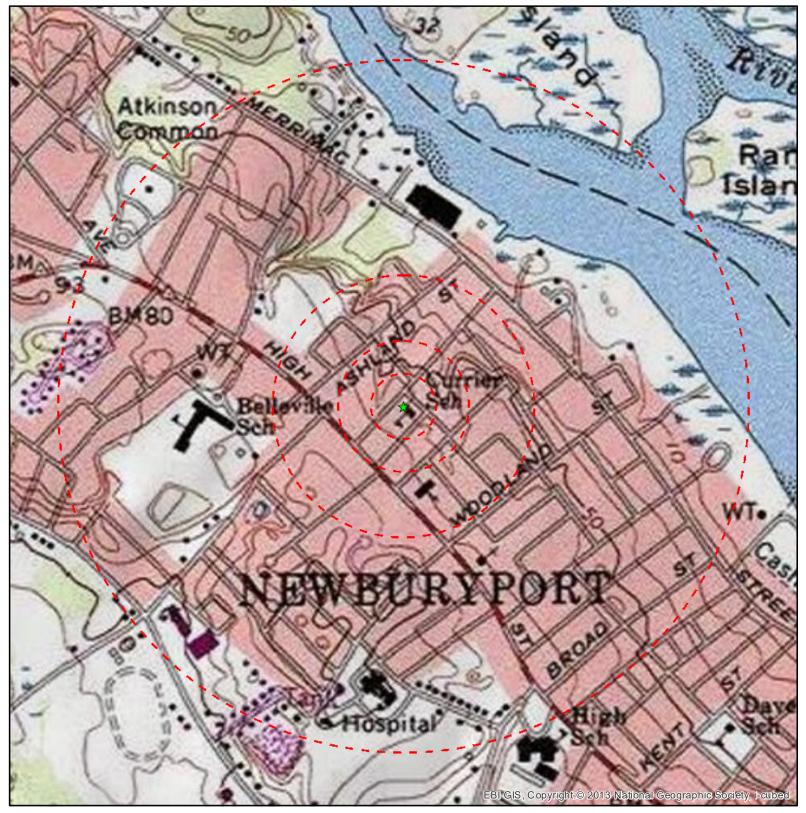

Legend

★ Project Site

Site Radius at 250', 500', 1000' and ½ mile

USGS 24K Quad: Newburyport West, MA 1986

Figure 2 - Topographic Map

4BN1531C FORRESTER PROF BLDG (L600) 37 1/2 FORRESTER STREET NEWBURYPORT, MA 01950



Date: 6/15/2022

**APPROVED** 

By Shivam Shah at 2:41 pm, Apr 15, 2022



# T-MOBILE NORTHEAST LLC **L600**

**SITE #: 4BN1531C** SITE NAME: BN531 / FORRESTER PROF BLDG 37 1/2 FORRESTER STREET NEWBURYPORT, MA 01950 **ESSEX COUNTY** 

### **GENERAL NOTES**

THIS DOCUMENT IS THE CREATION, DESIGN, PROPERTY, AND COPYRIGHTED WORK OF T-MOBILE. ANY DUPLICATION OR USE WITHOUT EXPRESS WRITTEN CONSENT IS STRICTLY PROHIBITED. DUPLICATION AND USE BY GOVERNMENT AGENCIES FOR THE PURPOSES OF CONDUCTING THEIR LAWFULLY AUTHORIZED REGULATORY AND ADMINISTRATIVE FUNCTIONS IS SPECIFICALLY ALLOWED.

THE FACILITY IS AN UNMANNED, PRIVATE, AND SECURED EQUIPMENT INSTALLATION. IT IS ONLY ACCESSED BY TRAINED TECHNICIANS FOR PERIODIC ROUTINE MAINTENANCE AND, THEREFORE, DOES NOT REQUIRE ANY WATER OR SANITARY SEWER SERVICE. THE FACILITY IS NOT GOVERNED BY REGULATIONS REQUIRING PUBLIC ACCESS PER ADA REQUIREMENTS.

CONTRACTOR SHALL VERIFY ALL PLANS AND EXISTING DIMENSIONS AND CONDITIONS ON THE JOB SITE AND SHALL IMMEDIATELY NOTIFY THE T-MOBILE NORTHEAST, LLC REPRESENTATIVE IN WRITING OF DISCREPANCIES BEFORE PROCEEDING WITH THE WORK OR BE RESPONSIBLE FOR SAME.

## **SPECIAL STRUCTURAL NOTES**

STRUCTURE OWNER SHALL BE RESPONSIBLE FOR GLOBAL STRUCTURAL STABILITY ANALYSIS OF EXISTING SUPPORT STRUCTURE. GENERAL CONTRACTOR SCOPE OF WORK SHALL INCLUDE ALL REQUIRED STRUCTURAL MODIFICATIONS, RE-BUNDLING OF COAXIAL CABLES OR OTHER SPECIAL MODIFICATIONS AS OUTLINED THEREIN.


STRUCTURAL DESIGNS AND DETAILS FOR ANTENNA MOUNTS COMPLETED BY ELEVATED ENGINEERING, PLLC ON BEHALF OF T-MOBILE ARE INCLUSIVE OF THE ENTIRE ANTENNA SUPPORT STRUCTURE (GLOBAL STRUCTURAL STABILITY ANALYSIS BY OTHERS), EXISTING PLATFORM, EXISTING ANTENNA MOUNTS, AND ALL OTHER ASPECTS OF THE STRUCTURE THAT WILL SUPPORT THE T-MOBILE EQUIPMENT DEPLOYMENT AS DEPICTED HEREIN.

ELEVATED ENGINEERING, PLLC ASSUMES THAT THE STRUCTURE IS PROPERLY CONSTRUCTED AND MAINTAINED. ALL STRUCTURAL MEMBERS AND THEIR CONNECTIONS ARE ASSUMED TO BE IN GOOD CONDITION AND ARE FREE FROM DEFECTS WITH NOT DETERIORATION TO IT'S MEMBER CAPACITIES.

APPROVAL	_S
PROJECT MANAGER	DATE
CONSTRUCTION	DATE
RF ENGINEERING	DATE
ZONING / SITE ACQUISITION	DATE
OPERATIONS	DATE
OWNER	DATE

**RAN CONFIGURATION: 67E02C OUTDOOR** 

**A&L CONFIGURATION: 67E02C\_2xAIR+10P** 

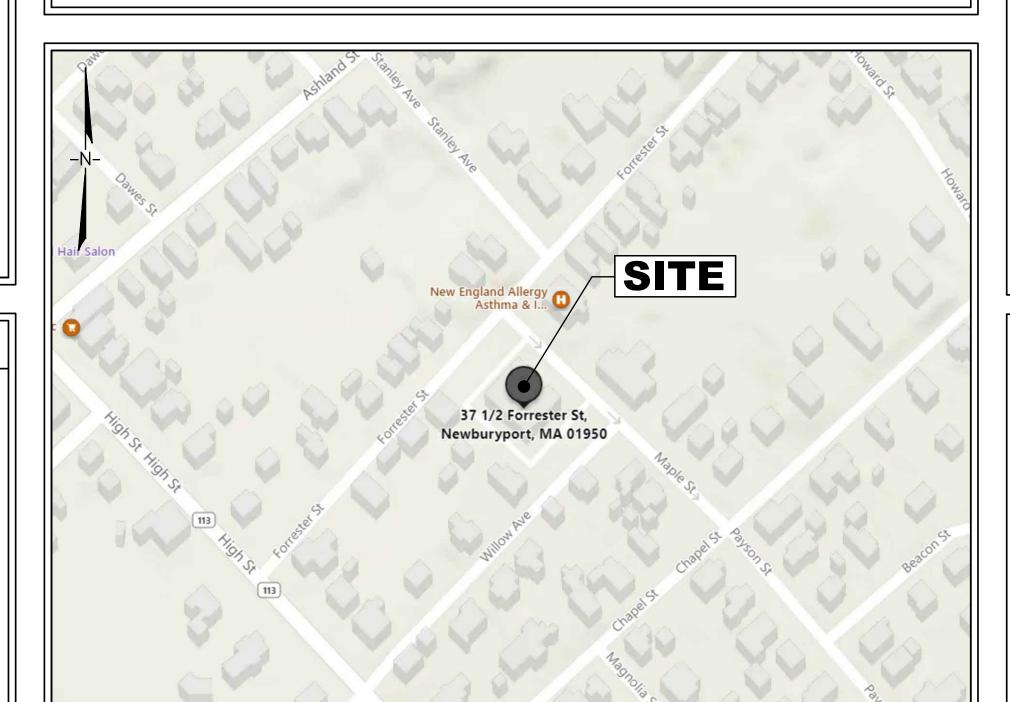

**KEY MAP** 

## **UNDERGROUND SERVICE ALERT**



CALL TOLL FREE: 888-DIG-SAFE (888-344-7233)

## SITE LOCATION INFORMATION

**CONSTRUCTION DRAWINGS** 

ALL SCALES RELATIVE TO 24"X36" PAGE SIZE

SITE NUMBER: 4BN1531C

SITE ADDRESS: 37½ FORRESTER STREET NEWBURYPORT, MA 01950

COUNTY: ESSEX COUNTY

MAP 2B, BLOCK 62, LOT 35 PARCEL ID:

PROPERTY OWNER: ZACHARY LONGLEY - ZARR LIMITED PARTNERSHIP

37% FORRESTER STREET NEWBURYPORT, MA 01950

APPLICANT: T-MOBILE NORTHEAST LLC 15 COMMERCE WAY, SUITE B

NORTON, MA 02766

## SITE CHARACTERISTICS

-70.89016000°

42.82065000° LATITUDE:

ROOFTOP STRUCTURE TYPE:

LOCATION OF ROOFTOP PLATFORM PROPOSED EQUIPMENT:

LONGITUDE:

STRUCTURE HEIGHT:  $\pm 35'-6$ " AGL (TOP OF ROOF)

 $ALPHA - \pm 47'-0" AGL$ ANTENNA (RAD CENTER) BETA  $-\pm47'-0"$  AGL

 $GAMMA - \pm 47'-0" AGL$ 

## **SHEET INDEX**

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A-2	ELEVATION
A-3	ANTENNA PLANS
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A-5	DETAILS
S-1	ALPHA FRAMING PLAN & DETAILS
S-2	ALPHA RF ENCLOSURE & DETAILS
S-3	BETA FRAMING PLAN & DETAILS
S-4	BETA RF ENCLOSURE & DETAILS
S-5	GAMMA FRAMING PLAN & DETAILS
S-6	GAMMA RF ENCLOSURE & DETAILS
S-7	ANTENNA MOUNT DETAILS
E-1	GROUNDING DETAILS & ONE-LINE DIAGRAM

15 COMMERCE WAY, SUITE B **NORTON, MA 02766** OFFICE: (508) 286-2700 FAX: (508) 286-2893

## ELEVATED **ENGINEERING**

976 TABOR ROAD, UNIT 6 MORRIS PLAINS, NJ 07950 862-242-8050

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## **SCHEDULE OF REVISIONS**

REV.	DATE	DESCRIPTION OF CHANGES
0	01/05/22	INITIAL SUBMISSION
1	02/03/22	PER RF ENCLSOURE DESIGN
2	02/18/22	ISSUED AS FINAL
3		
4		
5		
6		
7		

**DRAWN BY:** CJT

**CHECKED BY:** NDB

SCALE: AS NOTED

21046-TRN **JOB NO:** 

INFORMATION ON THIS SET OF DRAWINGS IS NOT FOR OFFICIAL USE UNLESS ACCOMPANIED BY THE STAMPED SEAL & SIGNATURE OF A PROFESSIONAL ENGINEER



NICHOLAS D. BARILE

PROFESSIONAL ENGINEER, MA LIC. No. 51464

4BN1531C BN531/FORRESTER PROF BLDG 37 1/2 FORRESTER ST NEWBURYPORT, MA 01950 **ESSEX COUNTY** 

**DRAWING TITLE:** 

TITLE SHEET

## GENERAL NOTES

1. FOR THE PURPOSE OF THE CONSTRUCTION DRAWING, THE FOLLOWING DEFINITIONS SHALL APPLY:

CONTRACTORS — TO BE DETERMINED SUBCONTRACTOR — GENERAL CONTRACTOR (CONSTRUCTION) OWNER — T-MOBILE

- 2. PRIOR TO THE SUBMISSION OF BIDS, THE BIDDING SUBCONTRACTOR SHALL VISIT THE CELL SITE TO FAMILIARIZE WITH THE EXISTING CONDITIONS AND TO CONFIRM THAT THE WORK CAN BE ACCOMPLISHED AS SHOWN ON THE CONSTRUCTION DRAWINGS. ANY DISCREPANCY FOUND SHALL BE BROUGHT TO THE ATTENTION OF THE CONTRACTOR.
- 3. ALL MATERIALS FURNISHED AND INSTALLED SHALL BE IN STRICT ACCORDANCE WITH ALL APPLICABLE CODES, REGULATIONS AND ORDINANCES. SUBCONTRACTOR SHALL ISSUE ALL APPROPRIATE NOTICES AND COMPLY WITH ALL LAWS, ORDINANCES, RULES, REGULATIONS AND LAWFUL ORDERS OF ANY PUBLIC AUTHORITY REGARDING THE PERFORMANCE OF THE WORK. ALL WORK CARRIED OUT SHALL COMPLY WITH ALL APPLICABLE MUNICIPAL AND UTILITY COMPANY SPECIFICATIONS AND LOCAL JURISDICTIONAL CODES. ORDINANCES AND APPLICABLE REGULATIONS.
- 4. DRAWINGS PROVIDED HERE ARE NOT TO BE SCALED AND ARE INTENDED TO SHOW OUTLINE ONLY.
- 5. UNLESS NOTED OTHERWISE, THE WORK SHALL INCLUDE FURNISHING MATERIALS, EQUIPMENT APPURTENANCES, AND LABOR NECESSARY TO COMPLETE ALL INSTALLATIONS AS INDICATED ON THE DRAWINGS.
- 6. "KITTING LIST" SUPPLIED WITH THE BID PACKAGE IDENTIFIES ITEMS THAT WILL BE SUPPLIED BY CONTRACTOR. ITEMS NOT INCLUDED IN THE BILL OF MATERIALS AND KITTING LIST SHALL BE PROVIDED BY THE SUBCONTRACTOR.
- 7. THE SUBCONTRACTOR SHALL INSTALL ALL EQUIPMENT AND MATERIALS IN ACCORDANCE WITH MANUFACTURERS RECOMMENDATIONS UNLESS SPECIFICALLY STATED OTHERWISE.
- 8. IF THE SPECIFIED EQUIPMENT CANNOT BE INSTALLED AS SHOWN ON THESE DRAWINGS, THE SUBCONTRACTOR SHALL PROPOSED AND ALTERNATIVE INSTALLATION SPACE FOR APPROVAL BY CONTRACTOR.

- 9. SUBCONTRACTOR SHALL DETERMINE ACTUAL ROUTING OF CONDUIT, POWER AND T1 CABLES, GROUNDING CABLES AS SHOWN ON THE POWER, GROUNDING AND TELCO PLAN DRAWING. SUBCONTRACTOR SHALL UTILIZE EXISTING TRAYS AND/OR SHALL ADD NEW TRAYS AS NECESSARY. SUBCONTRACTOR SHALL CONFIRM THE ACTUAL ROUTING WITH THE CONTRACTOR.
- 10. THE SUBCONTRACTOR SHALL PROTECT THE EXISTING IMPROVEMENTS, PAVEMENTS, CURBS, LANDSCAPING AND STRUCTURES. ANY DAMAGED PART SHALL BE REPAIRED AT SUBCONTRACTORS EXPENSE TO THE SATISFACTION OF OWNER.
- 11. SUBCONTRACTOR SHALL LEGALLY AND PROPERLY DISPOSE OF ALL SCRAP MATERIAL SUCH AS COAXIAL CABLE AND OTHER ITEMS REMOVED FROM THE EXISTING FACILITY. ANTENNAS REMOVED SHALL BE RETURNED TO THE OWNERS DESIGNATED LOCATION.
- 12. SUBCONTRACTOR SHALL LEAVE PREMISES IN CLEAN CONDITION.
- 13. ALL CONCRETE REPAIR WORK SHALL BE DONE IN ACCORDANCE WITH AMERICAN CONCRETE INSTITUTE (ACI) 301.
- 14. ANY NEW CONCRETE NEEDED FOR THE CONSTRUCTION SHALL BE AIR—ENTRAINED AND SHALL HAVE 4000 PSI STRENGTH AT 28 DAYS. ALL CONCRETE WORK SHALL BE DONE IN ACCORDANCE WITH ACI 318 CODE REQUIREMENTS.
- 15. ALL STRUCTURAL STEEL WORK SHALL BE DETAILED, FABRICATED AND ERECTED IN ACCORDANCE WITH AISC SPECIFICATIONS. ALL STRUCTURAL STEEL SHALL BE ASTM A36 (Fy = 36 ksi) UNLESS OTHERWISE NOTED. PIPES SHALL BE ASTM A53 TYPE E (Fy = 36 ksi). ALL STEEL EXPOSED TO WEATHER SHALL BE HOT DIPPED GALVANIZED. TOUCH UP ALL SCRATCHED AND OTHER MARKS IN THE FIELD AFTER STEEL IS ERECTED USING A COMPATIBLE ZINC RICH PAINT.
- 16. CONSTRUCTION SHALL COMPLY WITH UMTS SPECIFICATIONS AND "GENERAL CONSTRUCTION SERVICES FOR CONSTRUCTION OF T-MOBILE SITES."
- 17. SUBCONTRACTORS SHALL VERIFY ALL EXISTING DIMENSIONS AND CONDITIONS PRIOR TO COMMENCING ANY WORK. ALL DIMENSIONS OF EXISTING CONSTRUCTION SHOWN ON THE DRAWINGS MUST BE VERIFIED. SUBCONTRACTOR SHALL NOTIFY THE CONTRACTOR OF ANY DISCREPANCIES PRIOR TO ORDERING MATERIAL OR PROCEEDING WITH CONSTRUCTION.

- 18. THE EXISTING CELL SITE IS ACTIVE, ALL SAFETY PRECAUTIONS MUST BE TAKEN WHEN WORKING AROUND HIGH LEVELS OF ELECTROMAGNETIC RADIATION. EQUIPMENT SHOULD BE SHUTDOWN PRIOR TO PERFORMING ANY WORK THAT COULD EXPOSE THE WORKERS TO DANGER. PERSONAL RF EXPOSURE MONITORS ARE ADVISED TO BE WORN TO ALERT OF ANY DANGEROUS EXPOSURE LEVELS.
- 19. APPLICABLE BUILDING CODES:

SUBCONTRACTORS WORK SHALL COMPLY WITH ALL APPLICABLE NATIONAL, STATE AND LOCAL CODES AS ADOPTED BY THE LOCAL AUTHORITY HAVING JURISDICTION (AHJ) FOR THE LOCATION. THE EDITION OF THE AHJ ADOPTED CODES AND STANDARDS IN EFFECT ON THE DATE OF CONTRACT AWARD SHALL GOVERN THE DESIGN.

- BUILDING CODE: MA STATE BUILDING CODE 780 CMR 8TH EDITION
- ELECTRICAL CODE: REFER TO ELECTRICAL DRAWINGS
- LIGHTNING CODE: REFER TO ELECTRICAL DRAWINGS

SUBCONTRACTORS WORK SHALL COMPLY WITH THE LATEST EDITION OF THE FOLLOWING STANDARDS:

- AMERICAN CONCRETE INSTITUTE (ACI) 318; BUILDING CODE REQUIREMENT FOR STRUCTURAL CONCRETE
- AMERICAN INSTITUTE FOR STEEL CONSTRUCTION (AISC)
- MANUAL OF STEEL CONSTRUCTION, ASD, NINTH EDITION
- TELECOMMUNICATIONS INDUSTRY ASSOCIATION (TIA) 222-G, STRUCTURAL STANDARDS FOR STEEL
- ANTENNA TOWER AND ANTENNA SUPPORTING STRUCTURES; REFER TO ELECTRICAL DRAWINGS FOR SPECIFIC ELECTRICAL STANDARDS.

FOR ANY CONFLICTS BETWEEN SECTIONS OF LISTED CODES AND STANDARDS REGARDING MATERIAL, METHODS OF CONSTRUCTION, OR OTHER REQUIREMENTS, THE MOST RESTRICTIVE REQUIREMENT SHALL GOVERN. WHERE THERE IS A CONFLICT BETWEEN A GENERAL REQUIREMENT, THE SPECIFIC REQUIREMENT SHALL GOVERN.

## ELECTRICAL & GROUNDING NOTES

- 1. THE SUBCONTRACTOR SHALL REVIEW AND INSPECT THE EXISTING FACILITY GROUNDING SYSTEM AND LIGHTNING PROTECTION SYSTEM (AS DESIGNED AND INSTALLED) FOR STRICT COMPLIANCE WITH THE NEC (AS ADOPTED BY THE AHJ), THE SITE SPECIFIC (UL, LPI, OR NFPA) LIGHTNING PROTECTION CODE, AND GENERAL COMPLIANCE WITH TELCORDIA AND TIA GROUNDING STANDARDS. THE SUBCONTRACTOR SHALL REPORT ANY VIOLATIONS OR ADVERSE FINDINGS TO THE CONTRACTOR FOR RESOLUTION.
- 2. ALL GROUND ELECTRODE SYSTEMS (INCLUDING TELECOMMUNICATION, RADIO LIGHTNING PROTECTION AND AS POWER GES'S) SHALL BE BONDED TOGETHER, AT OR BELOW GRADE, BY TWO OR MORE COPPER BONDING CONDUCTORS IN ACCORDANCE WITH THE NEC
- 3. THE SUBCONTRACTOR SHALL PERFORM IEEE FALL—OF—POTENTIAL RESISTANCE TO EARTH TESTING (PER IEEE 1100 AND 81) FOR NEW GROUND ELECTRODE SYSTEMS. THE SUBCONTRACTOR SHALL FURNISH AND INSTALL SUPPLEMENTAL GROUND ELECTRODES AS NEEDED TO ACHIEVE A TEST RESULT OF 5 OHMS OR LESS.
- 4. METAL RACEWAY SHALL NOT BE USED AS THE NEC REQUIRED EQUIPMENT GROUND CONDUCTOR. STRANDED COPPER CONDUCTORS WITH GREEN INSULATION, SIZED IN ACCORDANCE WITH THE NEC, SHALL BE FURNISHED AND INSTALLED WITH THE POWER CIRCUITS TO THE BTS EQUIPMENT.
- 5. EACH BTS CABINET FRAME SHALL BE DIRECTLY CONNECTED TO THE MASTER GROUND BAR WITH GREEN INSULATED SUPPLEMENTAL EQUIPMENT GROUND WIRES, 6 AWG STRANDED COPPER OR LARGER FOR INDOOR BTS 2 AWG STRANDED COPPER FOR OUTDOOR BTS.
- 6. EXOTHERMIC WELDS SHALL BE USED FOR ALL GROUNDING CONNECTIONS BELOW GRADE.
- 7. APPROVED ANTIOXIDANT COATING (I.E. CONDUCTIVE GEL OR PASTE) SHALL BE USED ON ALL COMPRESSION AND BOLTED GROUND CONNECTIONS.
- 8. ICE BRIDGE BONDING CONDUCTORS SHALL BE EXOTHERMICALLY BONDED OR BOLTED TO THE BRIDGE AND THE TOWER GROUND BAR.
- 9. ALUMINUM CONDUCTOR OR COPPER CLAD STEEL CONDUCTOR SHALL NOT BE USED FOR GROUNDING CONNECTIONS.
- 10. MISCELLANEOUS ELECTRICAL AND NON-ELECTRICAL METAL BOXES, FRAMES AND SUPPORTS SHALL BE BONDED TO THE GROUND RING, IN ACCORDANCE WITH THE NEC.

- 11. METAL CONDUIT SHALL BE MADE ELECTRICALLY CONTINUOUS WITH LISTED BONDING FITTINGS OR BY BONDING ACROSS THE DISCONTINUITY WITH 6 AWS COPPER WIRE UL APPROVED GROUNDING TYPE CONDUIT CLAMPS.
- 12. ALL NEW STRUCTURE WITH A FOUNDATION AND/OR FOOTING HAVING 20 FT. OR MORE OF 1/2 IN. OR GREATER ELECTRICALLY CONDUCTIVE REINFORCING RING USING AN EXOTHERMIC WELD CONNECTION USING #2 AWG SOLID BARE TINNED COPPER GROUND WIRE, PER NEC 250.50.
- 13. ALL ELECTRICAL WORK SHALL CONFORM TO THE REQUIREMENTS OF THE NATIONAL ELECTRICAL CODE (NEC) AS WELL AS APPLICABLE STATE AND LOCAL CODES.
- 14. ALL ELECTRICAL ITEMS SHALL BE U.L. APPROVED OR LISTED AND PROCURED PER SPECIFICATION REQUIREMENTS.
- 15. THE ELECTRICAL WORK INCLUDES ALL LABOR AND MATERIAL DESCRIBED BY DRAWINGS AND SPECIFICATIONS INCLUDING INCIDENTAL WORK TO PROVIDE COMPLETE OPERATING AND APPROVED ELECTRICAL SYSTEM.
- 16. GENERAL CONTRACTOR SHALL PAY FEES FOR PERMITS, AND IS RESPONSIBLE FOR OBTAINING SAID PERMITS AND COORDINATION OF INSPECTIONS.
- 17. ELECTRICAL AND TELCO WIRING OUTSIDE A BUILDING AND EXPOSED TO WEATHER SHALL BE IN WATER TIGHT GALVANIZED RIGID STEEL CONDUITS OR SCHEDULE 80 PVC (AS PERMITTED BY CODE) AND WHERE REQUIRED IN LIQUID TIGHT FLEXIBLE METAL OR NONMETALLIC CONDUITS.
- 18. RIGID STEEL CONDUITS SHALL BE GROUNDED AT BOTH ENDS.
- 19. ELECTRICAL WIRING SHALL BE COPPER WITH TYPE XHHW, THWN OR THIN INSULATION.
- 20. RUN ELECTRICAL CONDUIT OR CABLE BETWEEN ELECTRICAL ROOM AND PROPOSED CELL SITE POWER PEDESTAL AS INDICATED ON THIS DRAWING. PROVIDE FULL LENGTH PULL ROPE. COORDINATE INSTALLATION WITH UTILITY COMPANY.
- 21. RUN TELCO CONDUIT OR CABLE BETWEEN TELEPHONE UTILITY DEMARCATION POINT AND PROPOSED CELL SITE TELCO CABINET AND BTS CABINET AS INDICATED ON DRAWING A-1. PROVIDE FULL LENGTH PULL ROPE IN INSTALLED TELCO CONDUIT. PROVIDE GREENLEE CONDUIT MEASURING TAPE AT EACH END.
- 22. ALL EQUIPMENT LOCATED OUTSIDE SHALL HAVE NEMA 3R ENCLOSURE.

- 23. GROUNDING SHALL COMPLY WITH NEW ART. 250.
- 24. GROUND COAXIAL CABLE SHIELDS MINIMUM AT BOTH ENDS USING MANUFACTURERS COAX CABLE GROUNDING KITS SUPPLIED BY PROJECT OWNER.
- 25. USE #6 COPPER STRANDED WIRE WITH GREEN COLOR INSULATION FOR ABOVE GRADE GROUNDING (UNLESS OTHERWISE SPECIFIED) AND #2 SOLID TINNED BARE COPPER WIRE FOR BELOW GRADE GROUNDING AS INDICATED ON DRAWING.
- 26. ALL GROUND CONNECTIONS TO BE BURNDY HYGROUND COMPRESSION TYPE CONNECTORS OR CADWELD EXOTHERMIC WELD. DO NOT ALLOW BARE COPPER WIRE TO BE IN CONTACT WITH GALVANIZED STEEL.
- 27. ROUTE GROUNDING CONDUCTORS ALONG THE SHORTEST AND STRAIGHTEST PATH POSSIBLE EXCEPT AS OTHERWISE INDICATED. GROUNDING LEADS SHOULD NEVER BE BENT AT RIGHT ANGLE. ALWAYS MAKE AT LEAST 12" RADIUS BENDS. #6 WIRE CAN BE BENT AT 6" RADIUS WHEN NECESSARY. BOND ANY METAL OBJECTS WITHIN 7 FEET OF PROPOSED EQUIPMENT OR CABINET TO MASTER GROUND BAR.
- 28. CONNECTIONS TO MGB SHALL BE ARRANGED IN THREE MAIN GROUPS: SURGE PRODUCERS (COAXIAL CABLE GROUND KITS, TELCO AND POWER PANEL GROUND); (GROUNDING ELECTRODE RING OR BUILDING STEEL); NON—SURGING OBJECTS (EGB GROUND IN BTS UNIT)
- 29. CONNECTIONS TO GROUND BARS SHALL BE MADE WITH TWO HOLE COMPRESSION TYPE COPPER LUGS. APPLY OXIDE INHIBITING COMPOUND TO ALL LOCATIONS.
- 30. BOND ANTENNA MOUNTING BRACKETS. COAXIAL CABLE GROUND KITS AND ALNA TO EGB PLACES NEAR THE ANTENNA LOCATION.
- 31. BOND ANTENNA EGB'S AND MGB TO WATER MAIN.
- 32. TEST COMPLETED GROUND SYSTEM AND RECORD RESULTS FOR PROJECT CLOSE—OUT DOCUMENTATION.
- 33. BOND ANY METAL OBJECTS WITHIN 7 FEET OF PROPOSED EQUIPMENT OR CABINET TO MASTER GROUND BAR.
- 34. VERIFY PROPOSED SERVICE UPGRADE WITH LOCAL UTILITY COMPANY PRIOR TO CONSTRUCTION.

### ABBREVIATIONS ABOVE GRADE LEVEL GENERAL CONTRACTOR RADIO FREQUENCY AMERICAN WIRE GAUGE MGB MASTER GROUND BUS BARE COPPER WIRE TO BE DETERMINED MIN MINIMUM TBD PROPOSED BASE TRANSCEIVER STATION TO BE REMOVED TBRR TO BE REMOVED EXISTING EXISTING N.T.S. NOT TO SCALE AND REPLACED EQUIPMENT GROUND REFERENCE REF TYP TYPICAL EQUIPMENT GROUND RING REQ REQUIRED

# F--Mobile

T-MOBILE NORTHEAST LLC 15 COMMERCE WAY, SUITE B NORTON, MA 02766 OFFICE: (508) 286-2700 FAX: (508) 286-2893

# ELEVATED ENGINEERING

976 TABOR ROAD, UNIT 6

MORRIS PLAINS, NJ 07950

862-242-8050

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**SCHEDULE OF REVISIONS** 

## 

DRAWN BY: CJT

CHECKED BY: NDB

SCALE: AS NOTED

JOB NO:

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SIGNATURE OF A PROFESSIONAL ENGINEER

21046-TRN



NICHOLAS D. BARILE
PROFESSIONAL ENGINEER, MA LIC. No. 51464


4BN1531C
BN531/FORRESTER PROF BLDG
37 1/2 FORRESTER ST
NEWBURYPORT, MA 01950
ESSEX COUNTY

DRAWING TITLE:

GENERAL NOTES

DRAWING SHEET:

GN-1

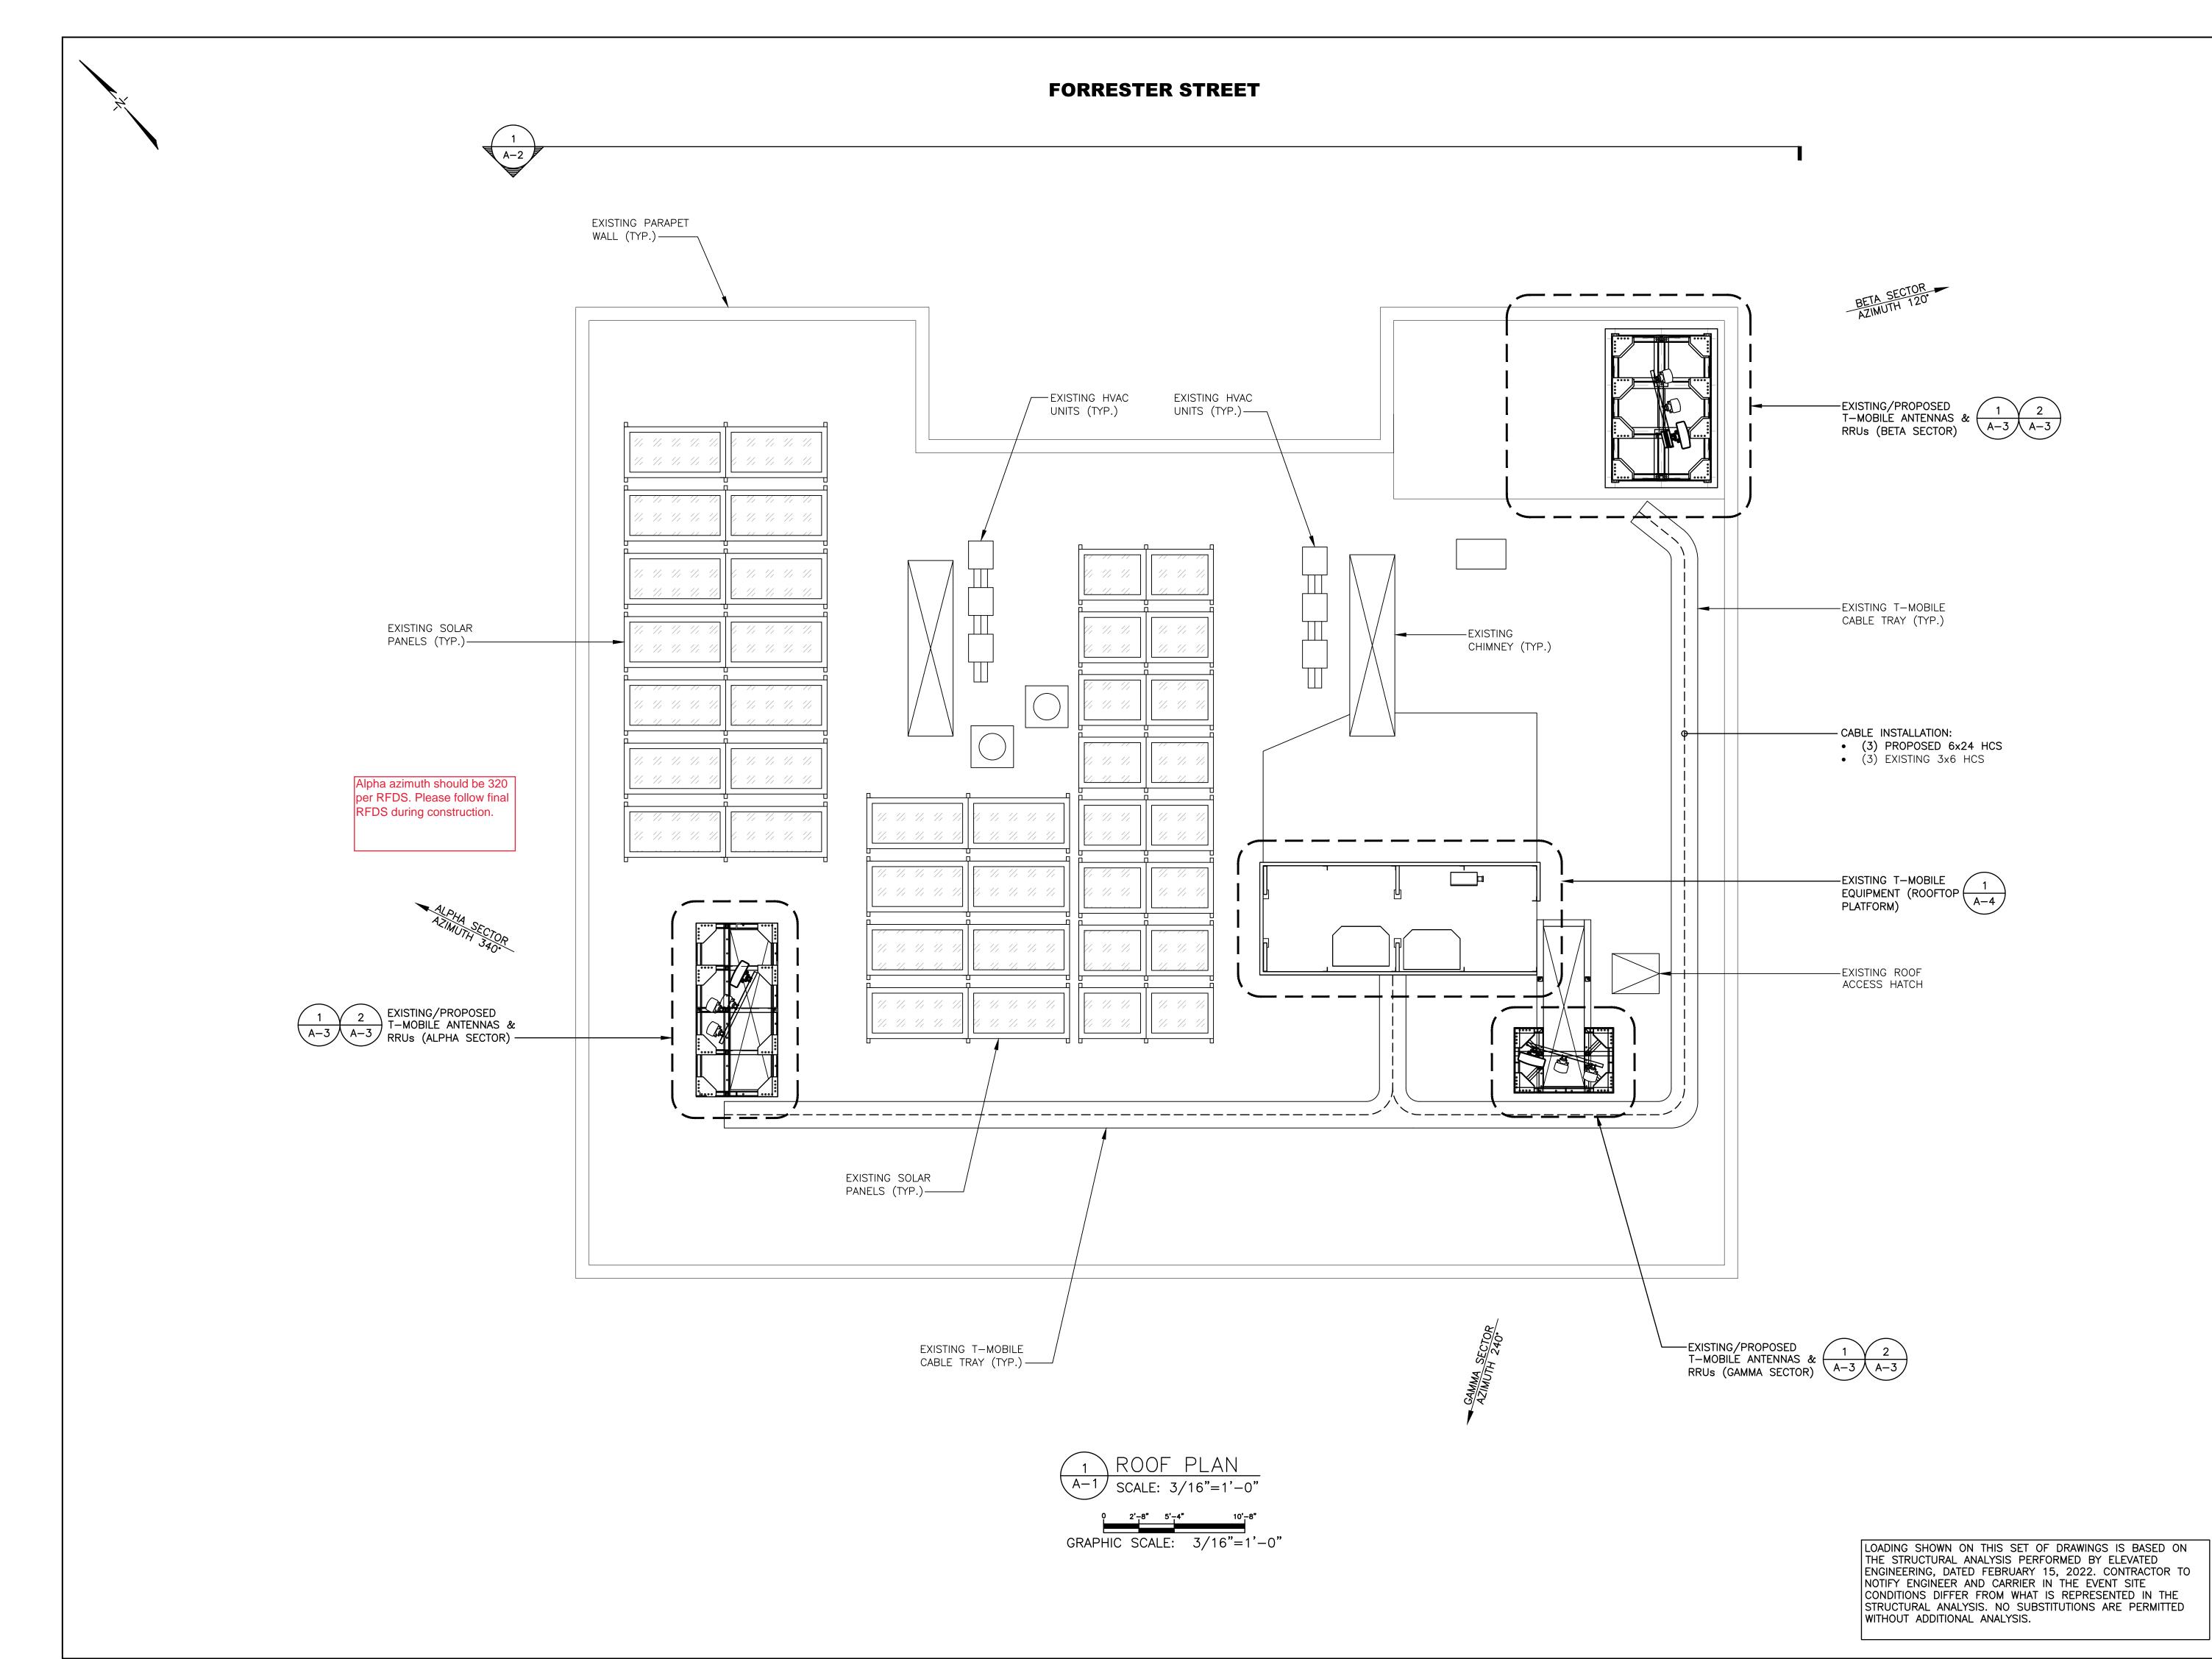

**T**--Mobile

T-MOBILE NORTHEAST LLC 15 COMMERCE WAY, SUITE B NORTON, MA 02766 OFFICE: (508) 286-2700 FAX: (508) 286-2893

# ELEVATED ENGINEERING

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SCHEDULE OF REVISIONS					
7					
6					
5					
4					
3					
2	02/18/22	ISSUED AS FINAL			
1	02/03/22	PER RF ENCLSOURE DESIGN			

INITIAL SUBMISSION

DESCRIPTION OF CHANGES

21046-TRN

DRAWN BY:	CJT
CHECKED BY:	NDB
SCALE:	AS NOTED

**o** 01/05/22

REV. DATE

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NICHOLAS D. BARILE

PROFESSIONAL ENGINEER, MA LIC. No. 51464

4BN1531C
BN531/FORRESTER PROF BLDG
37 1/2 FORRESTER ST
NEWBURYPORT, MA 01950
ESSEX COUNTY

DRAWING TITLE:

**ROOF PLAN** 

DRAWING SHEET:

**A-1** 

LOADING SHOWN ON THIS SET OF DRAWINGS IS BASED ON WITHOUT ADDITIONAL ANALYSIS. EXISTING/PROPOSED T-MOBILE ANTENNAS & A-3 A-3 RRUs (BETA SECTOR)— -EXISTING/PROPOSED -EXISTING/PROPOSED T-MOBILE ANTENNAS & ( T-MOBILE ANTENNAS & ( RRUs (GAMMA SECTOR) A-3 A-3 RRUs (ALPHA SECTOR) TOP OF PROPOSED RF TRANSPARENT ENCLOSURES

EL. = ±50'-8" AGL EXISTING T-MOBILE EQUIPMENT (ROOFTOP  $\bigcirc$  OF EXISTING/PROPOSED T-MOBILE ANTENNAS EL. =  $\pm 47$ '-0" AGL PLATFORM)  $\square \square \square$ EXISTING CHIMNEY (TYP.)— 

GRAPHIC SCALE: 1/4"=1'-0"

THE STRUCTURAL ANALYSIS PERFORMED BY ELEVATED ENGINEERING, DATED FEBRUARY 15, 2022. CONTRACTOR TO NOTIFY ENGINEER AND CARRIER IN THE EVENT SITE CONDITIONS DIFFER FROM WHAT IS REPRESENTED IN THE STRUCTURAL ANALYSIS. NO SUBSTITUTIONS ARE PERMITTED

T-MOBILE NORTHEAST LLC 15 COMMERCE WAY, SUITE B **NORTON, MA 02766** OFFICE: (508) 286-2700 FAX: (508) 286-2893

# ENGINEERING

976 TABOR ROAD, UNIT 6 MORRIS PLAINS, NJ 07950 862-242-8050

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## **SCHEDULE OF REVISIONS 2** 02/18/22 ISSUED AS FINAL **1** 02/03/22 PER RF ENCLSOURE DESIGN **o** 01/05/22 INITIAL SUBMISSION

DATE

DRAWN BY:	CJT				
CHECKED BY:	NDB				
SCALE:	AS NOTED				
JOB NO:	21046-TRN				

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DESCRIPTION OF CHANGES





NICHOLAS D. BARILE PROFESSIONAL ENGINEER, MA LIC. No. 51464

4BN1531C BN531/FORRESTER PROF BLDG **37 1/2 FORRESTER ST** NEWBURYPORT, MA 01950 **ESSEX COUNTY** 

**DRAWING TITLE:** 

**ELEVATION** 

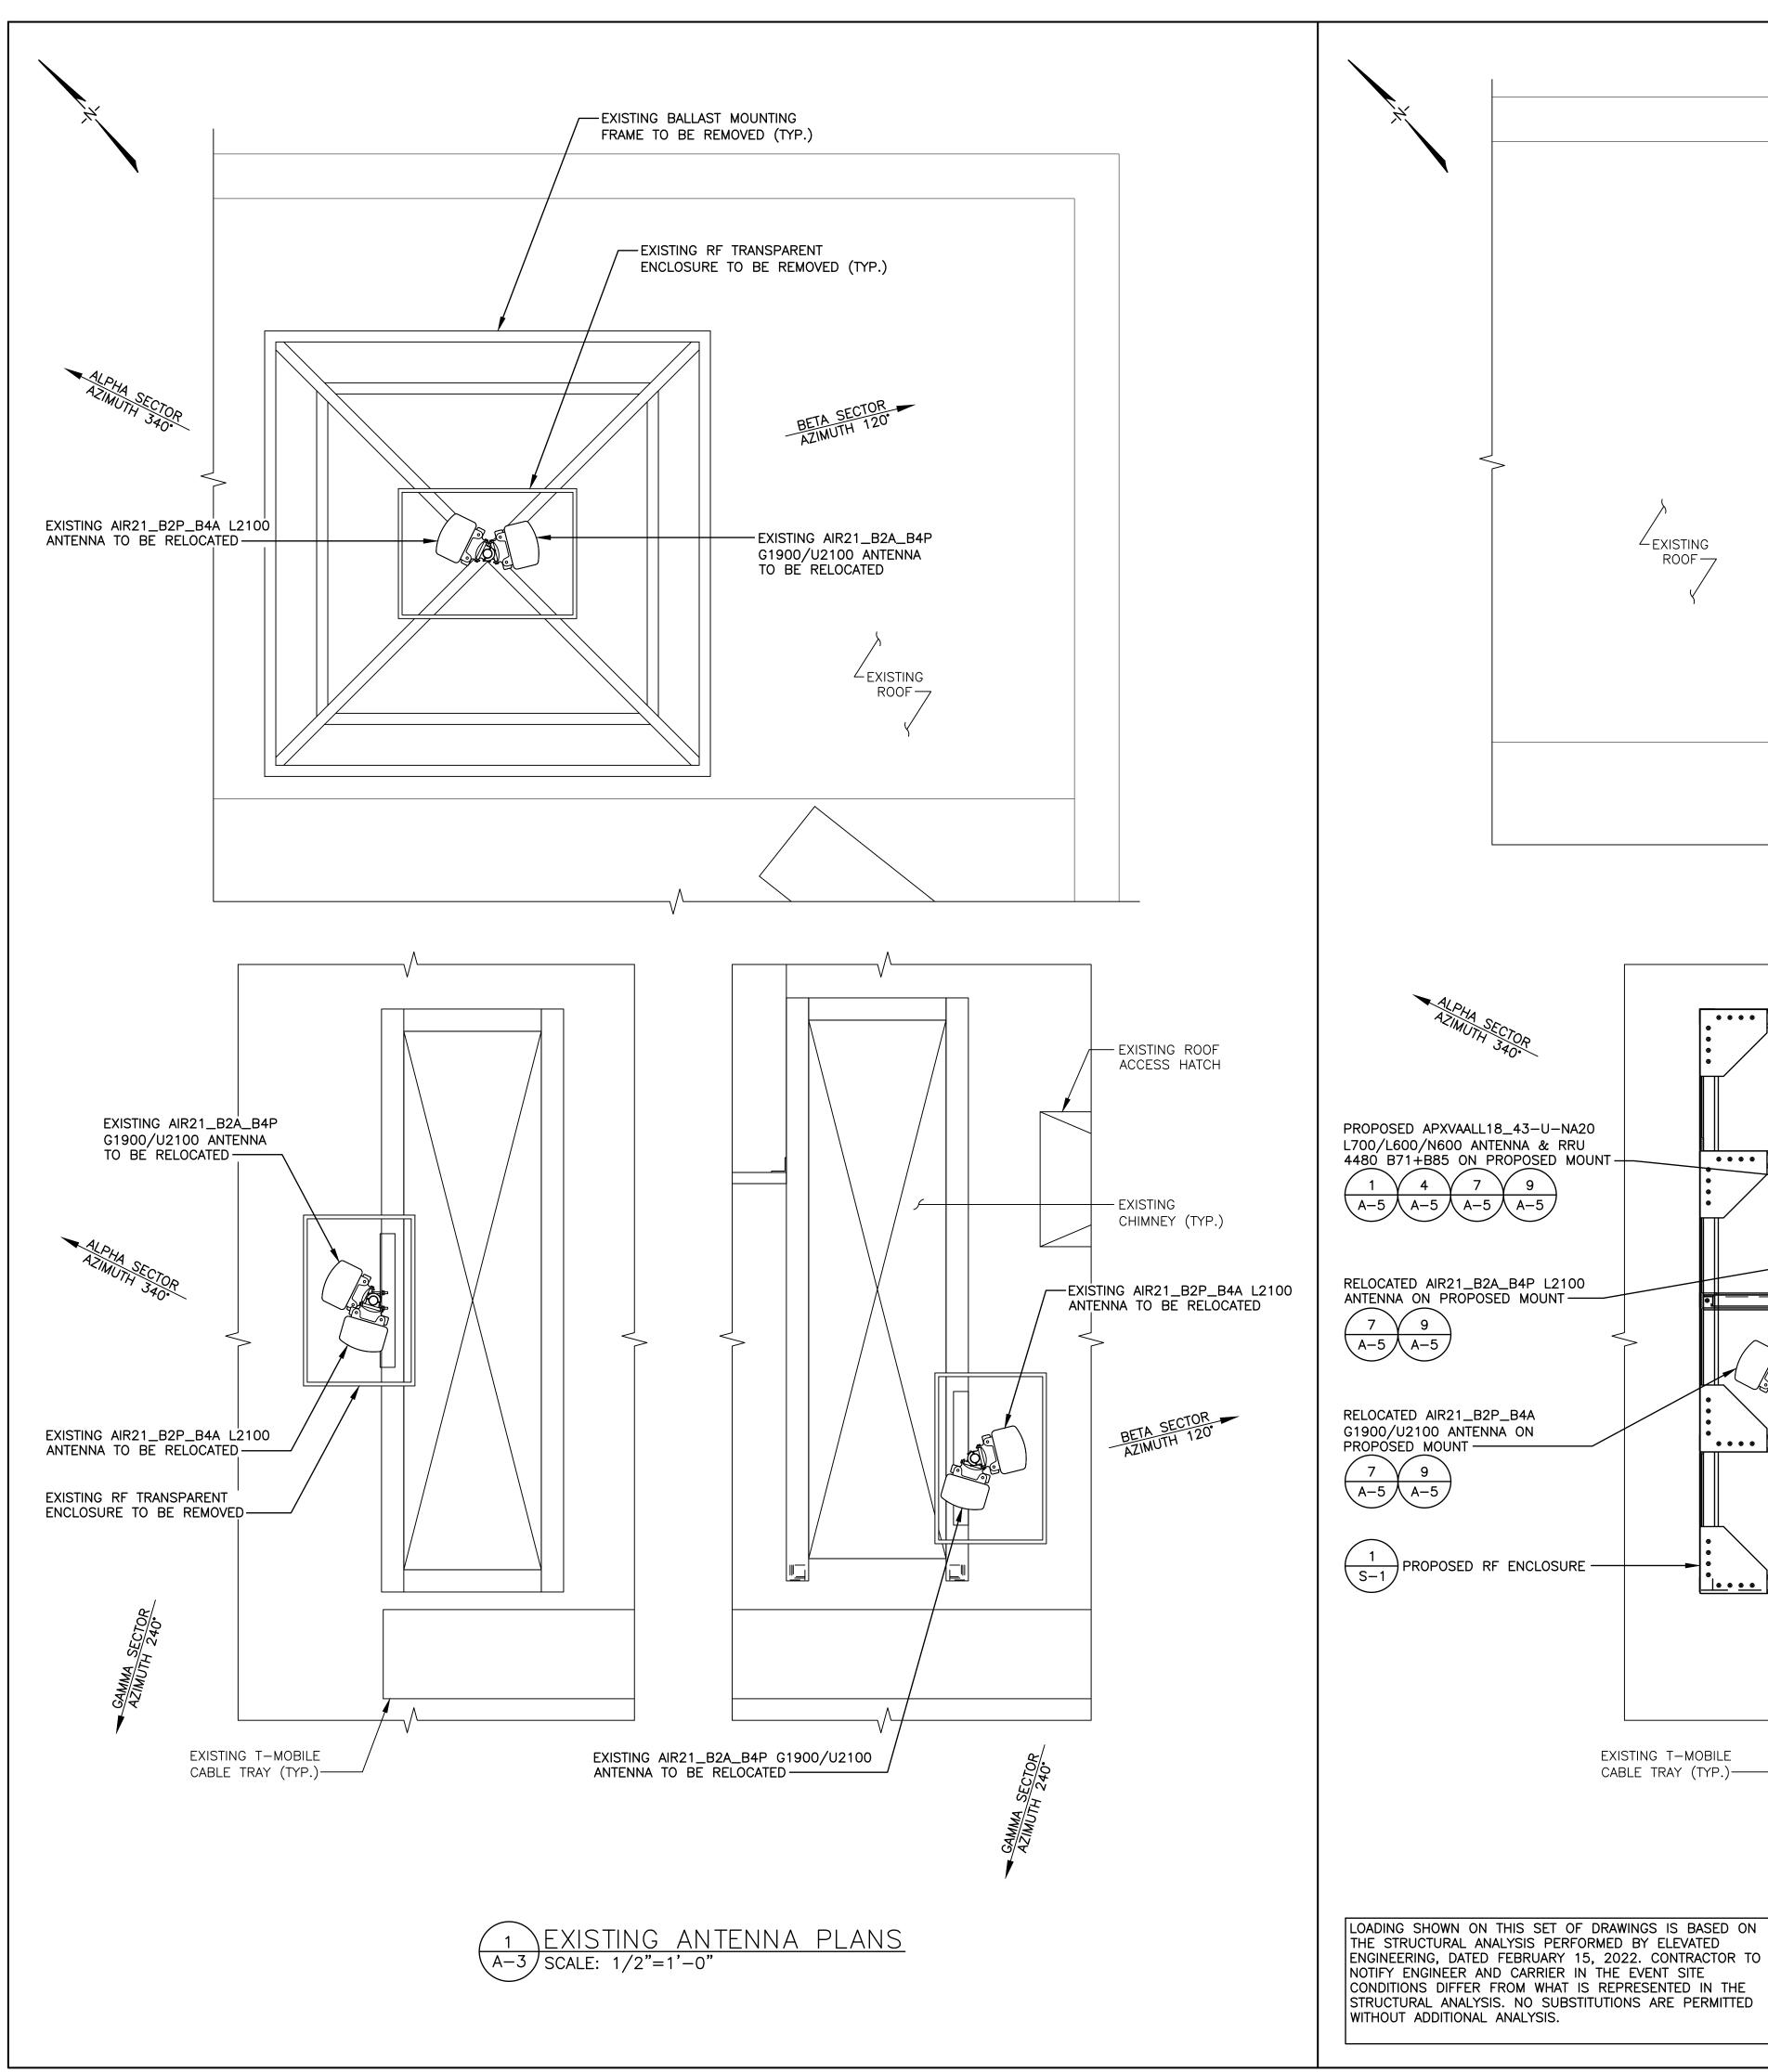

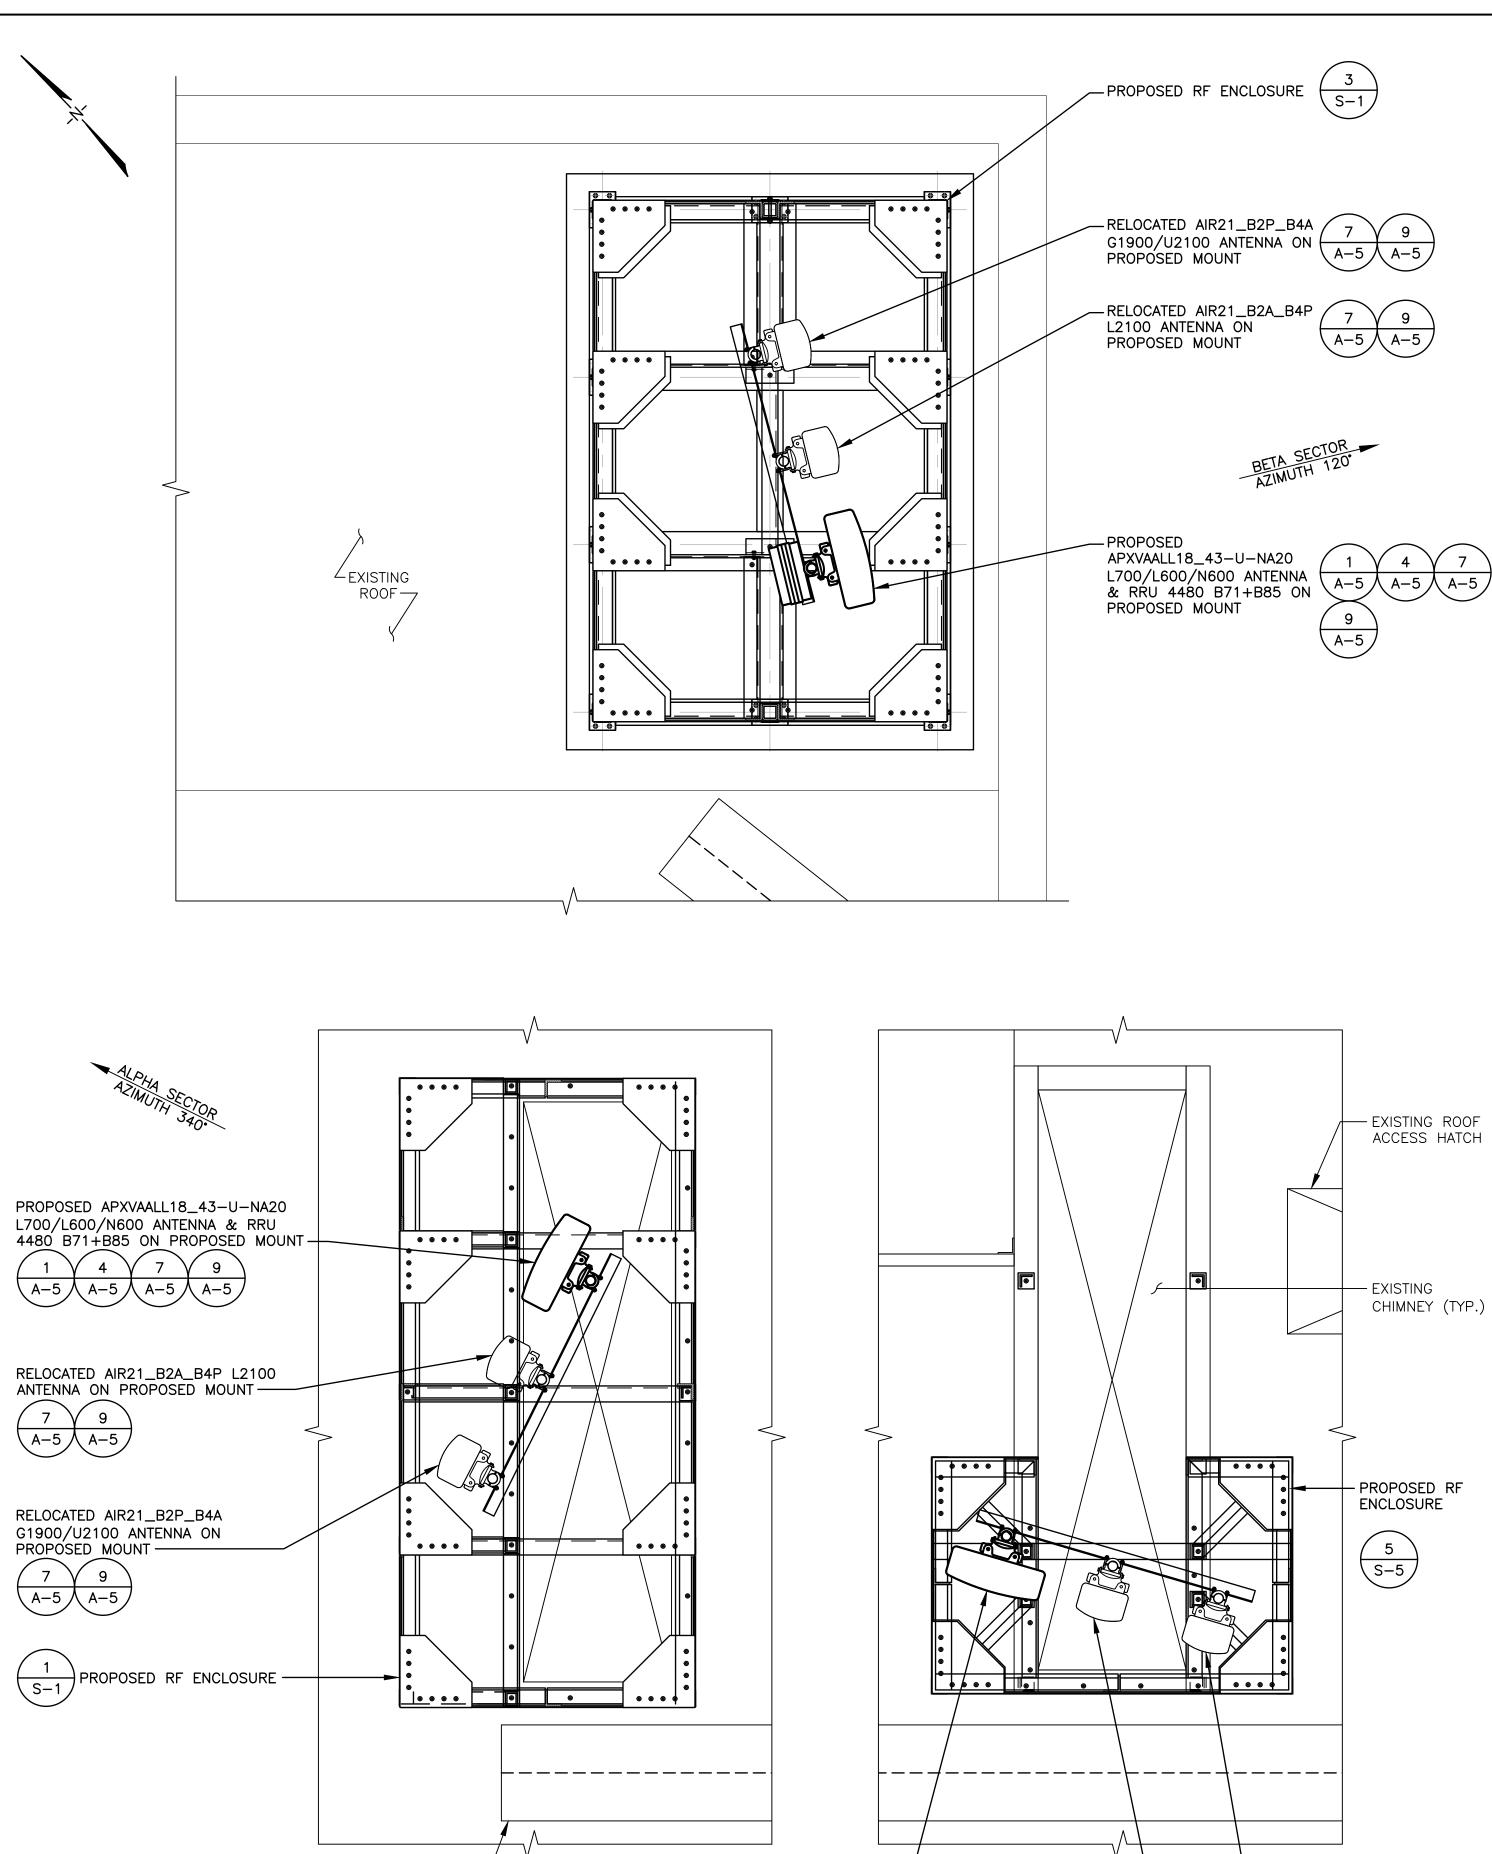

PROPOSED APXVAALL18\_43-U-NA20

4480 B71+B85 ON PROPOSED MOUNT —

2 FINAL ANTENNA PLANS A-3 SCALE: 1/2"=1'-0"

L700/L600/N600 ANTENNA & RRU

EXISTING T-MOBILE

CABLE TRAY (TYP.)-

T-MOBILE NORTHEAST LLC 15 COMMERCE WAY, SUITE B **NORTON, MA 02766** OFFICE: (508) 286-2700 FAX: (508) 286-2893

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# **SCHEDULE OF REVISIONS**


**2** 02/18/22 ISSUED AS FINAL 02/03/22 PER RF ENCLSOURE DESIGN

**o** 01/05/22 INITIAL SUBMISSION

DATE DESCRIPTION OF CHANGES

**DRAWN BY:** CJT **CHECKED BY:** NDB SCALE: AS NOTED 21046-TRN JOB NO:

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NICHOLAS D. BARILE

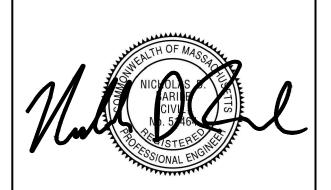PROFESSIONAL ENGINEER, MA LIC. No. 51464

4BN1531C BN531/FORRESTER PROF BLDG **37 1/2 FORRESTER ST** NEWBURYPORT, MA 01950 **ESSEX COUNTY** 

**DRAWING TITLE:** 

RELOCATED AIR21\_B2P\_B4A

PROPÓSED MOUNT


\ A-5 \ A-5 /

RELOCATED AIR21\_B2A\_B4P L2100

ANTENNA ON PROPOSED MOUNT

G1900/U2100 ANTENNA ON

**ANTENNA PLANS** 

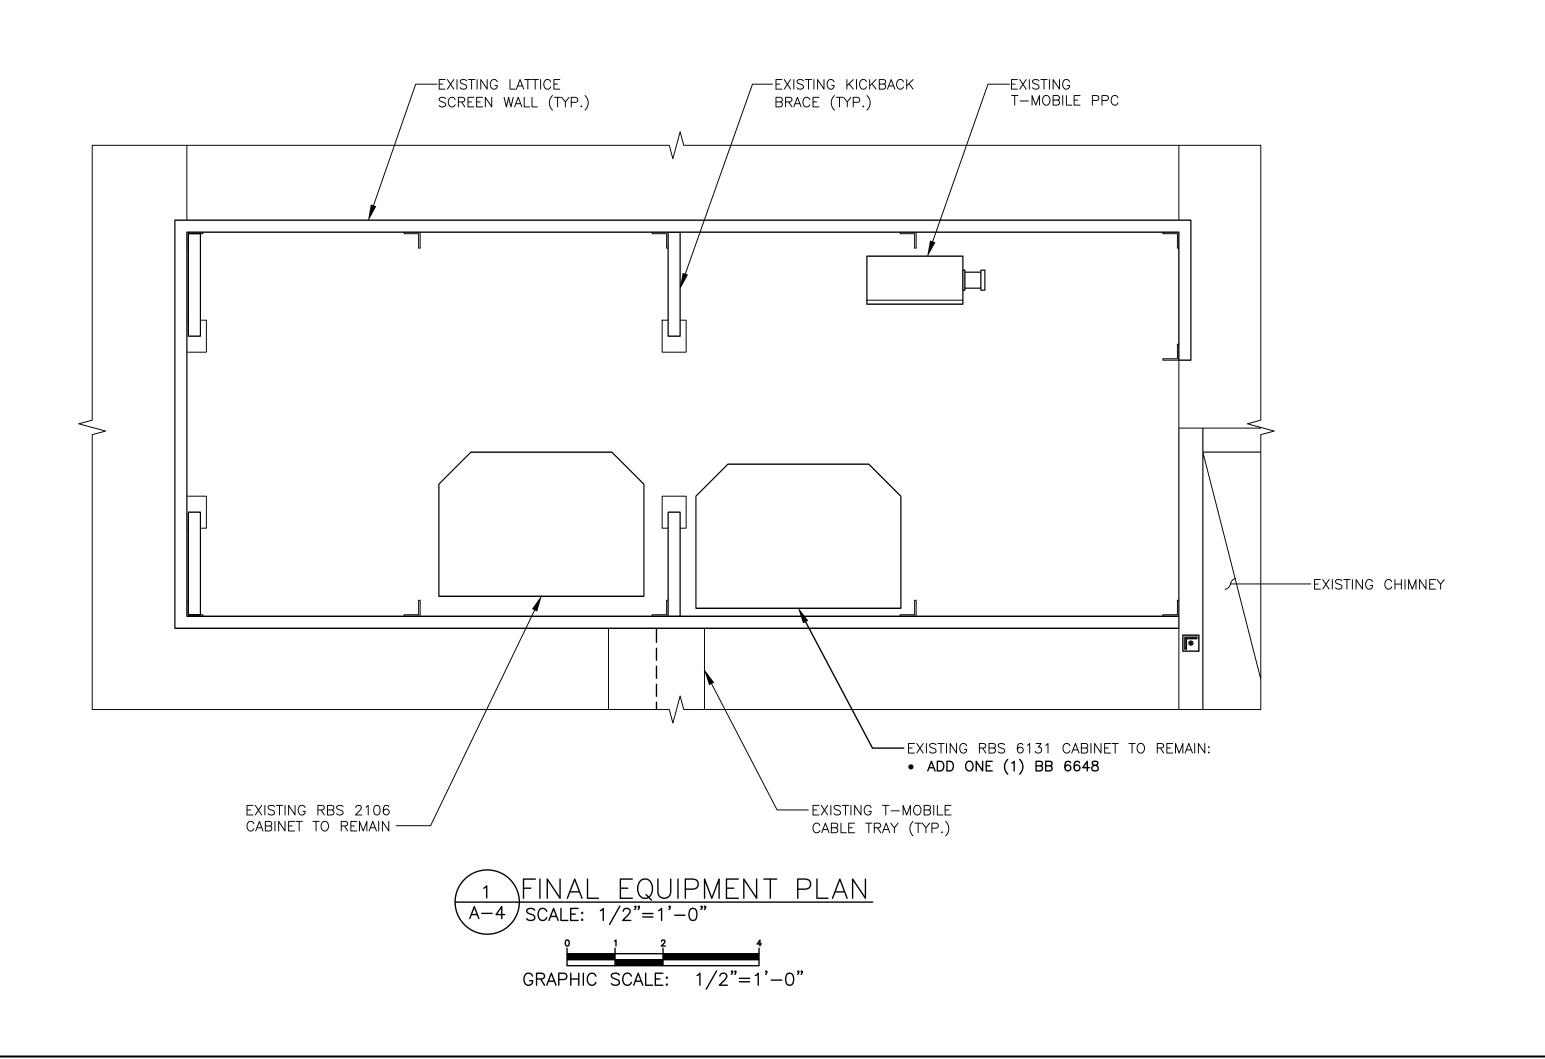

	ANTENNA INFORMATION															
	POSITION PROPOSED															
SECTOR	(FROM REAR LEFT TO RIGHT)	MODEL	QTY	MODEL	ANT. C.L.	SECTOR MARK	QTY	E-TILT	M-TILT	RRU MODEL/QUANTITY	DIPLEXER/ COMBINERS	ТМА	COAX/ FIBER QUANTITY	COAX/ FIBER	COAX/ FIBER LENGTH	HCS QTY./TYPE/LENGTH
	R1	AIR21 KRC118023-1_B2A_B4P	1	AIR21 KRC118023-1_B2A_B4P	47'-0"	G1900/U2100	1	2/2	0	-	-	GENERIC TWIN STYLE 1B-AWS	1 2	FIBER JUMPER %" COAX	10' 46'	
ALPHA 340°	R2	AIR21 KRC118023-1_B2P_B4A	1	AIR21 KRC118023-1_B2P_B4A	47'-0"	L2100	1	0/2	0	-	-	-	1	FIBER JUMPER	10'	(1) 3x6 HCS 85' (1) 6x24 HCS 85'
	R3	_	1	APXVAALL18_43-U-NA20	47'-0"	N600/L700/ L600	1	4/4/0/0	0	(1) 4480 B71+B85	-	-	4 2	COAX JUMPER FIBER JUMPER	10' 10'	
	W1	AIR21 KRC118023-1_B2A_B4P	1	AIR21 KRC118023-1_B2A_B4P	47'-0"	G1900/U2100	1	2/2	0	-	-	GENERIC TWIN STYLE 1B-AWS	1 2	FIBER JUMPER %" COAX	10' 46'	
BETA 120°	W2	AIR21 KRC118023-1_B2P_B4A	1	AIR21 KRC118023-1_B2P_B4A	47'-0"	L2100	1	0/2	0	-	-	-	1	FIBER JUMPER	10'	(1) 3x6 HCS 110' (1) 6x24 HCS 110'
	W3	_	1	APXVAALL18_43-U-NA20	47'-0"	N600/L700/ L600	1	4/4/0/0	0	(1) 4480 B71+B85	-	-	4 2	COAX JUMPER FIBER JUMPER	10' 10'	
	B1	AIR21 KRC118023-1_B2A_B4P	1	AIR21 KRC118023-1_B2A_B4P	47'-0"	G1900/U2100	1	2/2	0	-	-	GENERIC TWIN STYLE 1B-AWS	1 2	FIBER JUMPER %" COAX	10' 46'	
GAMMA 240°	B2	AIR21 KRC118023-1_B2P_B4A	1	AIR21 KRC118023-1_B2P_B4A	47'-0"	L2100	1	0/2	0	_	-	-	1	FIBER JUMPER	10'	(1) 3x6 HCS 45' (1) 6x24 HCS 45'
	В3	_	1	APXVAALL18_43-U-NA20	47'-0"	N600/L700/ L600	1	4/4/0/0	0	(1) 4480 B71+B85	-	-	4 2	COAX JUMPER FIBER JUMPER	10' 10'	

AT TIME OF CONSTRUCTION, CONTRACTOR TO VERIFY AZIMUTHS OF EXISTING ANTENNAS. IF DIFFERENT FROM RFDS, PLEASE NOTIFY THE RF ENGINEER AND CONSTRUCTION MANAGER WITH ACTUAL AZIMUTH TO ENSURE T-MOBILE'S DATABASE IS ACCURATE AND UP-TO-DATE.

INFORMATION SHOWN PROVIDED ON T-MOBILE RFDS DATE 11/30/21.

# T - Mobile

T-MOBILE NORTHEAST LLC 15 COMMERCE WAY, SUITE B NORTON, MA 02766 OFFICE: (508) 286-2700 FAX: (508) 286-2893

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# 

DESCRIPTION OF CHANGES

CJT

CHECKED BY:	NDB					
SCALE:	AS NOTED					
JOB NO:	21046-TRN					

REV. NO. DATE

DRAWN BY:

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NICHOLAS D. BARILE

PROFESSIONAL ENGINEER, MA LIC. No. 51464


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ESSEX COUNTY


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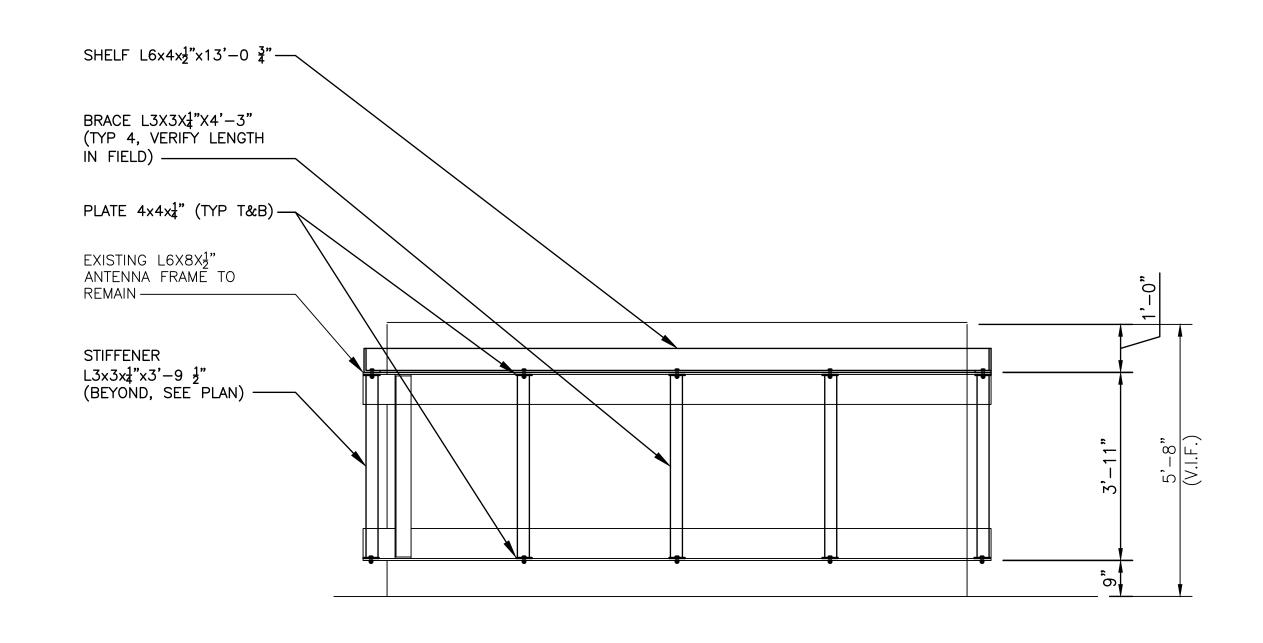
FINAL EQUIPMENT
PLAN &
ANTENNA SCHEDULE

DRAWING SHEET:

**A-4** 



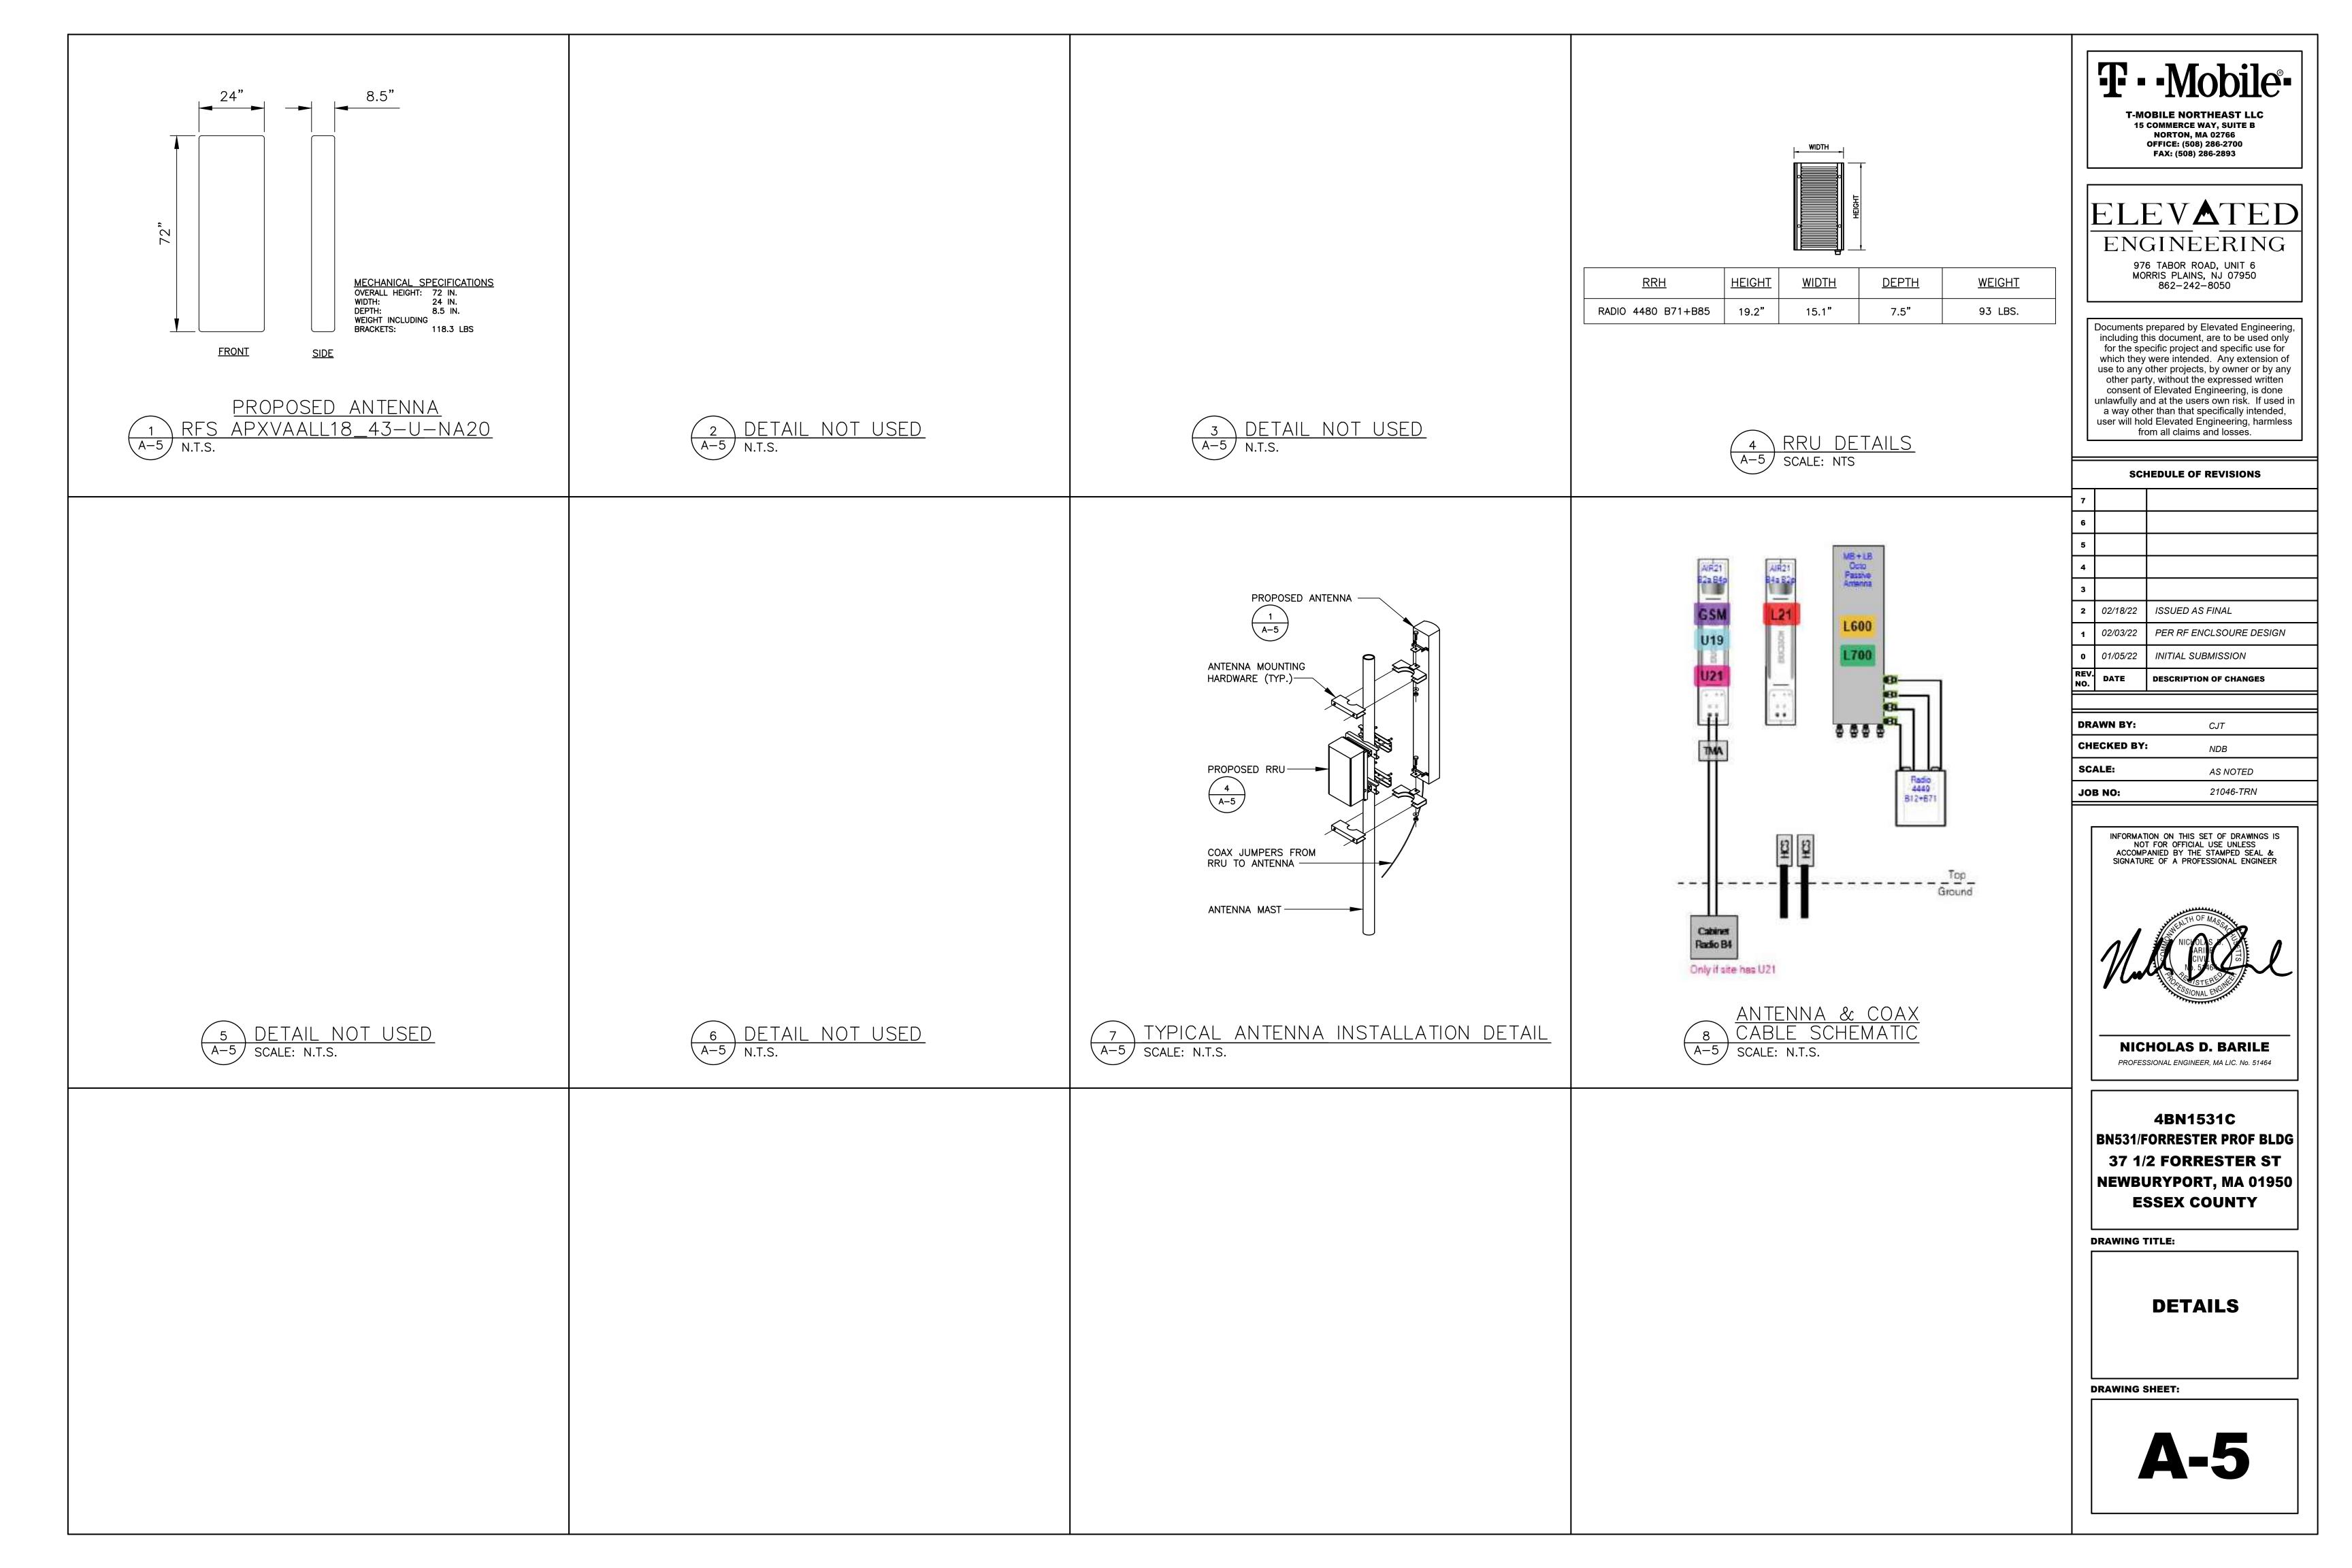


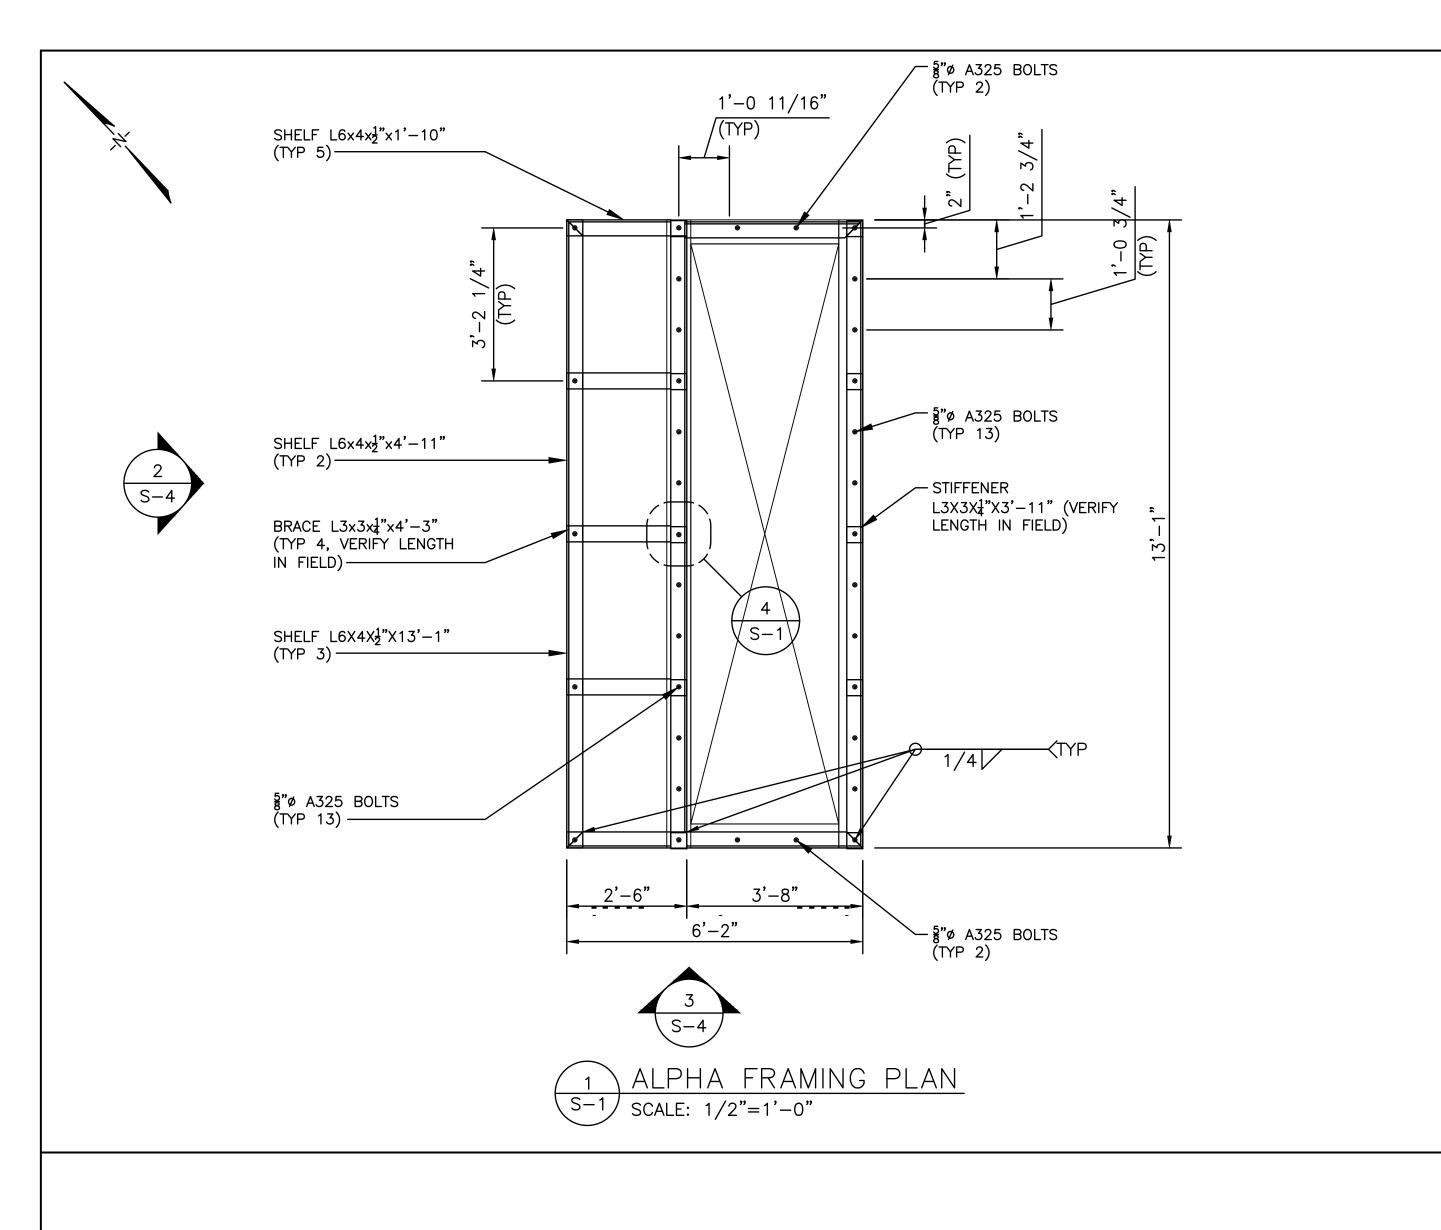

2 ALPHA FRAMING PLAN S-1) SCALE: 1/2"=1'-0"

# STIFFENER L3x3x½"x3'-9½" (TYP, V.I.F.) SHELF L6x4x½"x7'-6" PLATE 4x4x½" (TYP T&B) STIFFENER L3x3x½"x3'-9½" (TYP, V.I.F.) BRACE L3X3X½"x4'-3" (TYP 4, VERIFY LENGTH IN FIELD) EXISTING L6X8X½" ANTENNA FRAME TO REMAIN

ELEVATION VIEW

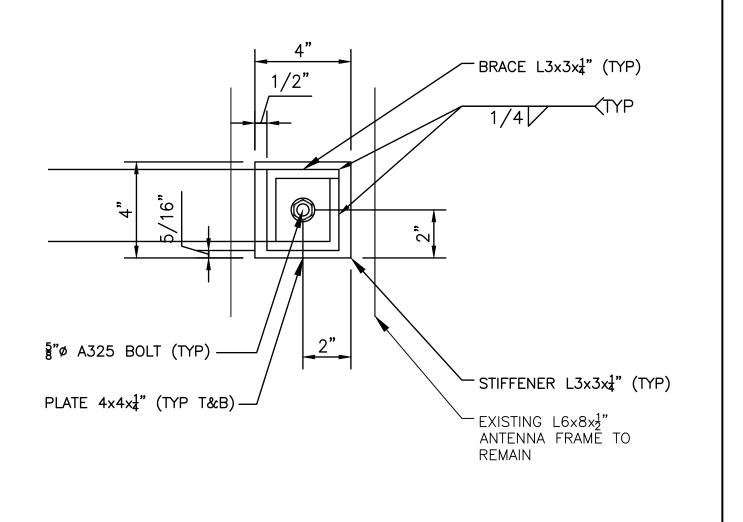

BRACE DETAIL PLAN VIEW

S-1 SCALE: N.T.S.

## DESIGN INFORMATION AND GENERAL REQUIREMENTS

a. DESIGN CONFORMS TO THE 2018 INTERNATIONAL BUILDING CODE

b. SPECIFICATIONS FOR STRUCTURAL STEEL BUILDINGS, ANSI/AISC 360-05

1.2 SEISMIC DESIGN DATA
a. AS PER MODIFICATIONS TO 1990 UNIFORM BUILDING CODE OUTLINED IN THE TITLE 27 VOLUME 2 REFERENCE STANDARD RS 9-6 EARTHQUAKE LOADS, THIS PROPOSED CONSTRUCTION IS EXEMPT FROM CONSIDERATION OF SEISMIC LOADING. IT REQUIRES NO NEW FOUNDATION OR MODIFICATIONS TO EXISTING FOUNDATIONS WITH THE TOTAL PROPOSED ENLARGEMENTS NOT EXCEEDING MORE THAN 60% OF THE VALUE OF THE BUILDING.

1.3 MISCELLANEOUS

a. CONTRACTOR SHALL VERIFY ALL DIMENSIONS, ELEVATIONS AND EXISTING CONDITIONS PRIOR TO PROCEEDING WITH THE WORK.

2. STRUCTURAL STEEL

STRUCTURAL STEEL BUILDINGS, ANSI/AISC 360-05"
e. WELDING SHALL CONFORM TO "STRUCTURAL WELDING CODE - STEEL,
AWS D1.1-04"

f. THE FABRICATOR SHALL FURNISH CHECKED SHOP AND ERECTION DRAWINGS TO THE ENGINEER, AND OBTAIN APPROVAL PRIOR TO FABRICATING ANY STRUCTURAL STEEL. SHOP DRAWINGS SHALL CONFORM TO "DETAILING FOR STEEL CONSTRUCTION, 2ND EDITION"

2.2 CONNECTIONS
a. SHOP CONNECT

a. SHOP CONNECTIONS MAY BE BOLTED OR WELDED.
 b. FIELD CONNECTIONS SHALL BE BOLTED WITH A325—N BOLTS AND HARDENED WASHERS, (INSTALLED SNUG TIGHT) UNLESS OTHERWISE

SPECIFIED OR IF WELDED CONNECTIONS ARE NOTED ON DRAWINGS.

c. CONNECTIONS NOT SHOWN ON DRAWINGS SHALL BE DESIGNED BY THE STEEL FABRICATOR AND SHALL BE DESIGNED IN ACCORDANCE WITH AISC "SPECIFICATIONS FOR STRUCTURAL JOINTS USING ASTM A325 OR A490 BOLTS" AND "AISC CODE OF STANDARD PRACTICE FOR STEEL BUILDINGS AND BRIDGES." ALL "FRAMED BEAM CONNECTIONS" SHALL BE SIZED FOR ONE HALF THE MAXIMUM TOTAL UNIFORM LOAD AS PUBLISHED IN "STEEL CONSTRUCTION MANUAL, 13TH EDITION, AMERICAN INSTITUTE OF STEEL CONSTRUCTION.

e. DO NOT FIELD CUT OR ALTER STRUCTURAL MEMBERS WITHOUT PRIOR WRITTEN APPROVAL OF ENGINEER.

2.3 FINISHES

- a. STRUCTURAL STEEL SHALL BE HOT DIP GALVANIZED AFTER FABRICATION
- PER ASTM A123.

  b. BOLTS AND NUTS SHALL BE HOT DIP GALVANIZED PER ASTM A153.

  c. ALL SURFACES DAMAGED BY FIELD WELDING OR CUTTING SHALL BE PAINTED WITH ZINC RICH PAINTS.

F--Mobile-

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# SCHEDULE OF REVISIONS

7		
6		
5		
4		
3		
2	02/18/22	ISSUED AS FINAL
1	02/03/22	PER RF ENCLSOURE DESIGN
	2 / /2 = /2 2	

0 01/05/22 INITIAL SUBMISSION

REV. NO. DATE DESCRIPTION OF CHANGES

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NICHOLAS D. BARILE


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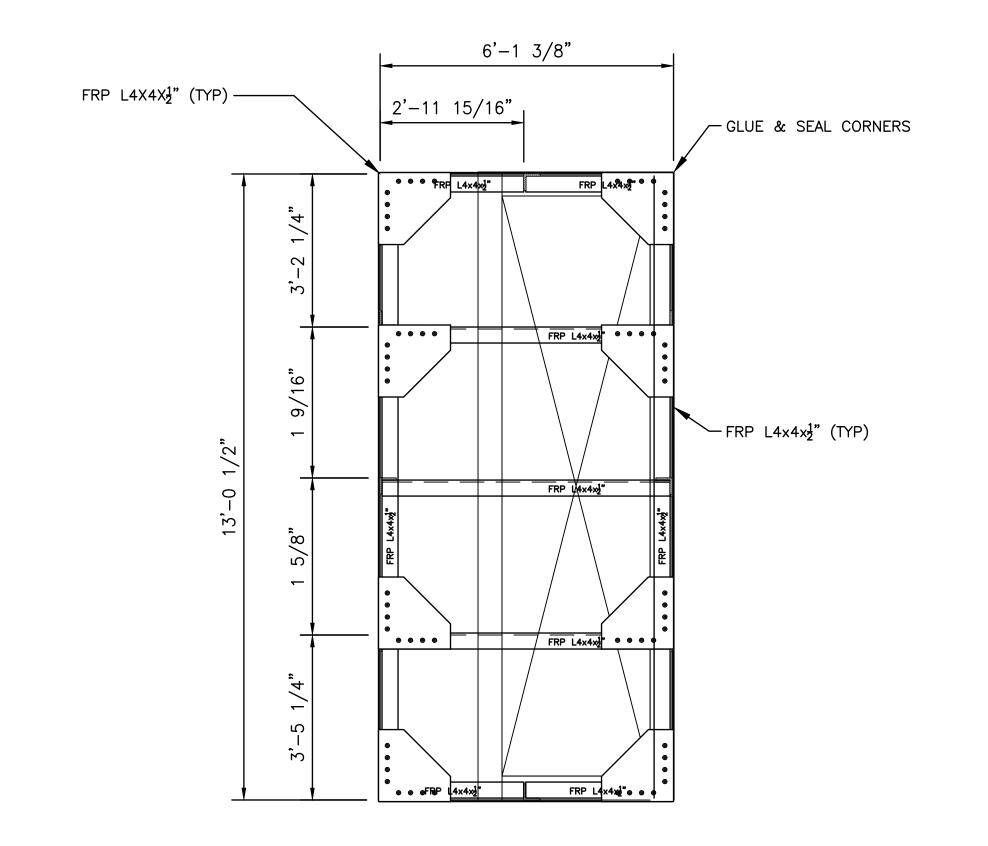
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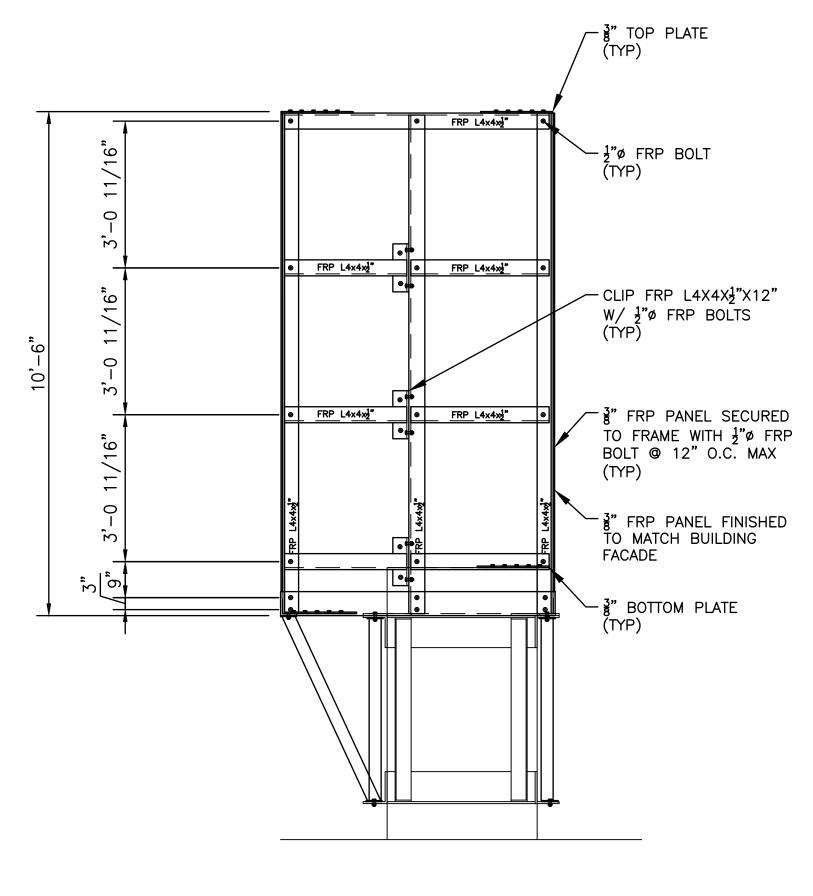
ALPHA FRAMING PLAN, DETAILS & NOTES

DRAWING SHEET:






2 ALPHA RF ENCLOSURE BOTTOM PLAN VIEW S-2 SCALE: 1/2"=1'-0"

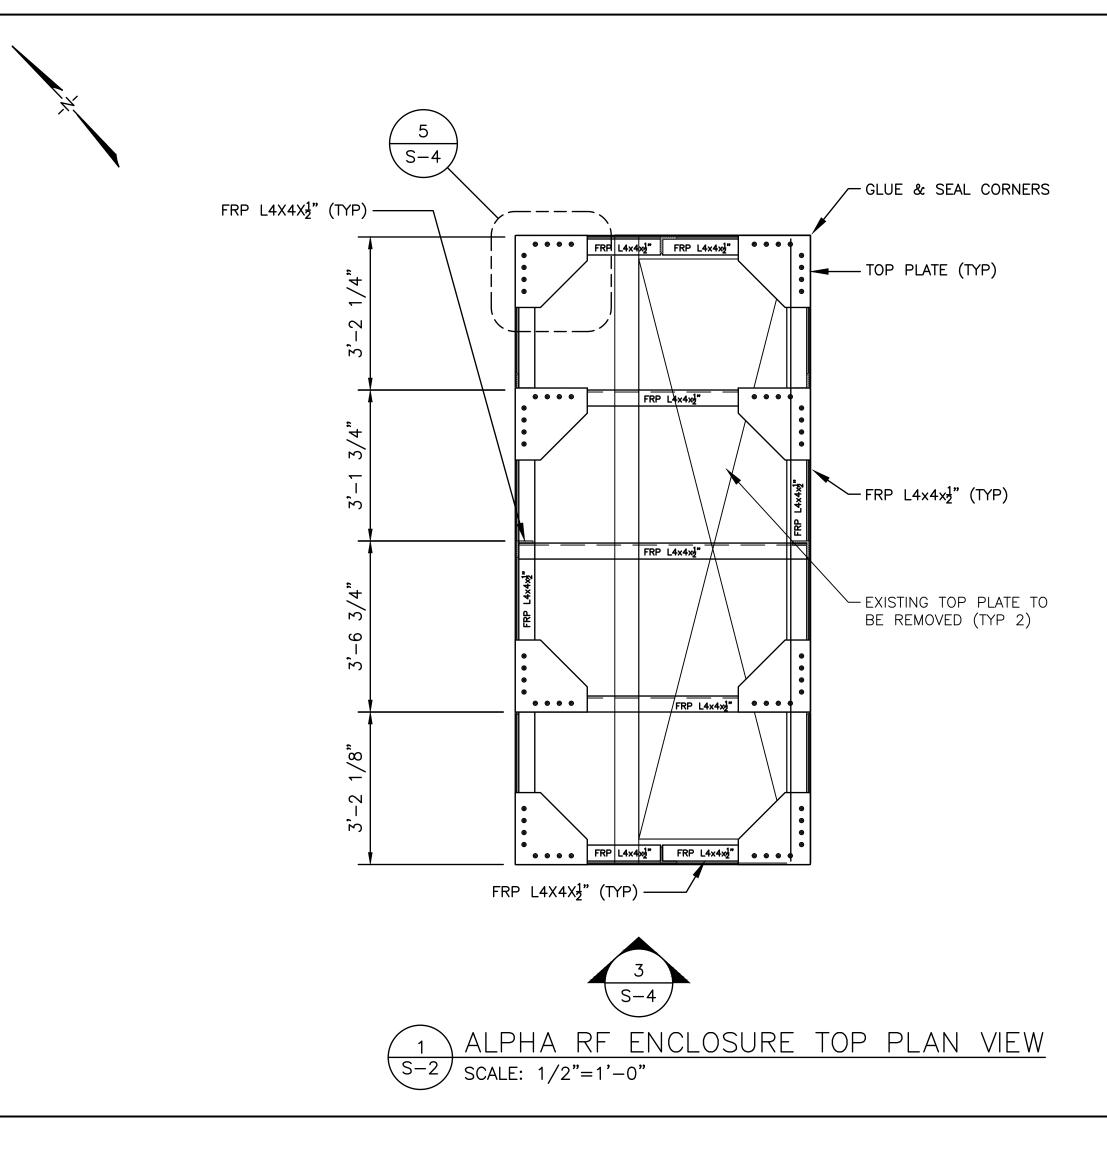

3 ELEVATION VIEW S-2 SCALE: N.T.S.

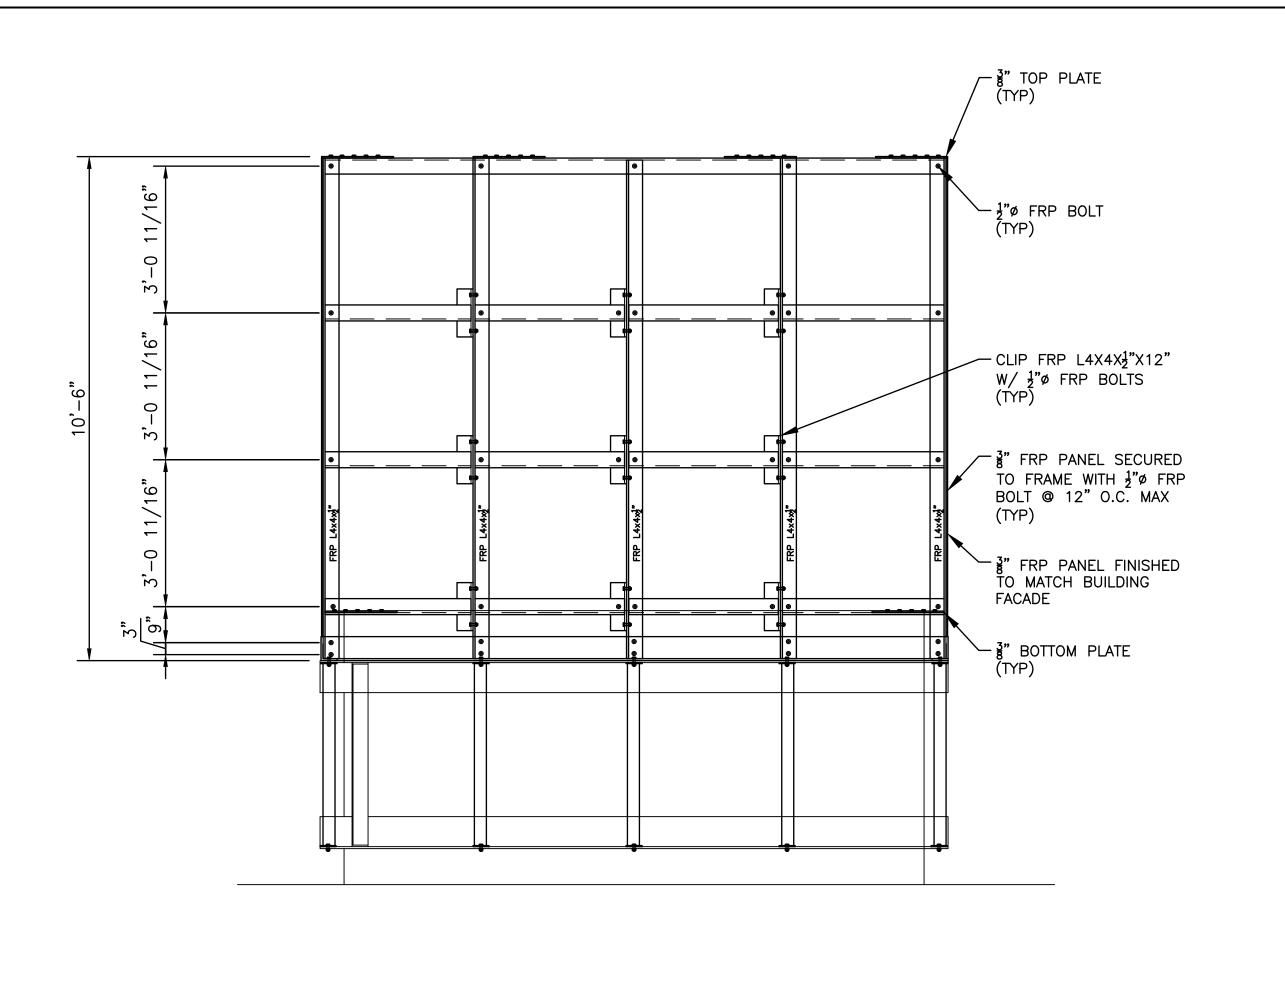

3 ELEVATION VIEW S-2 SCALE: N.T.S.

**F**--Mobile

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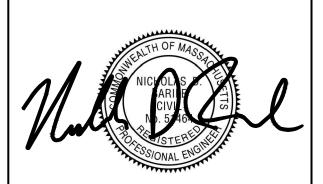
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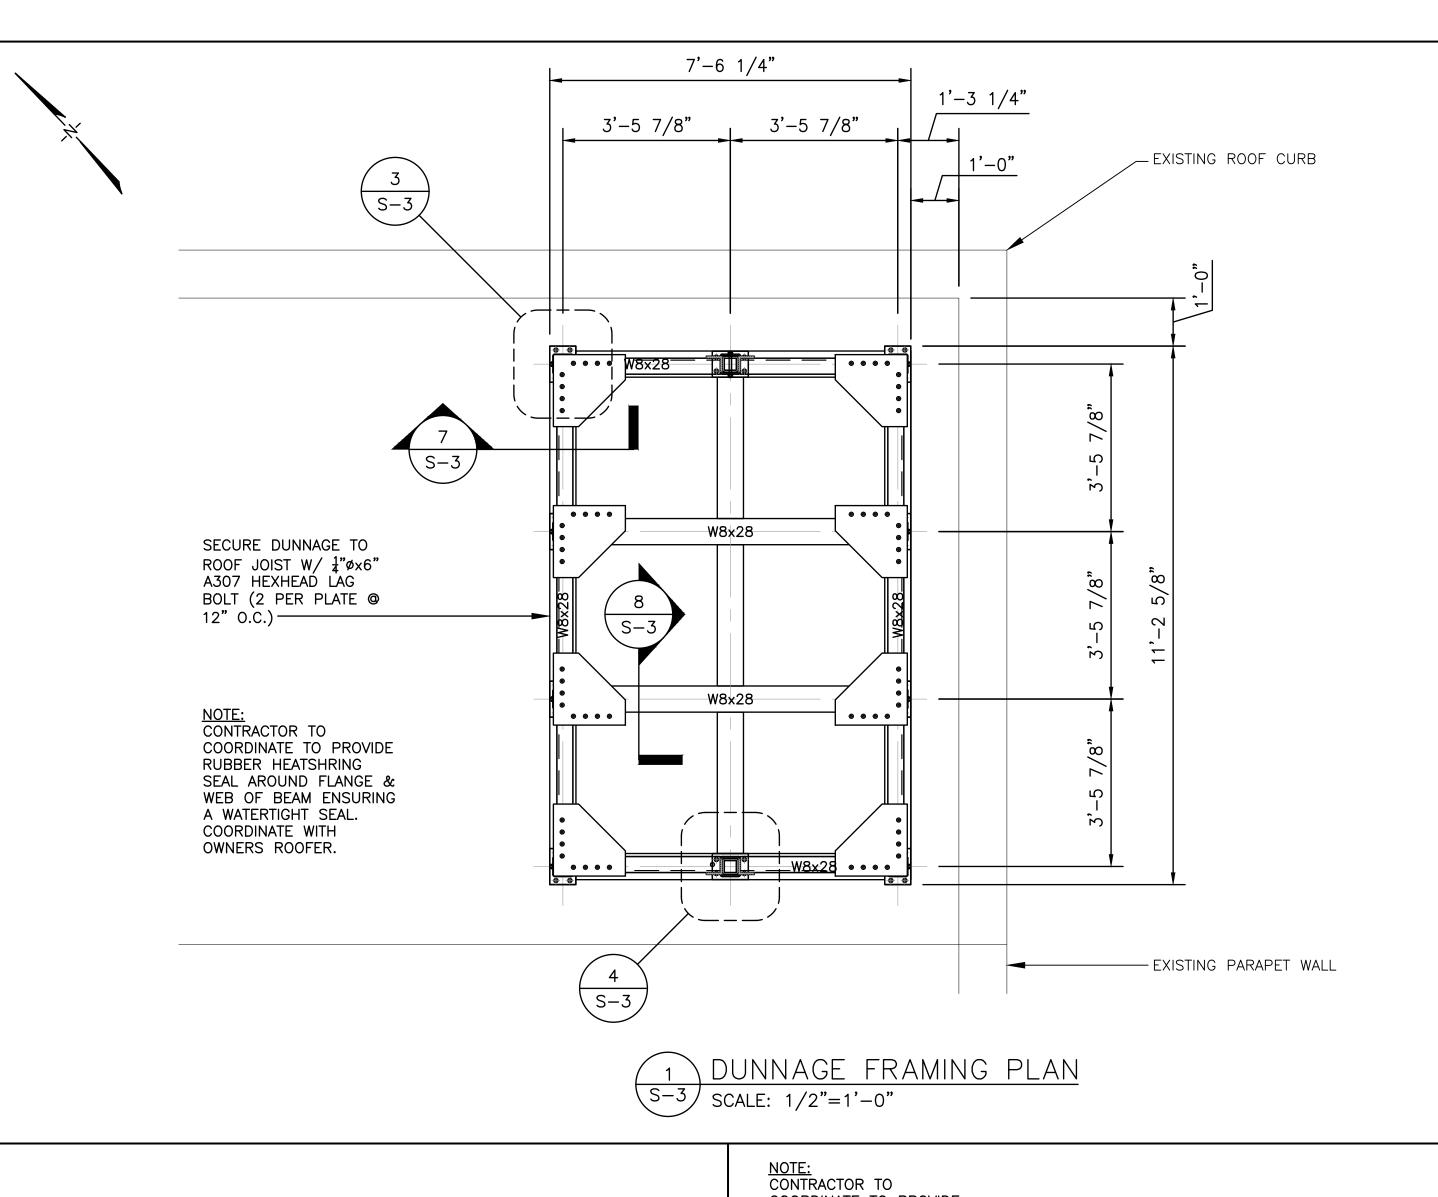
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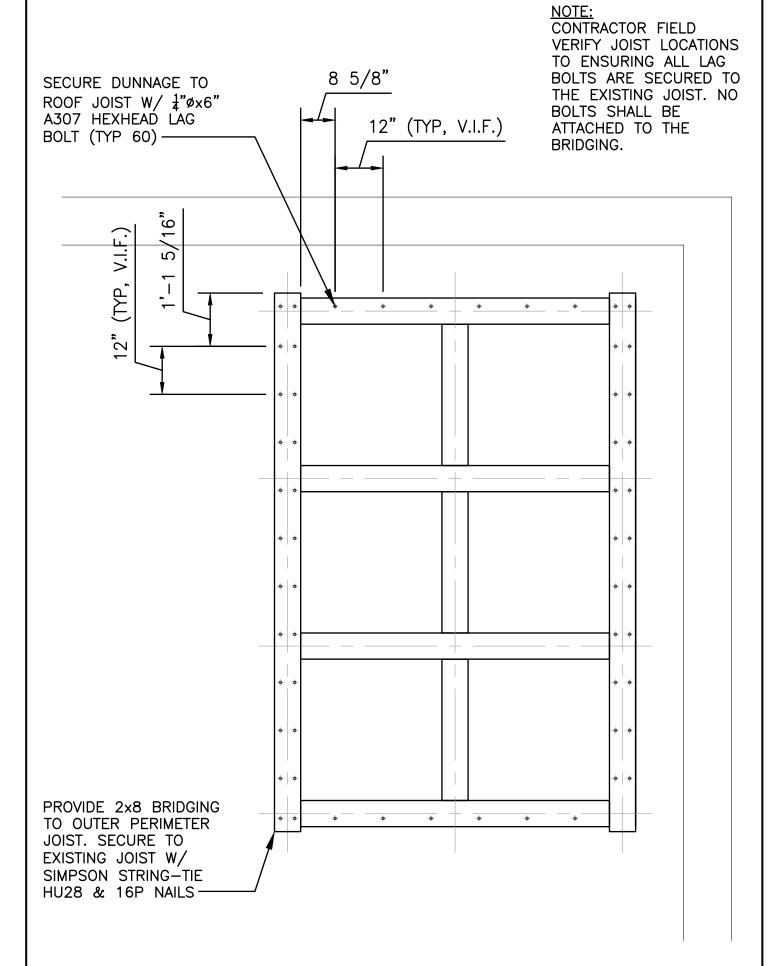
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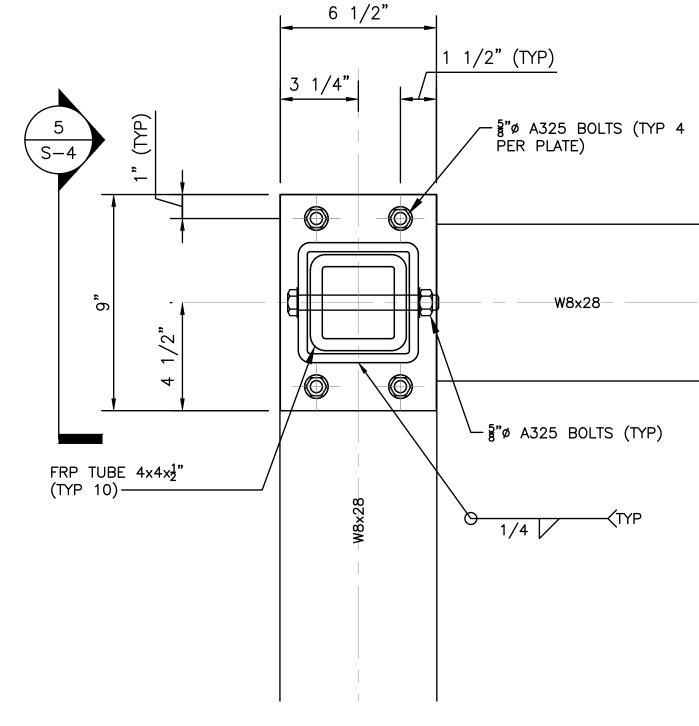
DRAWING TITLE:

ALPHA RF ENCLOSURE & DETAILS

DRAWING SHEET:







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**o** 01/05/22

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02/03/22

T-MOBILE NORTHEAST LLC

15 COMMERCE WAY, SUITE B

**NORTON, MA 02766** 

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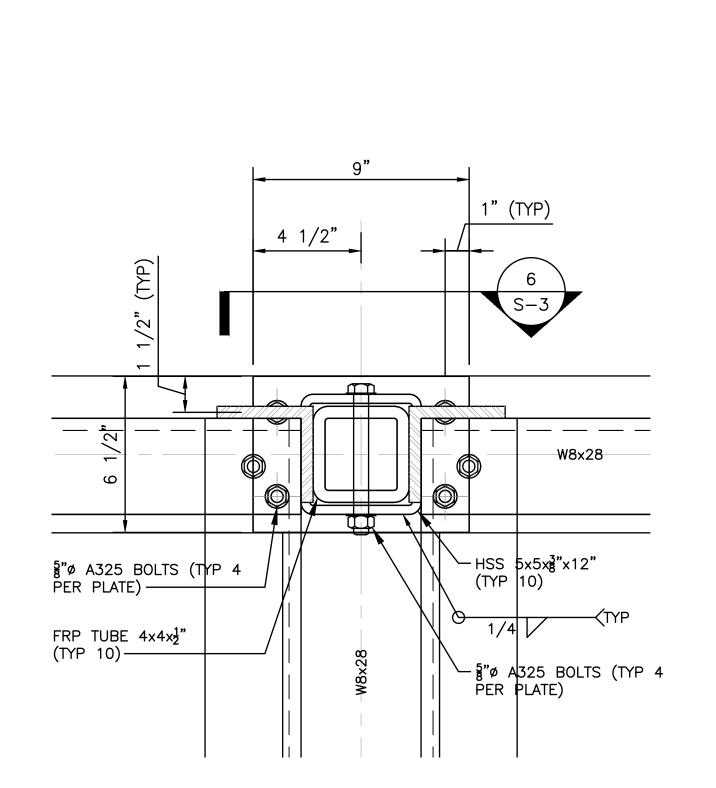
PER RF ENCLSOURE DESIGN

2 DUNNAGE BOLT HOLE PATTERN PLAN

S-3 SCALE: 1/2"=1'-0"

3 BASE PLATE PLAN VIEW


S-3 SCALE: N.T.S.





BASE PLATE PLAN VIEW


 $\left( S-3\right)$ 

SCALE: N.T.S.

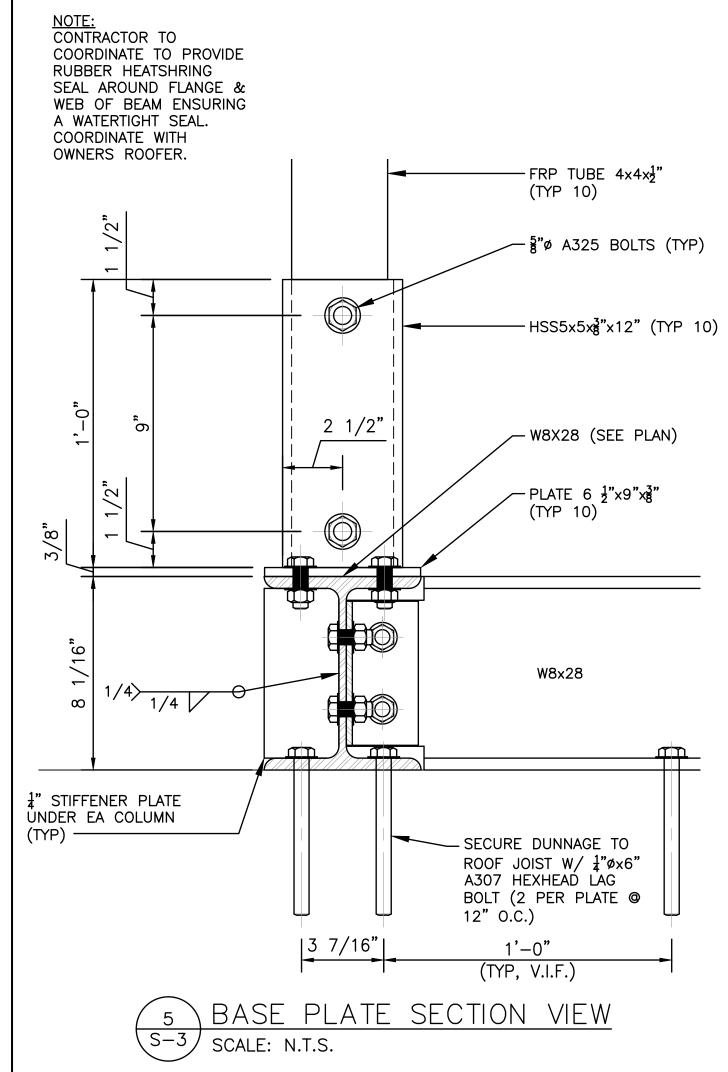

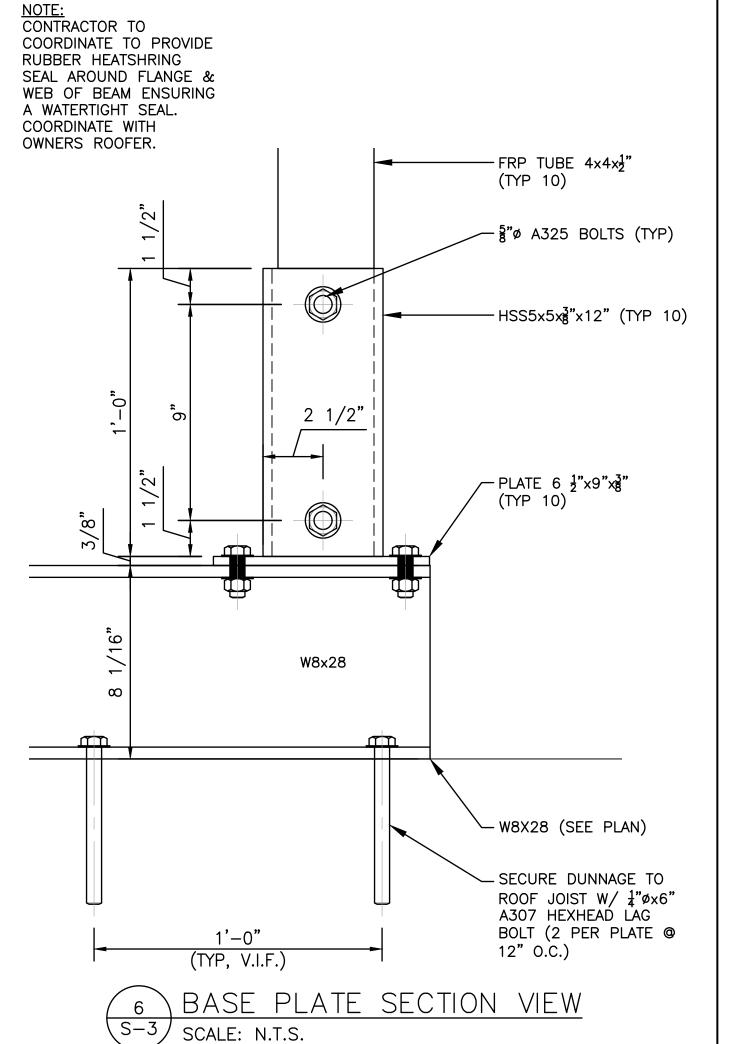

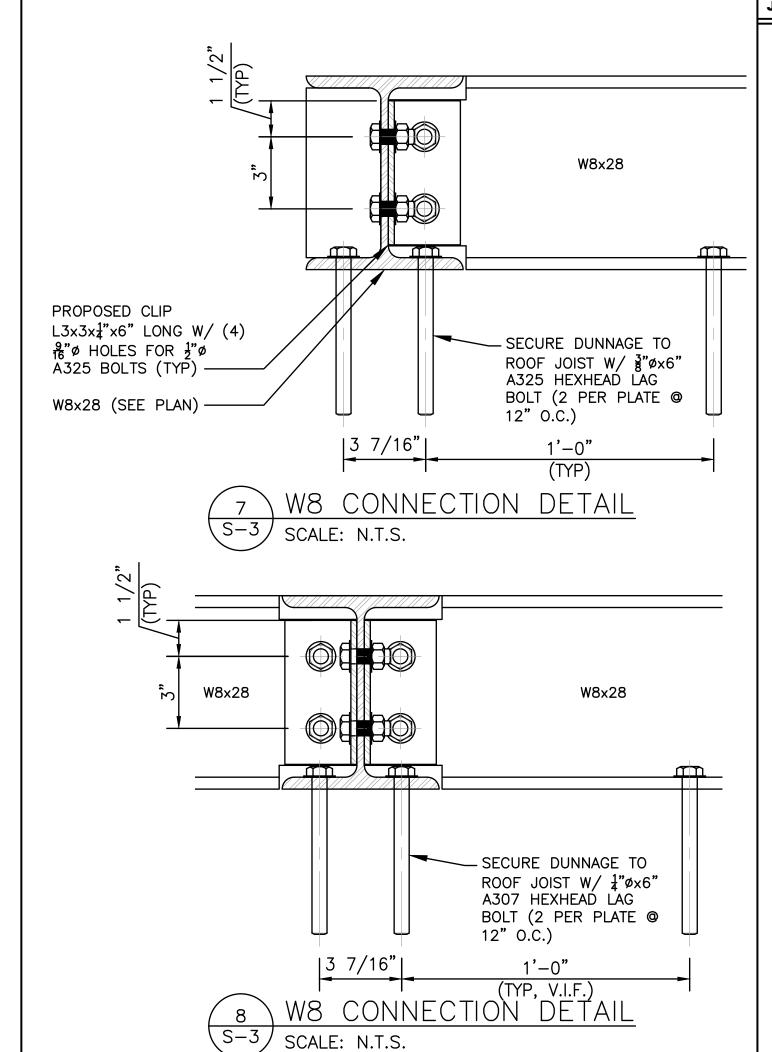

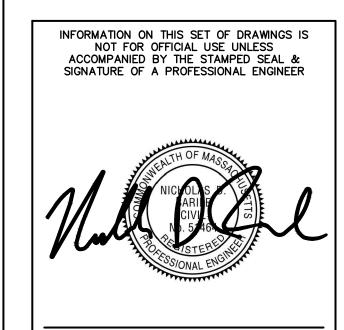


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ESSEX COUNTY

DRAWING TITLE:

BETA FRAMING PLAN & DETAILS

DRAWING SHEET:

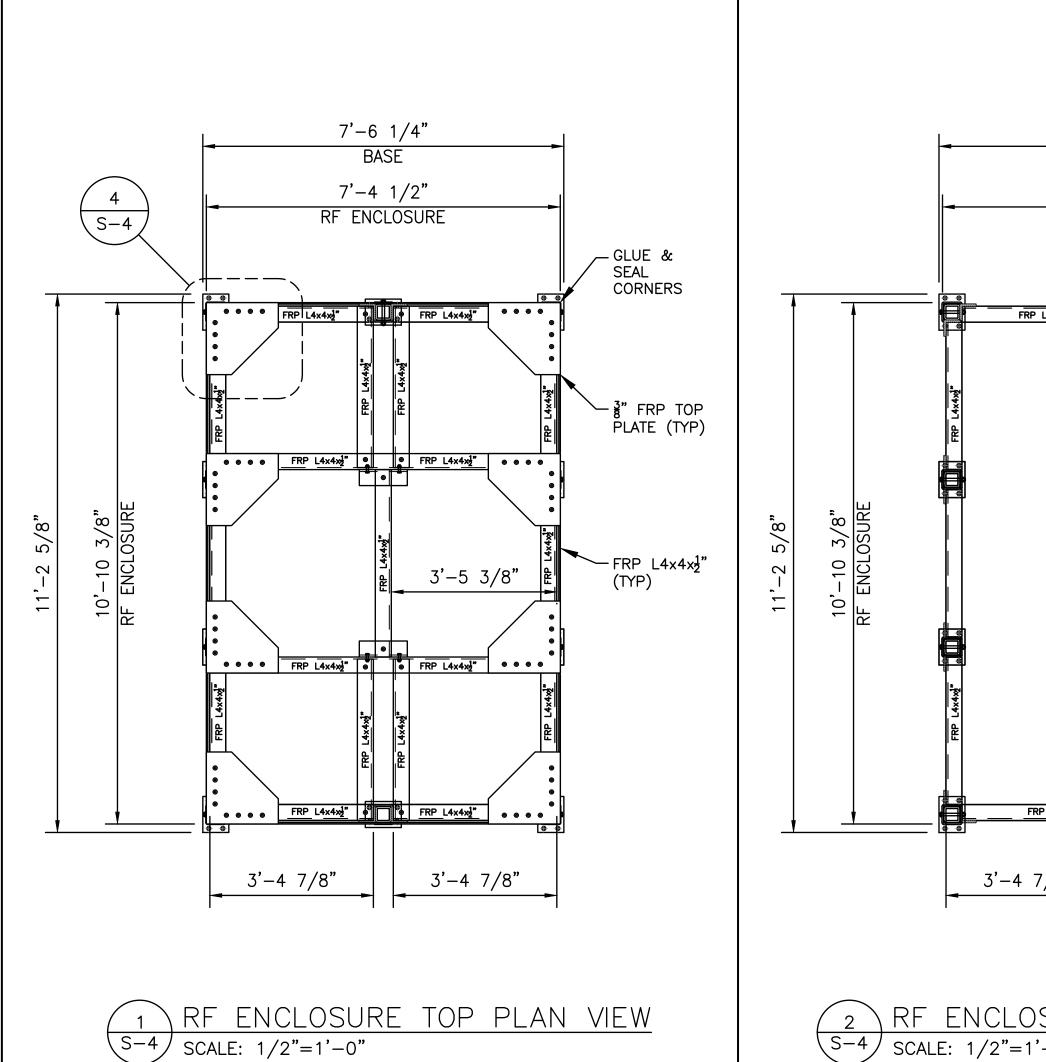

FRP\_L4x4x2" @

FRP\_L4x4x½" ●

FRP\_L4x4x½" @

FRP L4x4x½" @

15/16" 3'-3 3/16"

9

● FRP L4x4x½" ●

● FRP\_L4x4x½" ●

FRP\_L4x4x½" @


6 RF ENCLOSURE ELEVATION SCALE: 1/2"=1'-0"

● FRP\_L4x4x½" ●

● FRP\_L4x4x½"

● FRP L4x4x½"

FRP\_L4x4<u>x3</u>"

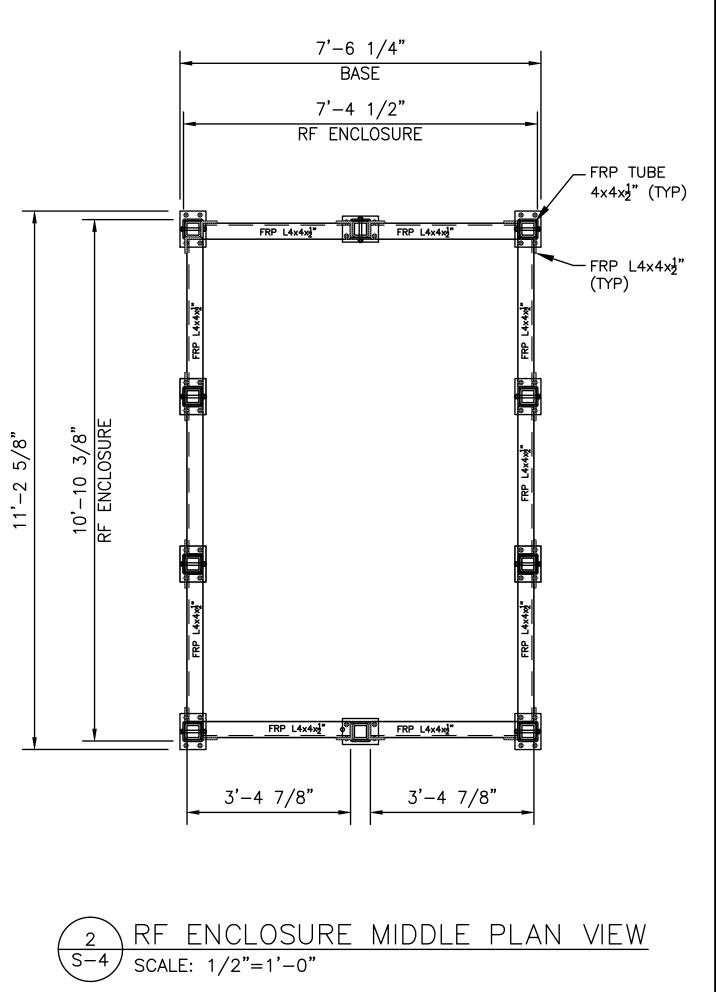

FRP TOP PLATE

 $\frac{1}{2}$ "ø FRP BOLT (TYP)

" FRP PANEL SECURED

TO FRAME WITH 10 FRP


FRP PANEL FINISHED

TO MATCH BUILDING


FRP BOTTOM PLATE

FACADE


BOLT @ 12" O.C. MAX

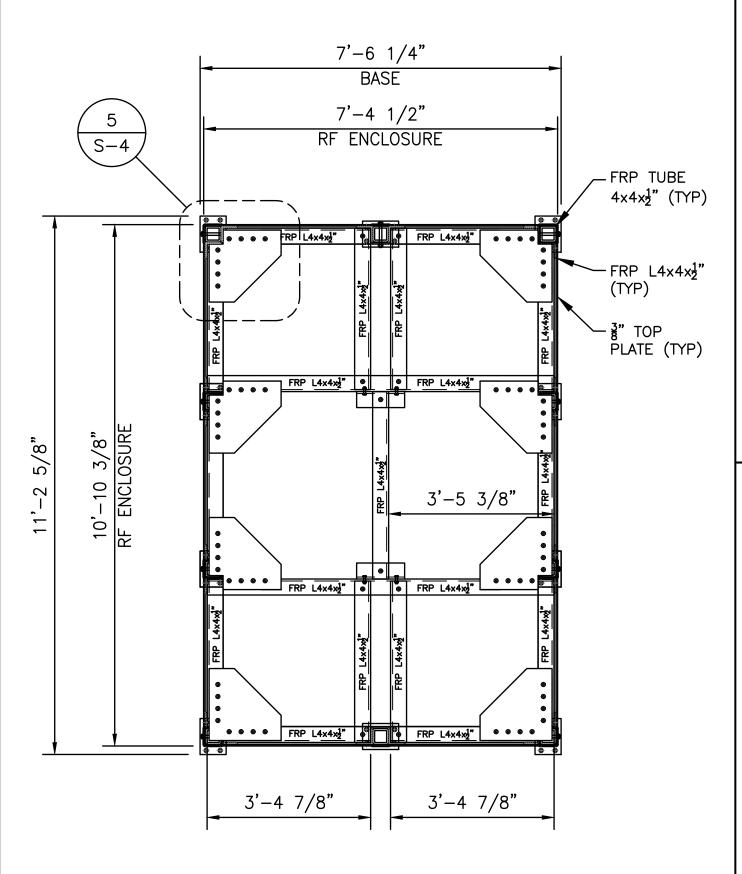



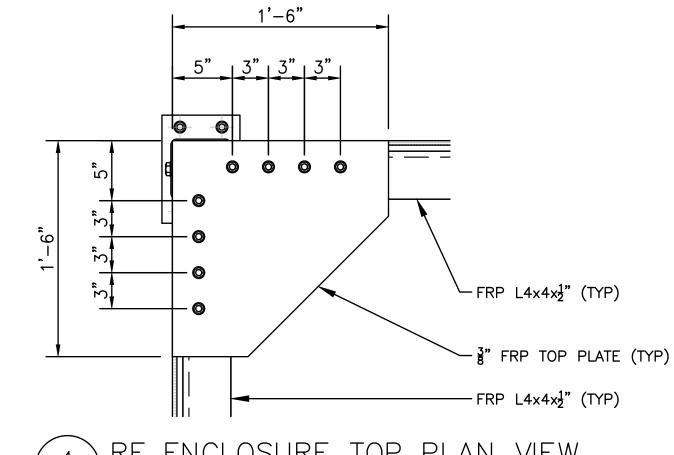

RF ENCLOSURE TOP PLAN VIEW  $\sqrt{S-4}$ SCALE: N.T.S.

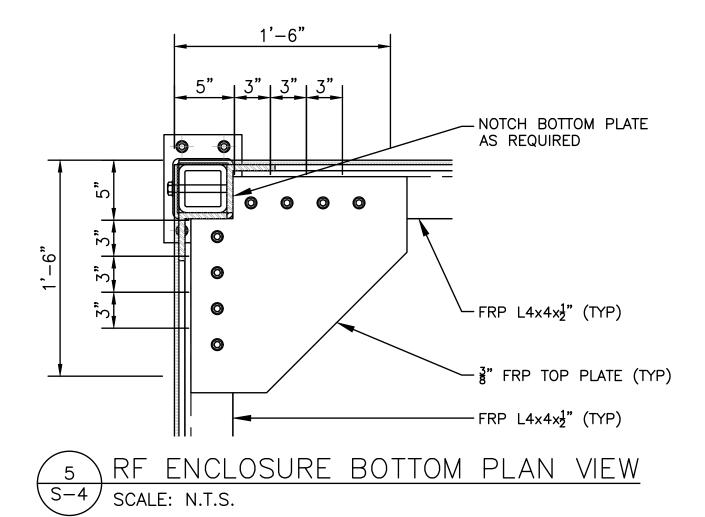




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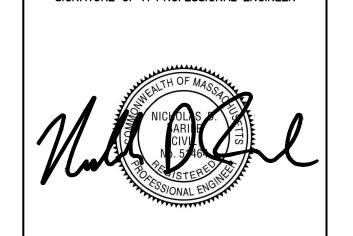


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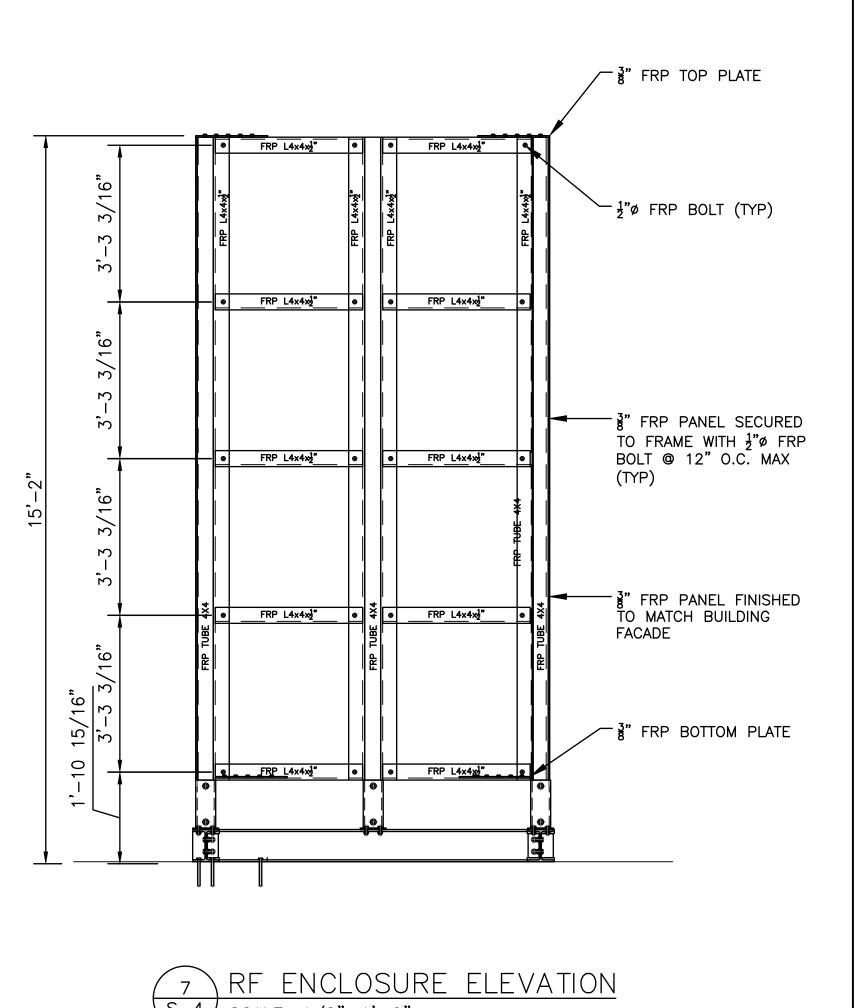



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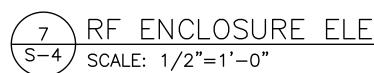
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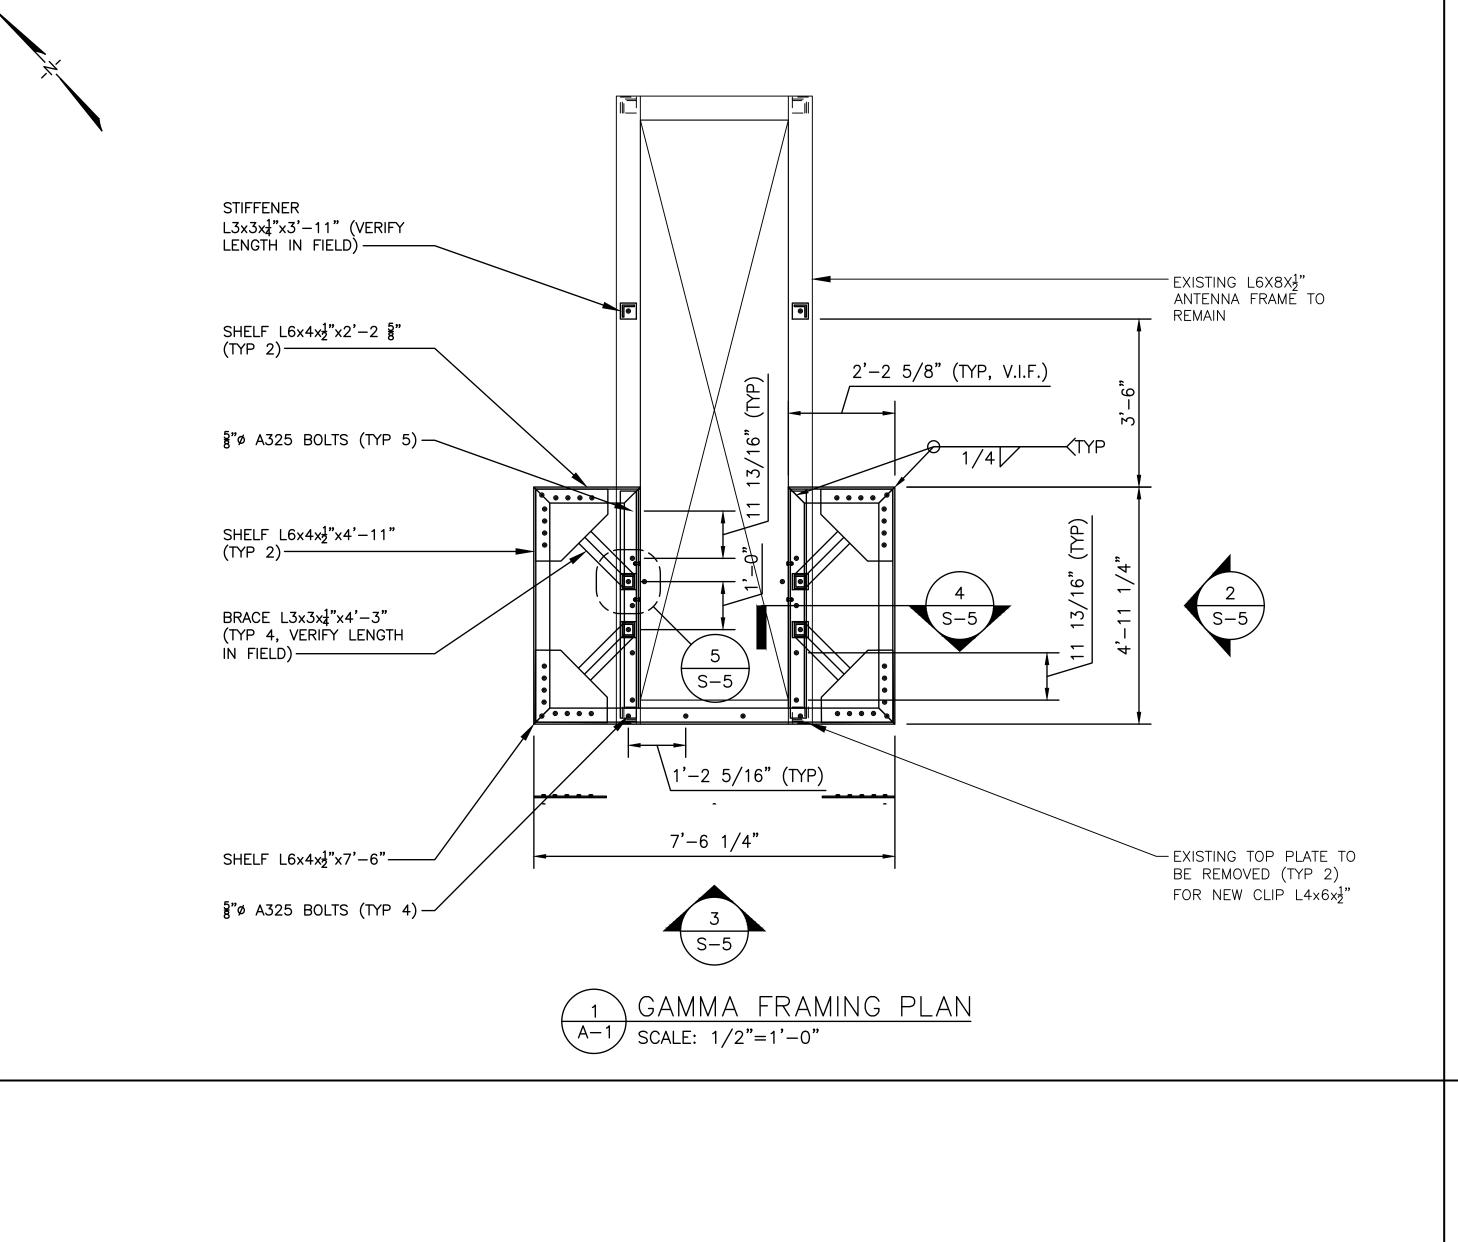
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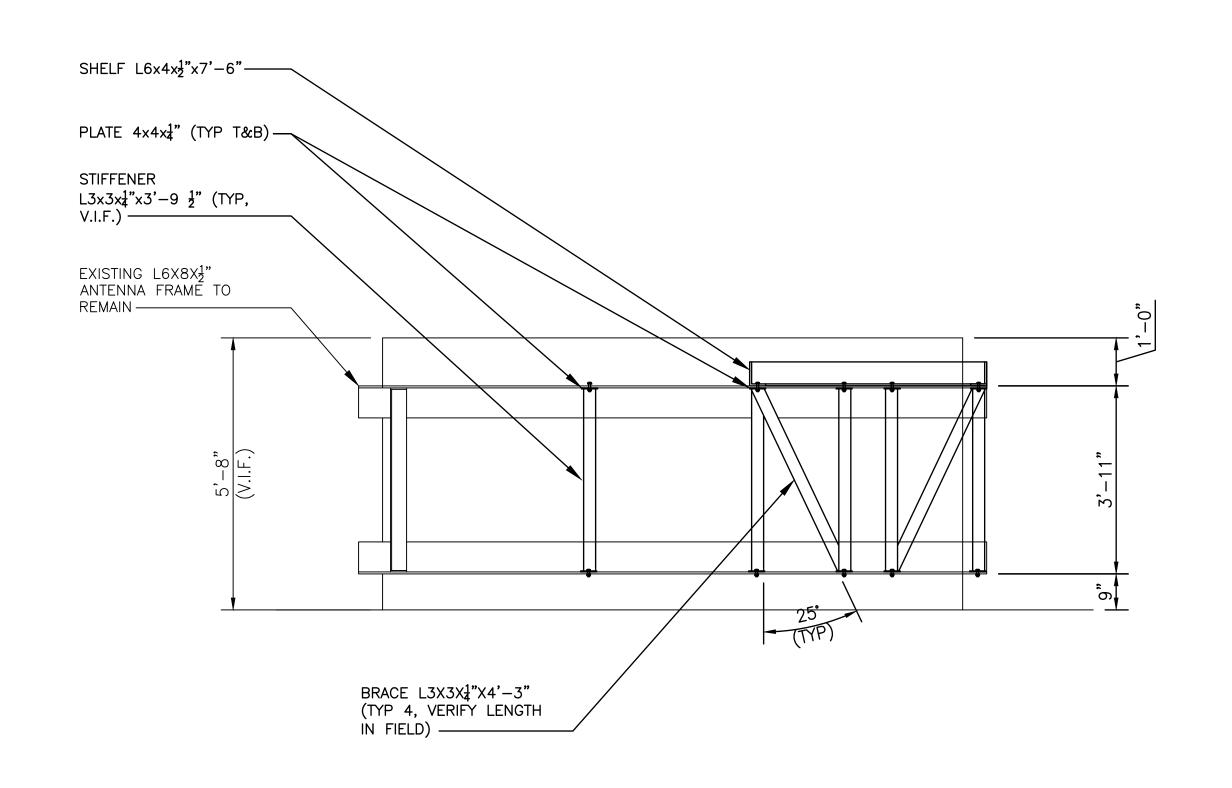
**BETA SCREEN WALL FRAMING PLANS & DETAILS** 



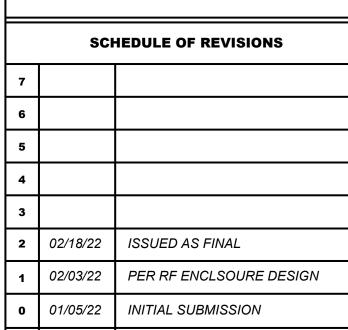







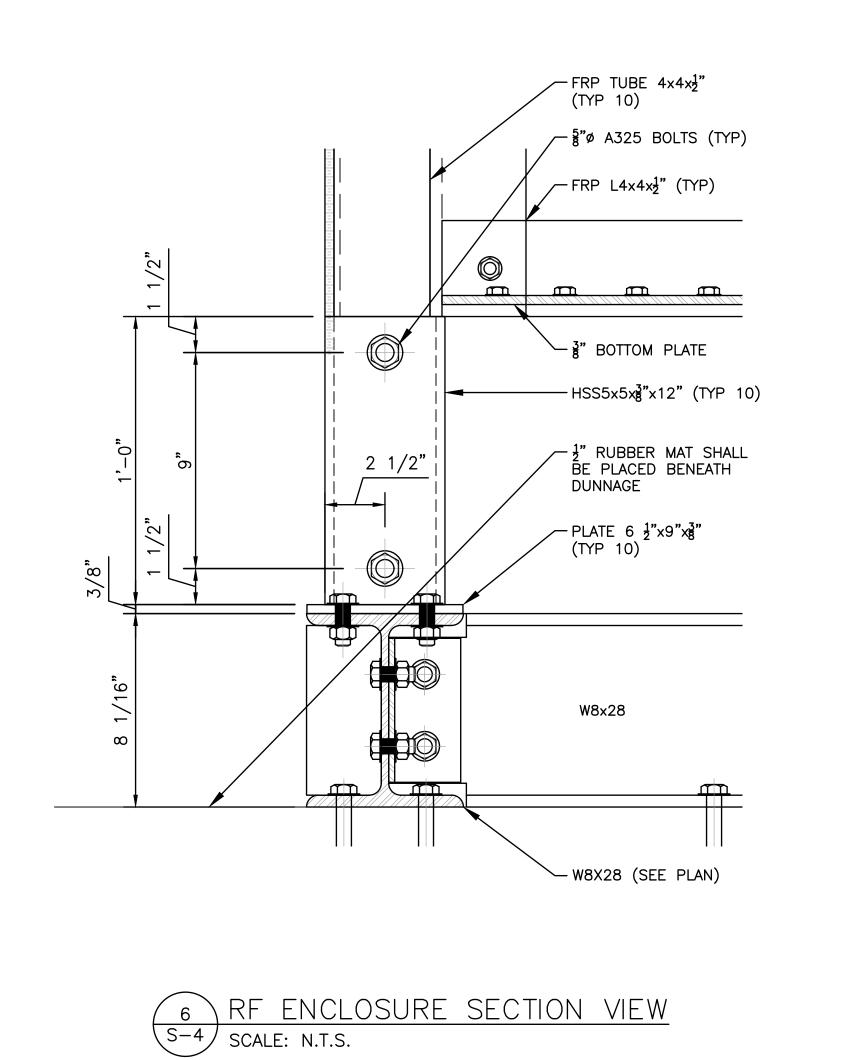

# 2 ELEVATION VIEW S-5 SCALE: N.T.S.

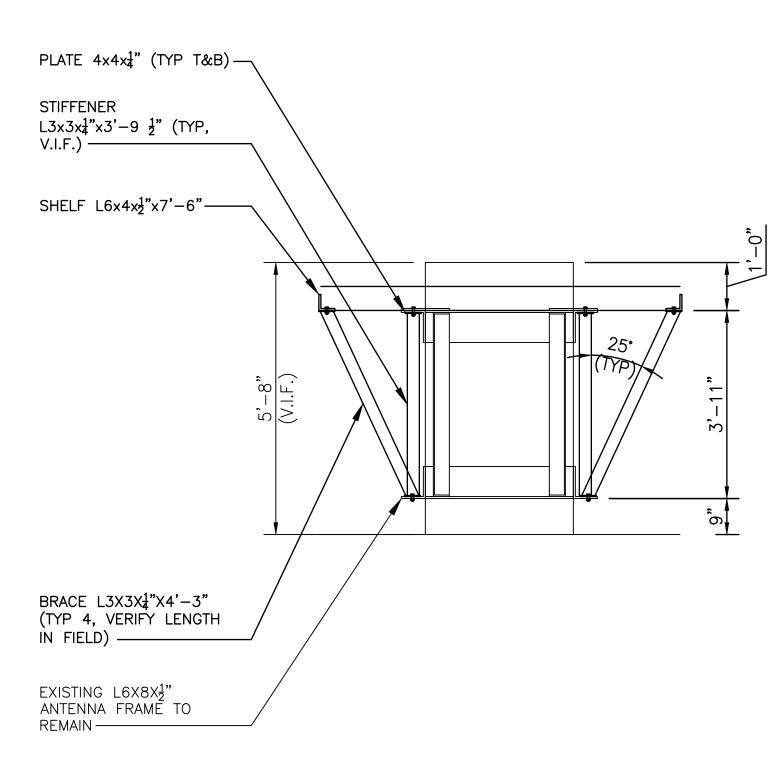


ELEVATION VIEW

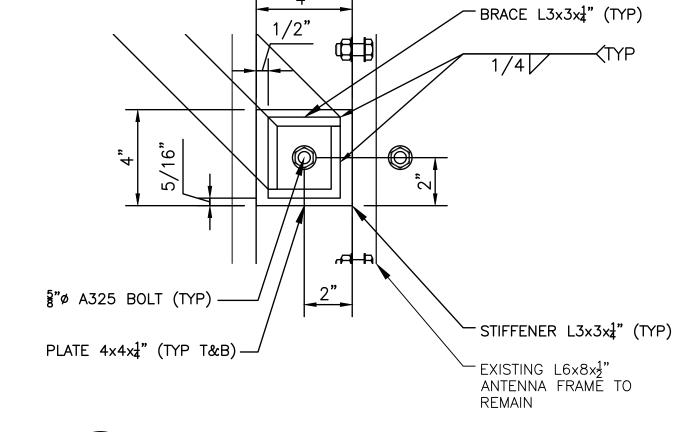

BRACE DETAIL PLAN VIEW

S-5 SCALE: N.T.S.

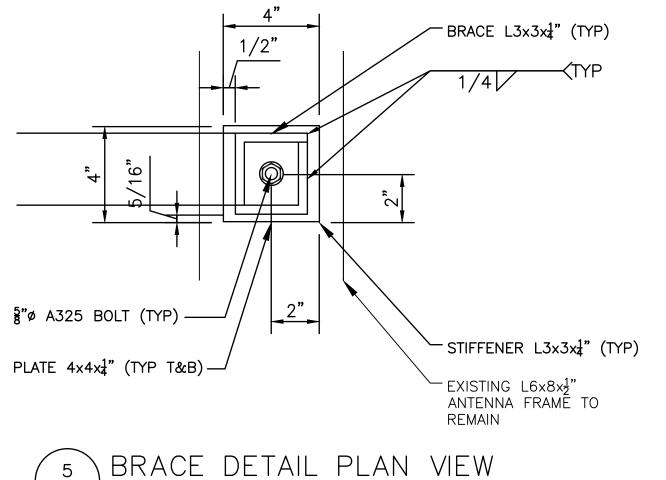

5 BRACE DETAIL PLAN VIEW S-5 SCALE: N.T.S.

T--Mobile

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SCHEDULE OF REVISIONS		
7		
6		
5		
4		
3		
2	02/18/22	ISSUED AS FINAL
1	02/03/22	PER RF ENCLSOURE DESIGN
0	01/05/22	INITIAL SUBMISSION

DESCRIPTION OF CHANGES

DRAWN BY:	CJT
CHECKED BY:	NDB
SCALE:	AS NOTED
JOB NO:	21046-TRN

REV. NO. DATE

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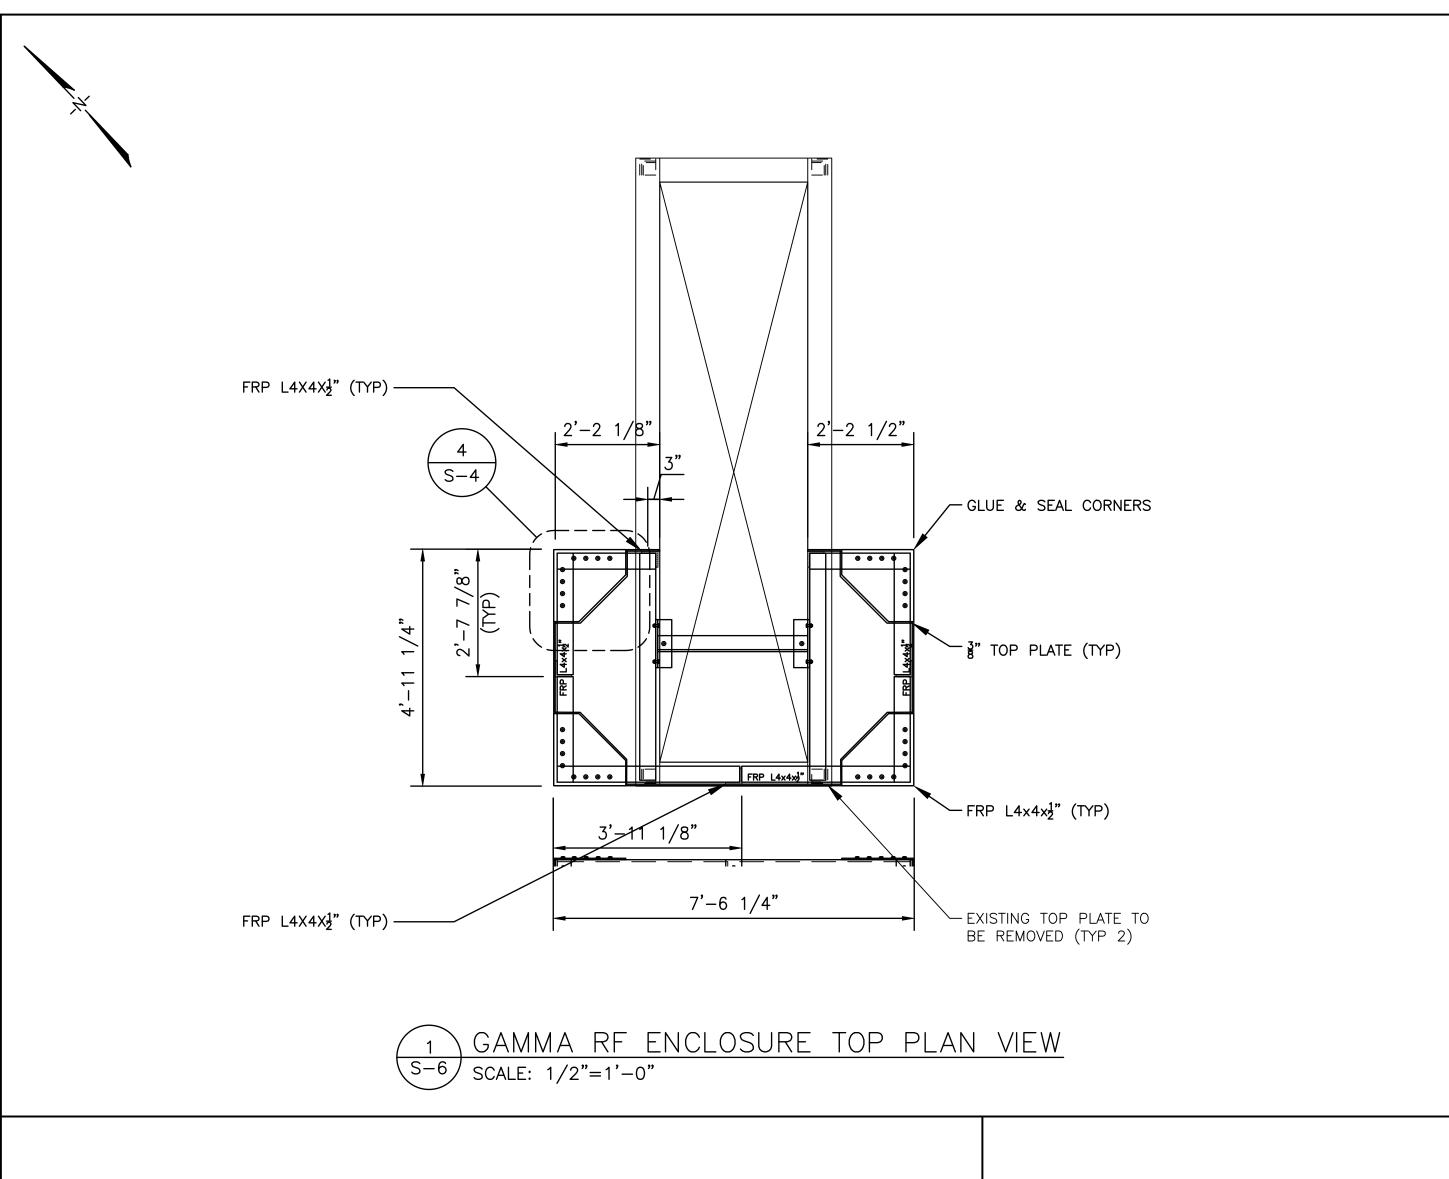
NICHOLAS D. BARILE
PROFESSIONAL ENGINEER, MA LIC. No. 51464


4BN1531C
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NEWBURYPORT, MA 01950
ESSEX COUNTY

DRAWING TITLE:


GAMMA FRAMING PLAN & DETAILS


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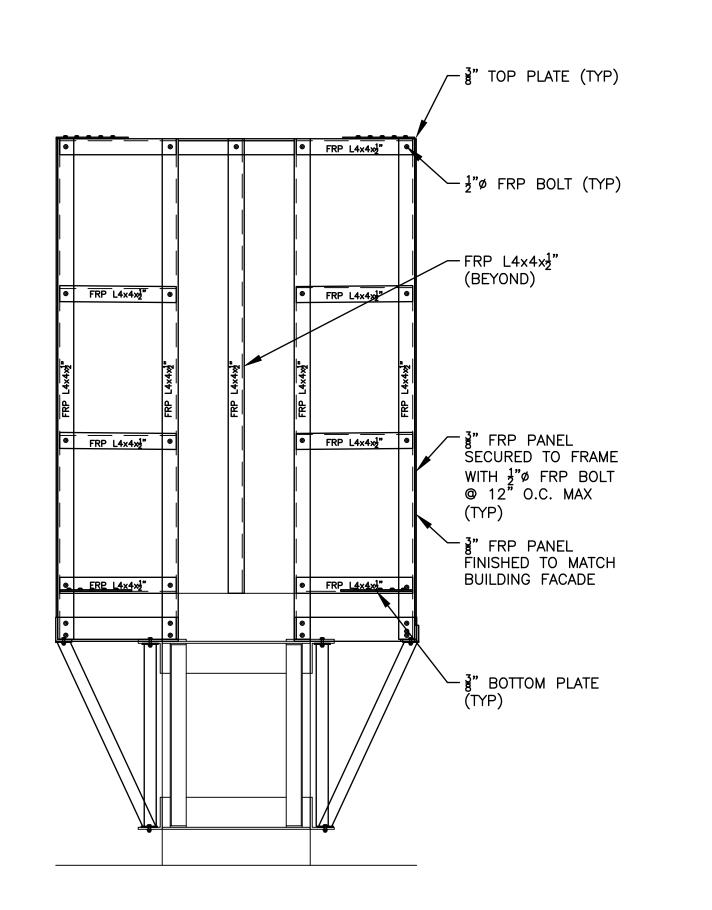


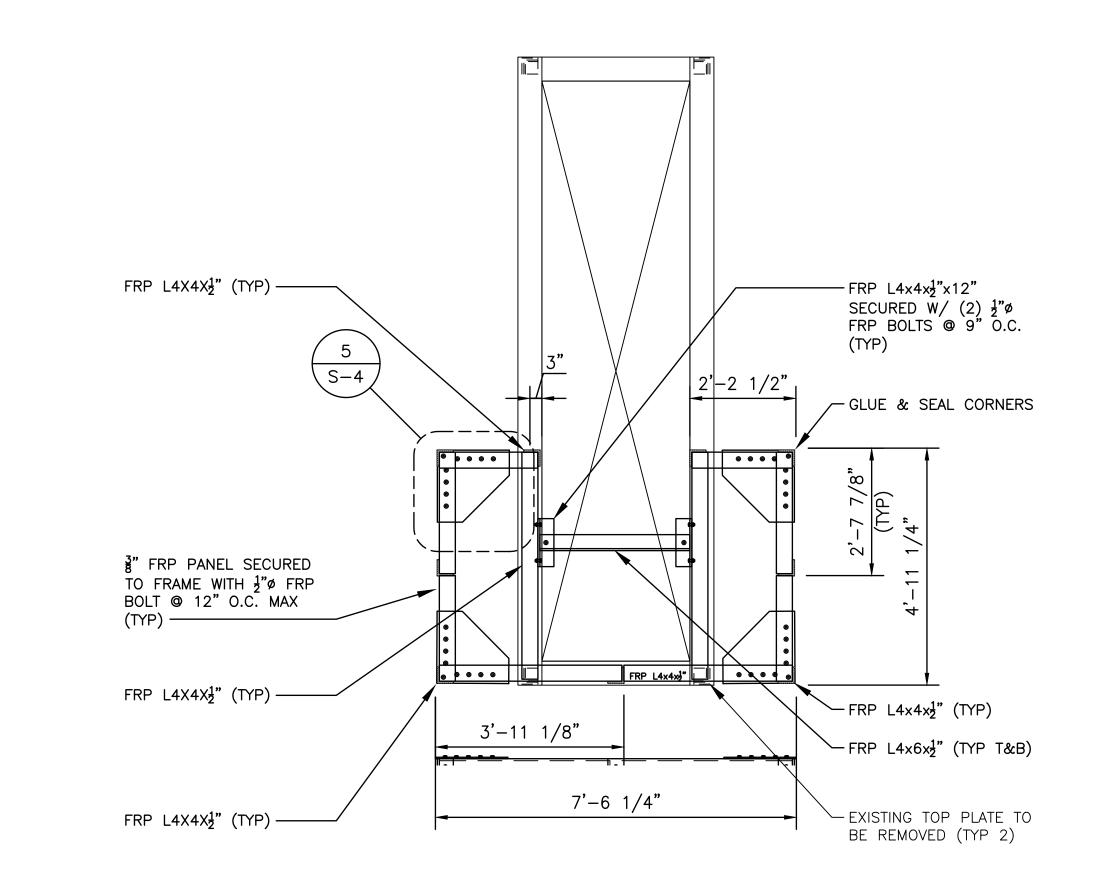

2 GAMMA RF ENCLOSURE BOTTOM PLAN VIEW S-6 SCALE: N.T.S.



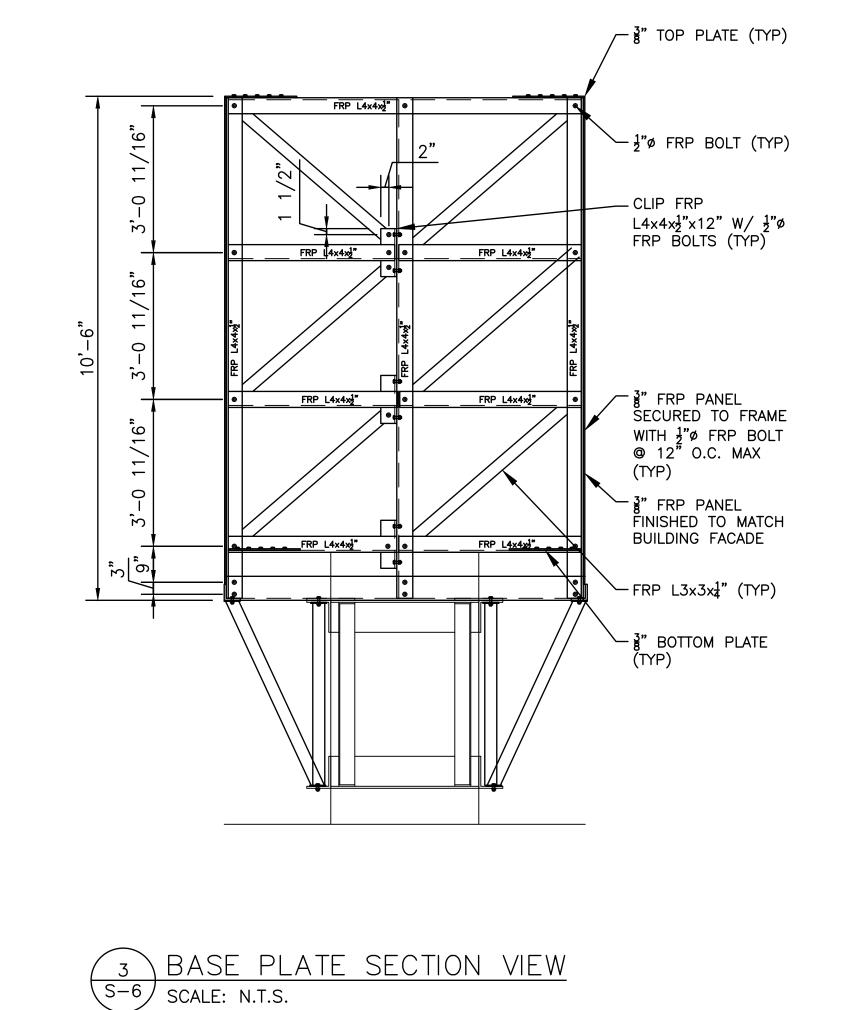

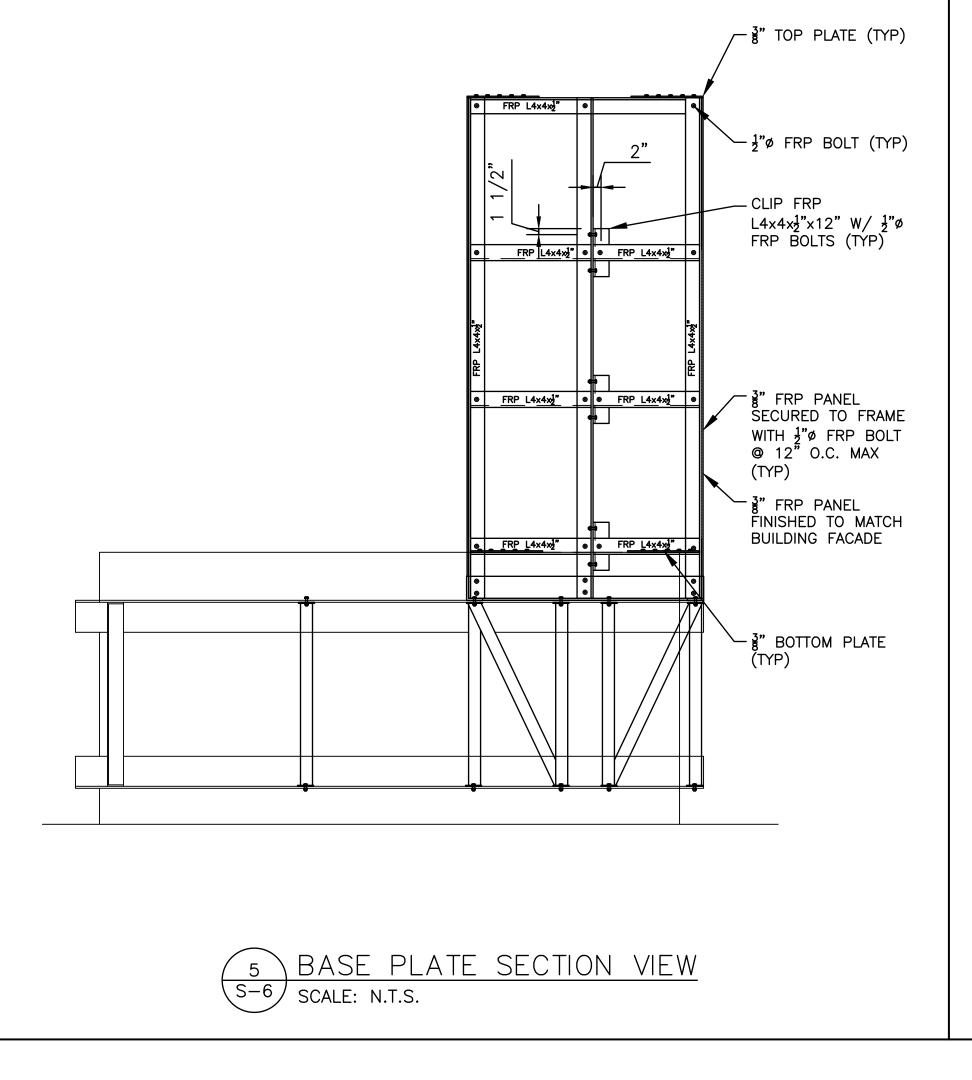



T - Mobile -

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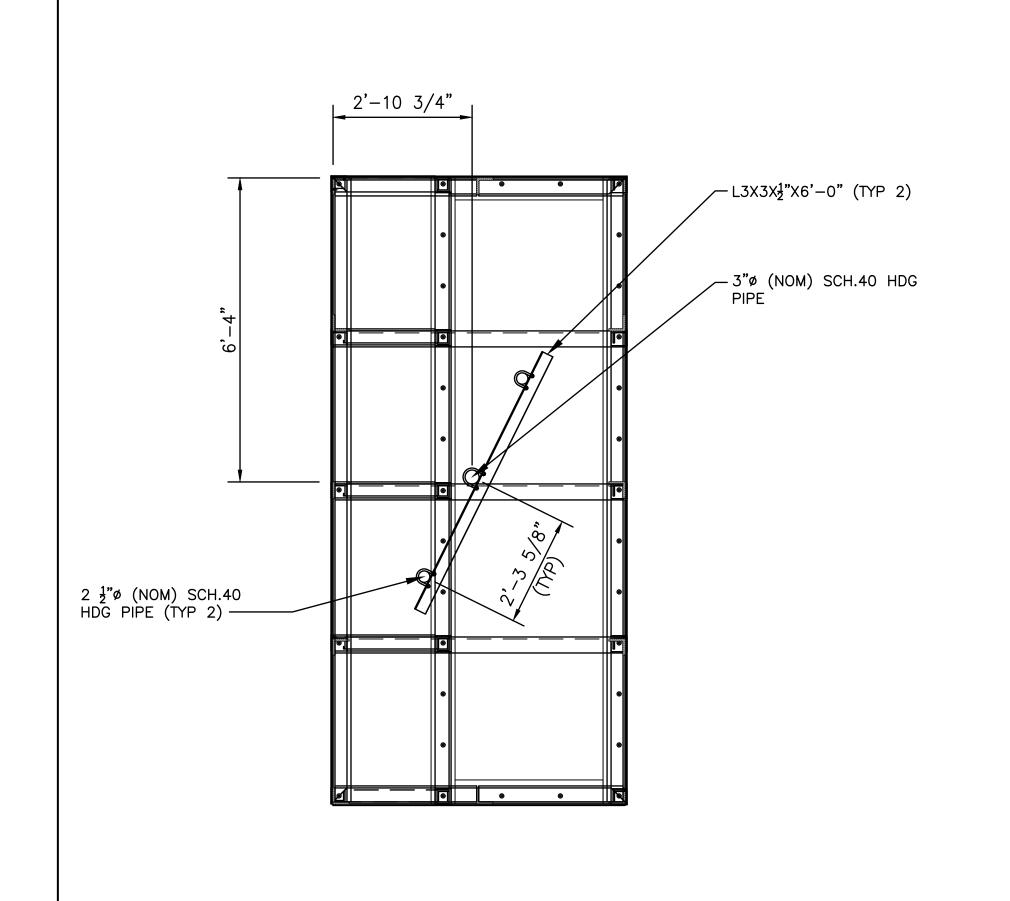
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DRAWING TITLE:


GAMMA RF ENCLOSURE DETAILS

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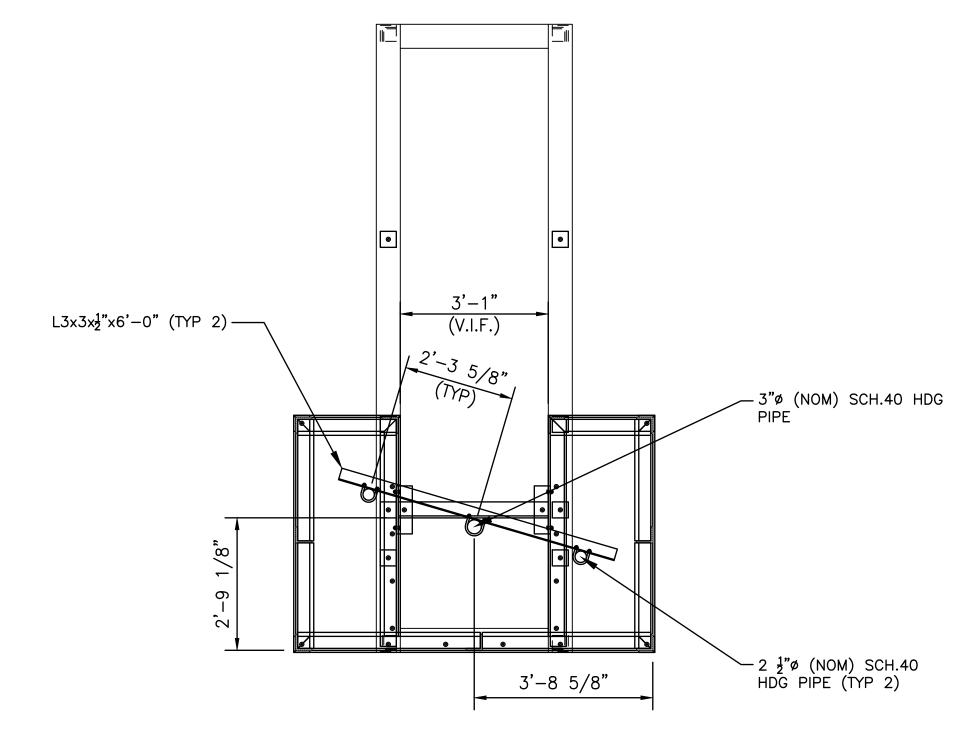


ALPHA ANTENNA MOUNT PLAN VIEW

S-7 SCALE: N.T.S.

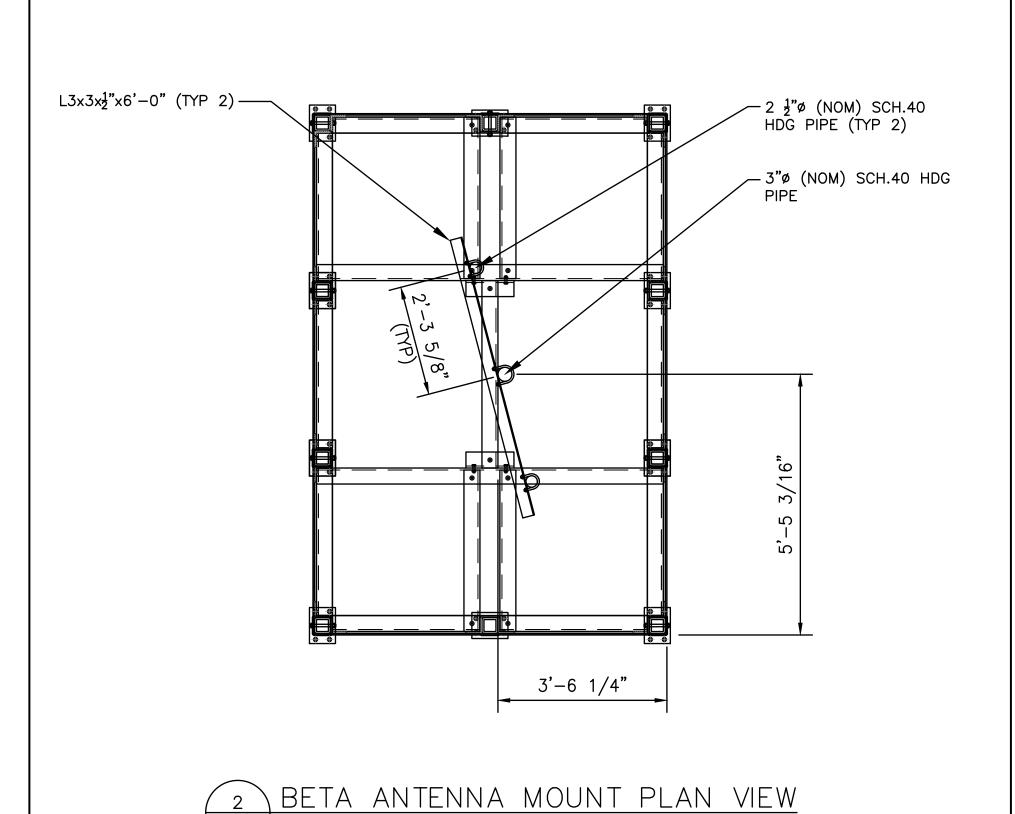

S-7 SCALE: N.T.S.



GAMMA ANTENNA MOUNT PLAN VIEW S-7 SCALE: N.T.S.

REV. NO. DATE DESCRIPTION OF CHANGES **DRAWN BY:** CJT **CHECKED BY:** NDB SCALE:

**2** 02/18/22

1 02/03/22

**o** 01/05/22

JOB NO:

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**SCHEDULE OF REVISIONS** 


ISSUED AS FINAL

INITIAL SUBMISSION


PER RF ENCLSOURE DESIGN

AS NOTED


21046-TRN

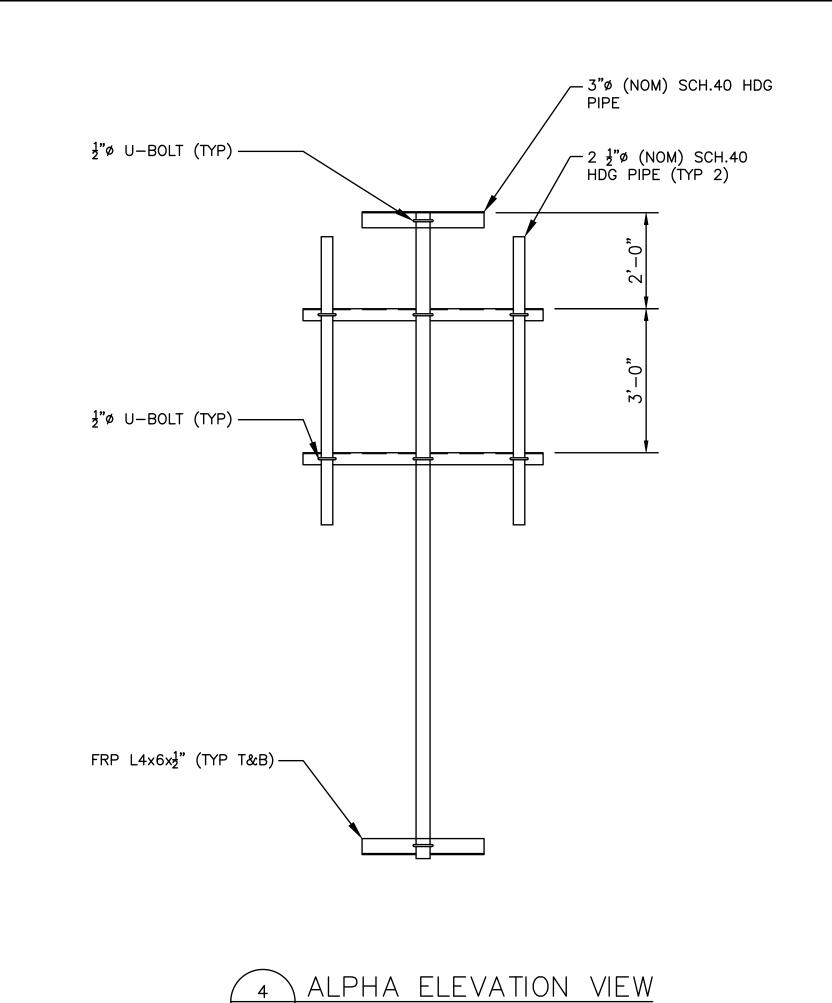


 $\sqrt{S-7}$  SCALE: N.T.S.

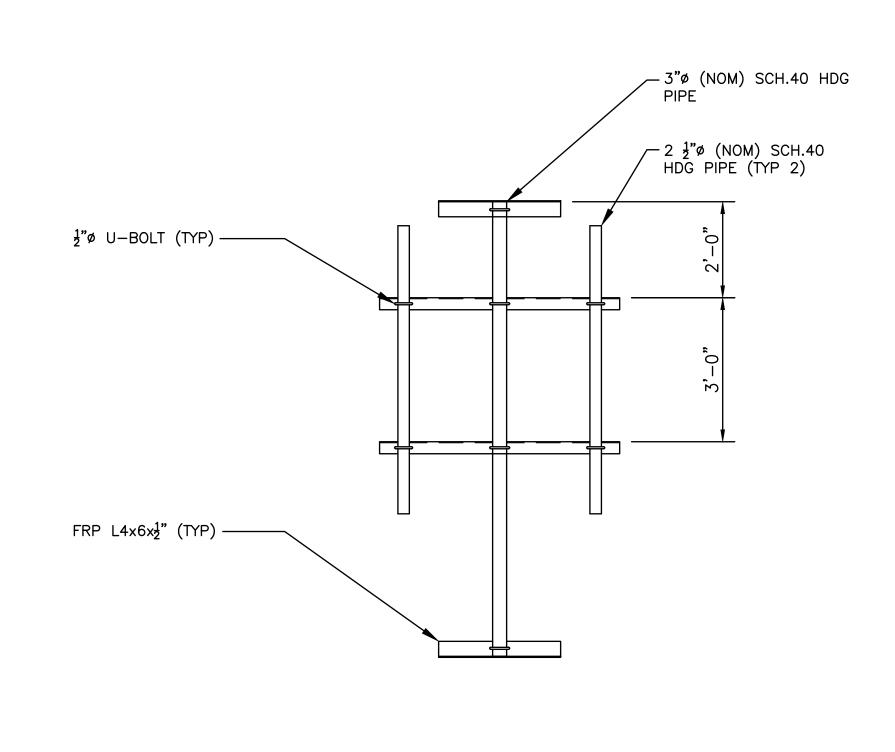




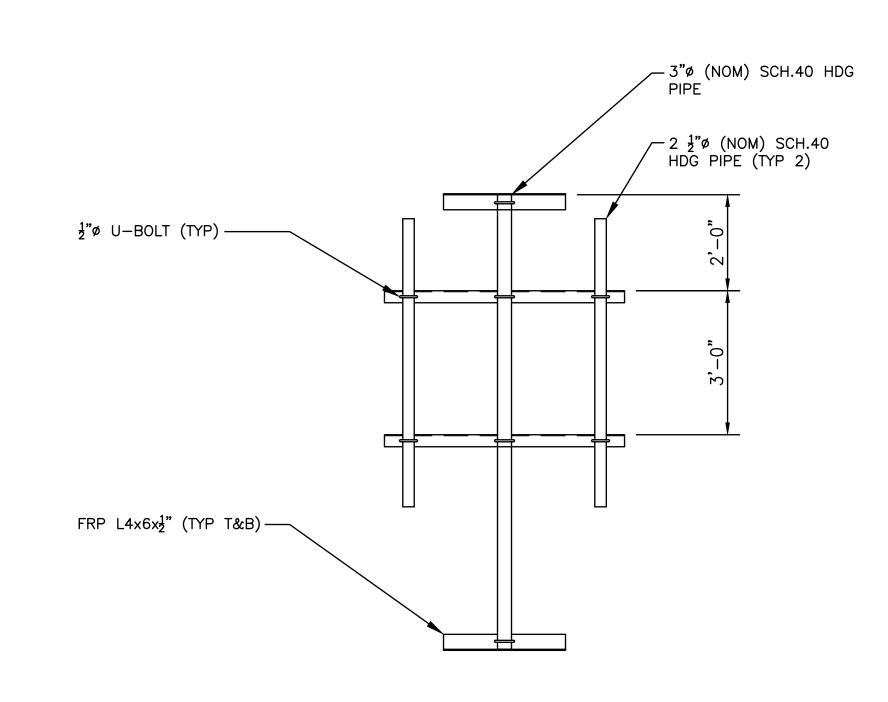

GAMMA ELEVATION VIEW  $\sqrt{S-7}$  SCALE: N.T.S.

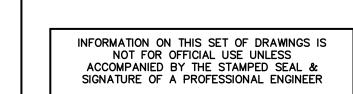

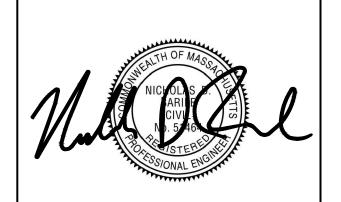


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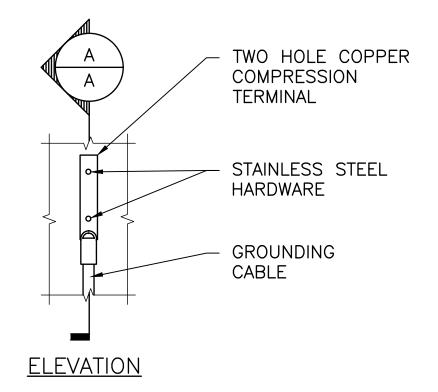
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**ANTENNA MOUNT DETAILS** 




NOTE:


- 1. "DOUBLING UP" OR "STACKING" OF CONNECTIONS IS NOT PERMITTED.
- 2. OXIDE INHIBITING COMPOUND TO BE USED AT ALL LOCATIONS.

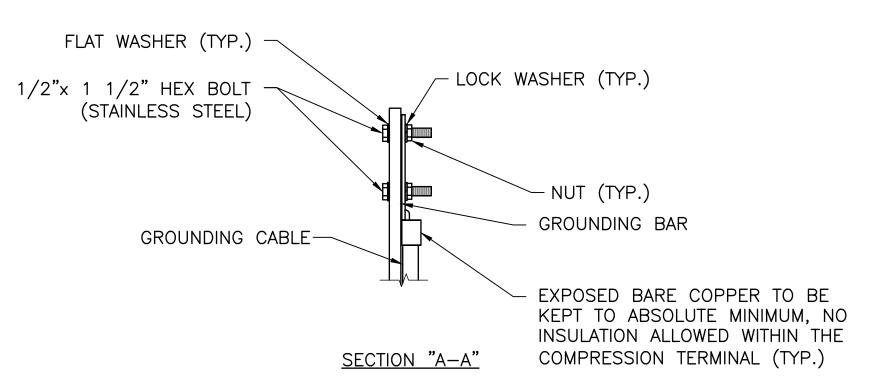

1 TYPICAL GROUND BAR CONNECTION DETAIL SCALE: N.T.S.

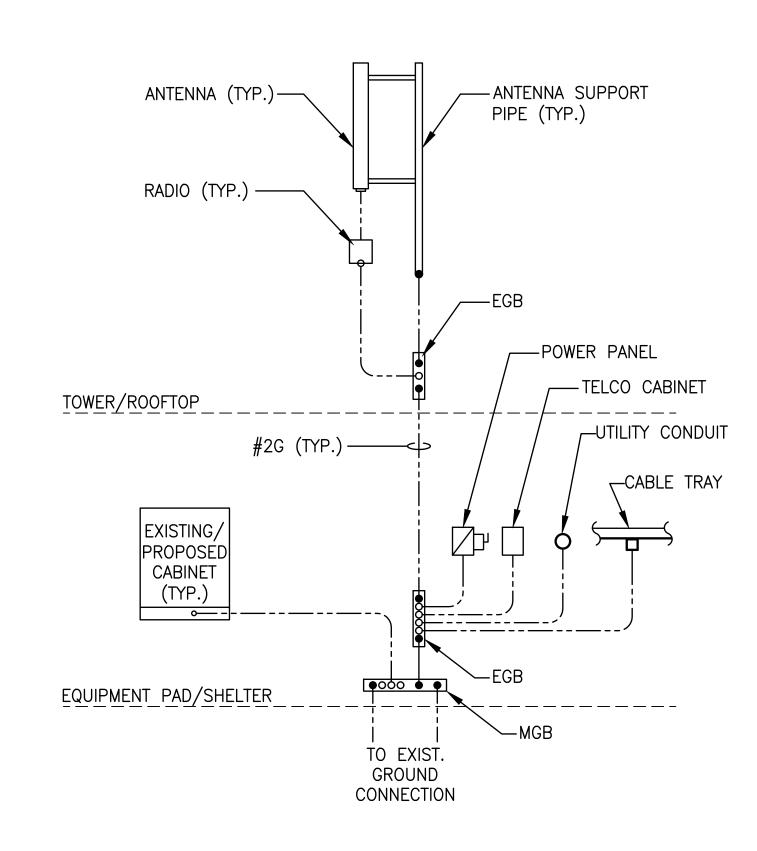


2 GROUNDING RISER DIAGRAM E-1) SCALE: N.T.S.

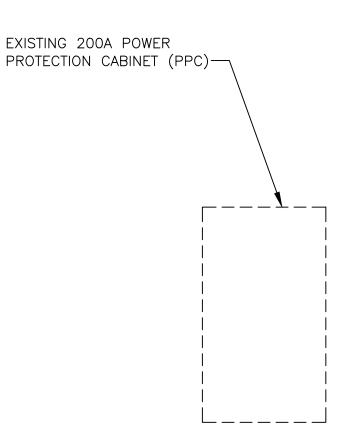


EXISTING ELECTRIC FEEDERS AND CONDUIT TO BE UPGRADED AS REQUIRED, CONDUIT AND WIRE LENGTH/SIZE TO BE VERIFIED BY LICENSED ELECTRICIAN

ONE LINE DIAGRAM

E-1 SCALE: 1/4"=1'-0"

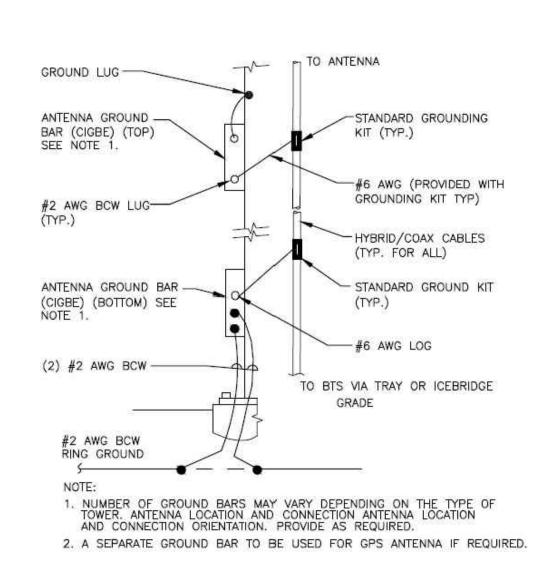

5 ANTENNA CABLE GROUNDING E-1) SCALE: N.T.S.

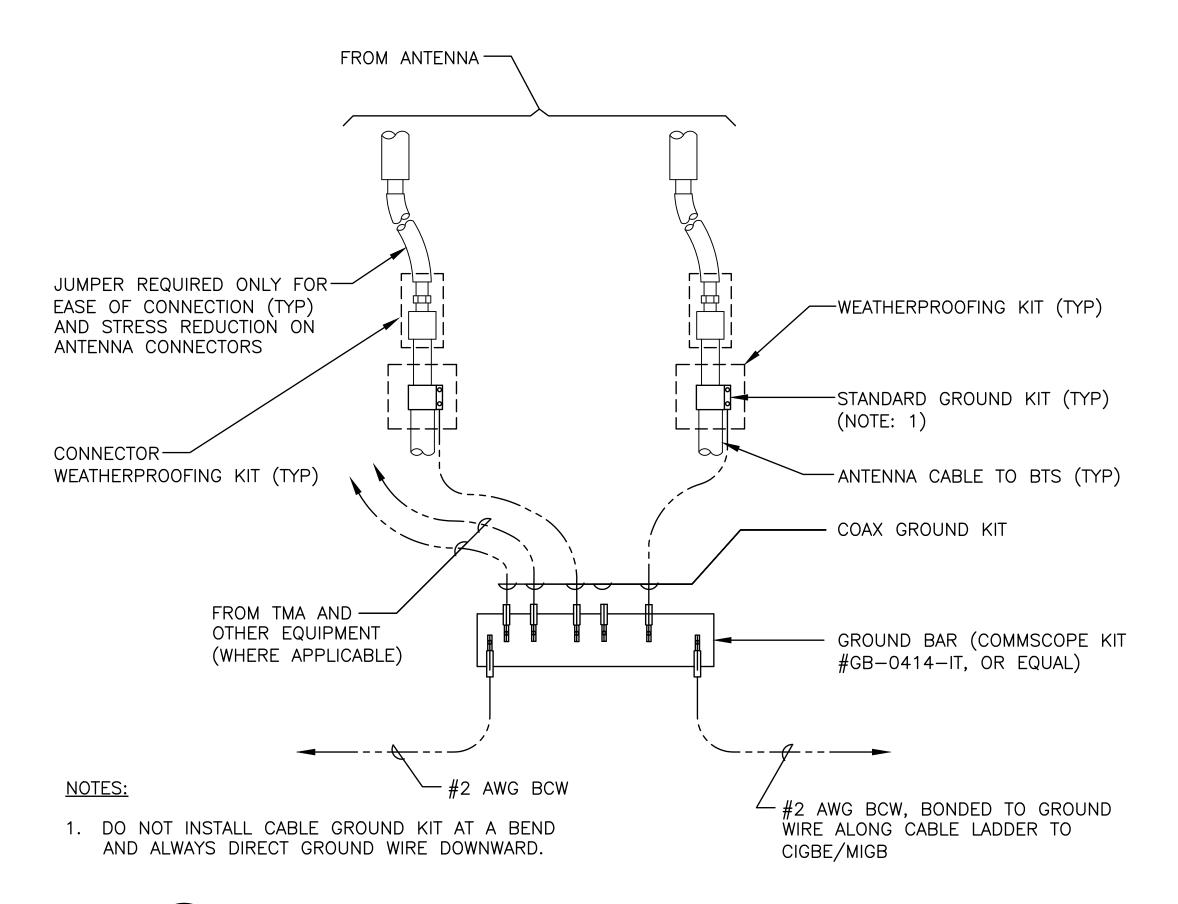

GROUND WIRE TO GROUND BAR CONNECTION DETAIL

E-1 scale: n.t.s.

# T - Mobile

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NEWBURYPORT, MA 01950

**ESSEX COUNTY** 

DRAWING TITLE:

GROUNDING
DETAILS
& ONELINE DIAGRAM

DRAWING SHEET:

E-1