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December 6, 2021

By Hand and Email

Rob Ciampitti, Chair
Zoning Board of Appeals
City of Newburyport
City Hall
60 Pleasant Street
Newburyport, Massachusetts 01950

Re: Request for Special Permit for Nonconformities-UPDATED MATERIALS; 4 Plum Street, Newburyport, MA (the "Property")

Assessor's Map: 52 Lot: 53

Dear Chair and Members of the Board:

Reference is made to the above-captioned matter. In that connection, this firm represents Mike Bukhin and Anna Wallack (collectively the "Applicant"), the owners of the Property, relative to proposed additions to the existing single family structure on the Property. The Applicant previously appeared before the Historical Commission at its October 28 meeting and is scheduled to appear again before the Commission at its December 9 meeting. The Applicant is schedule to appear before the ZBA at its December 14 meeting. Now, in response to the feedback they received from the Commission, the Applicant submits the following updated/revised materials and information:

- Updated Elevations and Renderings: The Applicant has made a number of changes from the previously proposed plans. First, wooden clapboard siding has been added to the addition to differentiate it from the existing historical structure which has wooden shingle siding. Although, the Dormer is exempt from the Commission's Demolition Delay purview under the City Ordinance, the dormer has also been redesigned to reflect the shape of the proposed addition and detract from the existing structure less than the prior proposal. The dormer enjoys the same roof design as the house picking up on the gable design. The dormer is not as broad across the roof as was originally proposed
- For clarity, the order of the elevations in the proposed and existing elevations has also been changed for consistency when comparing the elevations. For example, now the Southwest Elevation is shown in the top left corner of both the proposed and existing elevations.
- The Architect has also retained the Services of Lisa J. O'Donnell, PE of LJO Engineering, LLC to provide Professional Engineering Services on this project including construction. Ms. O'Donnell has extensive experience working with architects on projects involving historic structures, some of which have been in Newburyport. As the Architect previously mentioned, before he developed the plans, he undertook a thorough in-person investigation of the structure and developed plans that could be physically accommodated. He cannot imagine problems that he cannot see or that do not exist and fully intends to

deal with the known structural issues and those that may be discovered during construction with Ms. O'Donnell.

To be clear, while the elevations have changed, the footprint has not. The changes are purely architectural. Therefore, there is no new Site Plan included with this filing and the relief requested from the Board remains the same.

Please do not hesitate to contact me at 978-463-7700 if you have any questions.


Respectfully submitted


Mike Bukhin and Anna Wallack


By their Attorney

Lisa L. Mead

Attachment cc: client

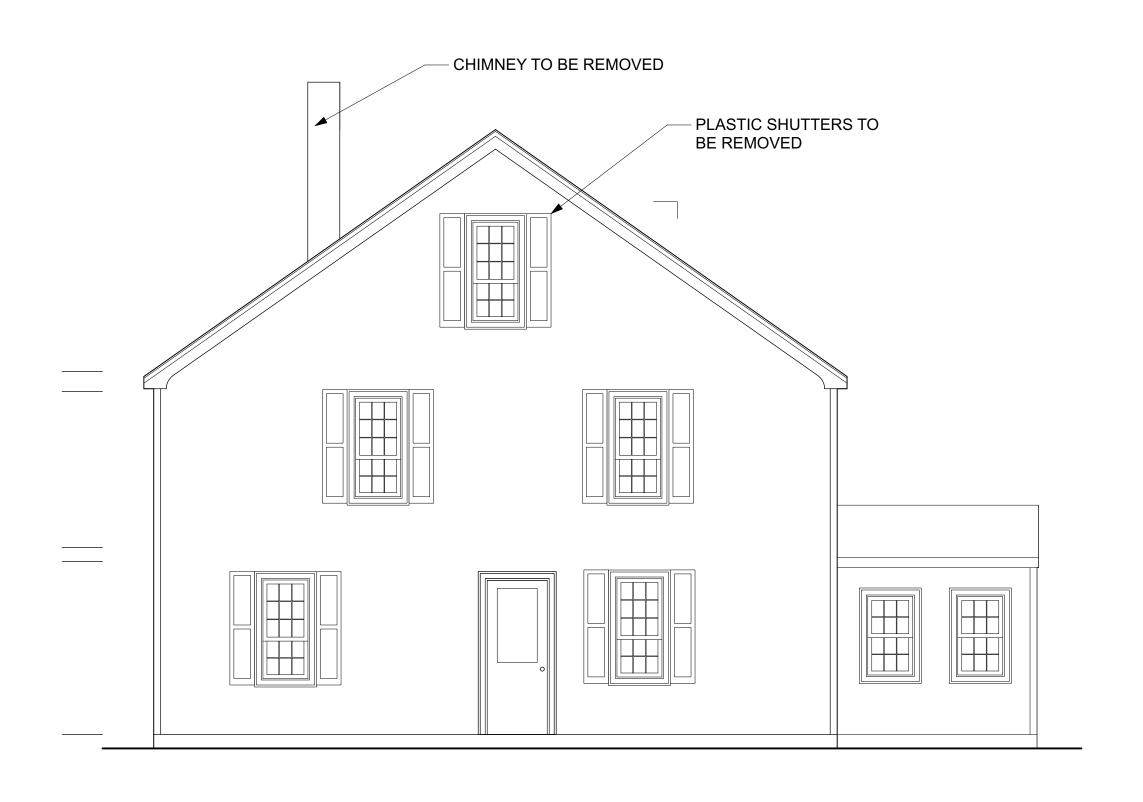

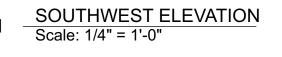

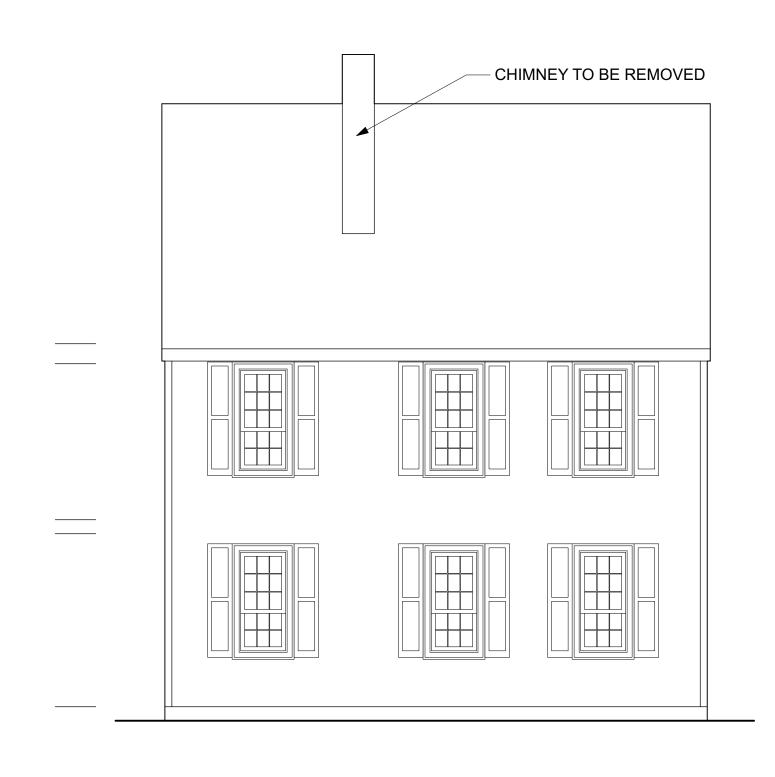

NORTHWEST ELEVATION
Scale: 1/4" = 1'-0"




RESIDENCE


4 PLUM STREE

NEWBURYPOR

MASSACHUSET



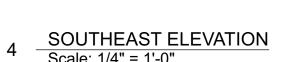


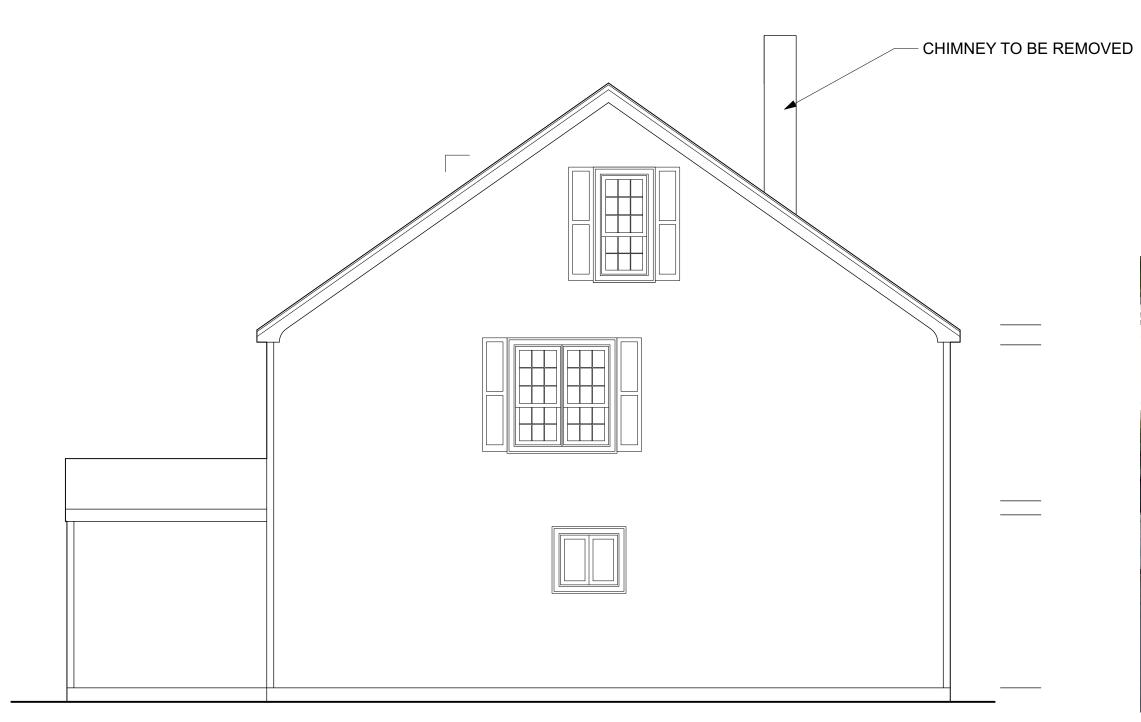

2 NORTHEAST ELEVATION
Scale: 1/4" = 1'-0"




No.	Date	Revisions / Submissions
1 2	9/29/21 11/15/21	CHIMNEY & SHUTTER NOTE COORDINATE EL ORIENTATION

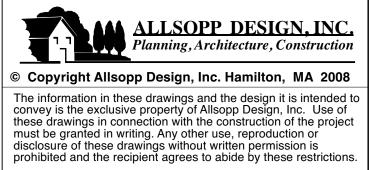

ALLSOPP DESIGN INC.
587 BAY RD.
HAMILTON, MA 01936
(978)468-1556

Drawing Title

4 Total Sheets

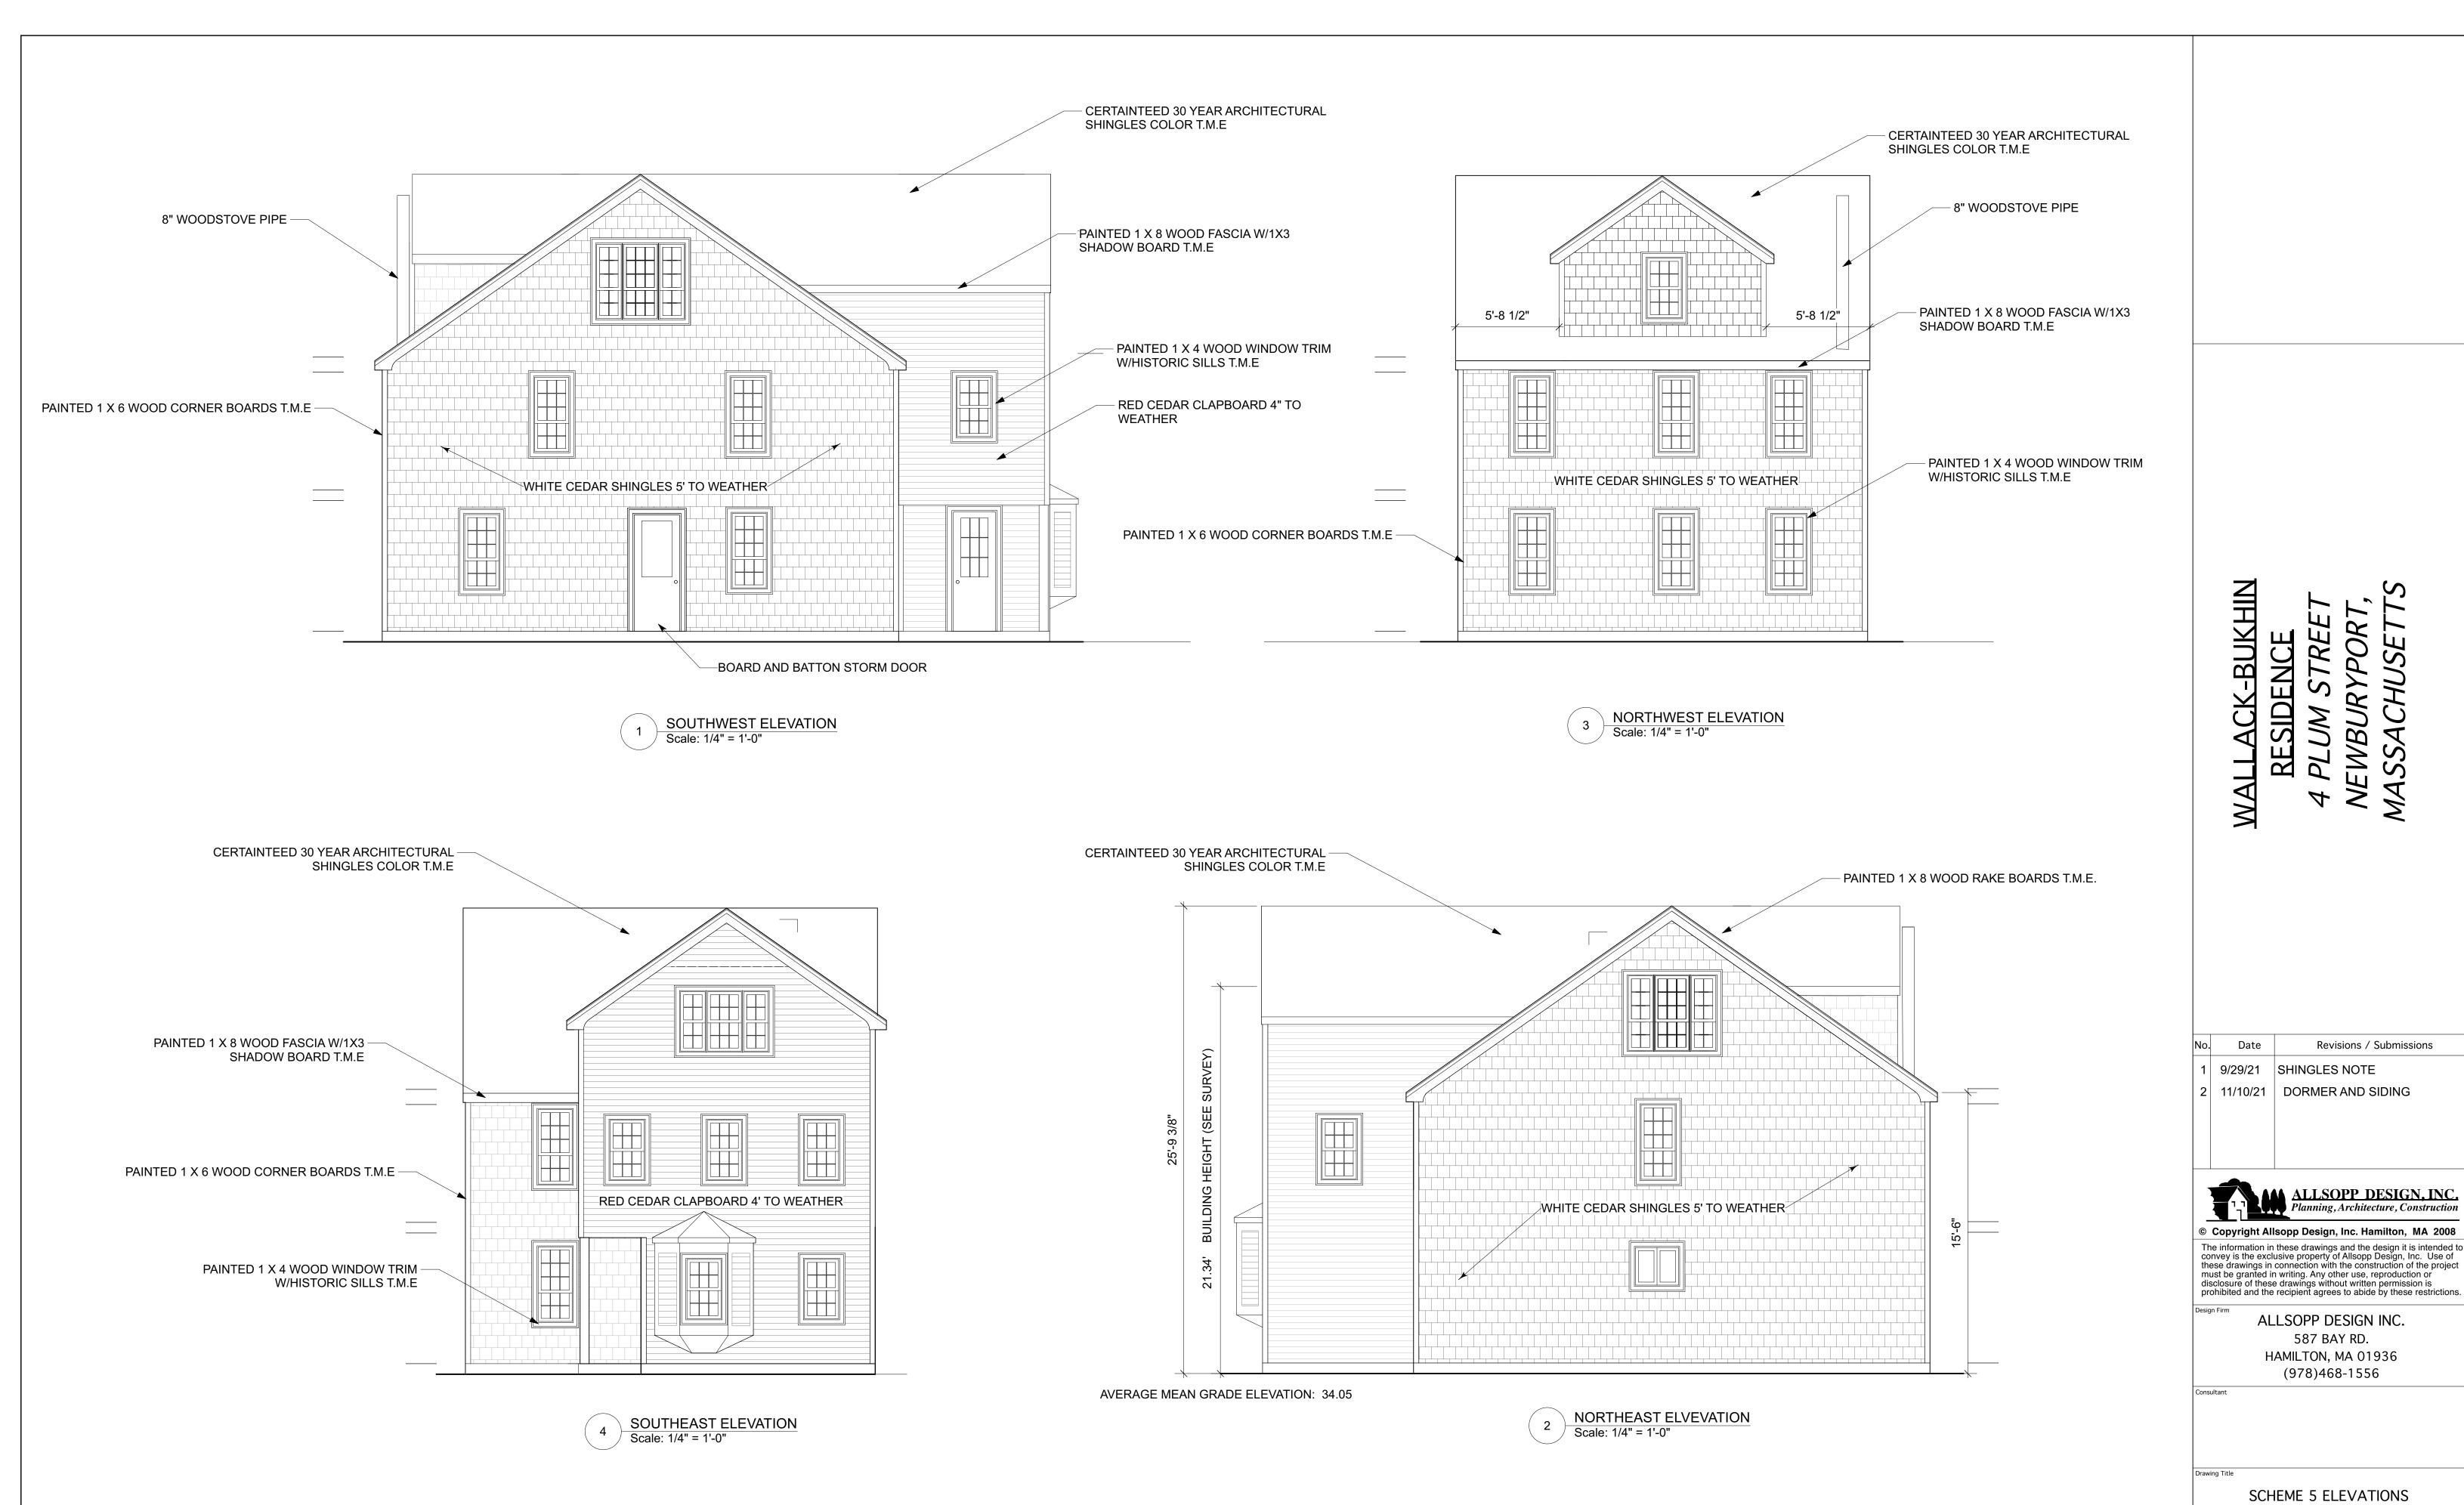

RESIDENCE

Revisions / Submissions

ALLSOPP DESIGN, INC. Planning, Architecture, Construction

1/4"=1'

4 Total Sheets

SHINGLES NOTE

ALLSOPP DESIGN INC. 587 BAY RD. HAMILTON, MA 01936 (978)468-1556

JFA

JFA

9 MAR 2021

Building/Structure Height

The vertical distance between the mean grade elevation (average grade around perimeter of building) and the highest point on the finished roof in the case of a flat roof, and the average height of the rise in the case of a pitched or stepped roof, or similarly sculptured roof form, or any higher pointof a feature not excluded, but excluding common rooftop appurtenances such as stairwells, elevator shafts, and mechanical penthouses. Each rooftop appurtenance shall be properly screened from public view and for noise control, located no closer than ten (10) feet from the parapet or exterior wall of the supporting building/structure, and may extend no more than ten (10) feet above the maximum Building/Structure Height. The sum of the area of all rooftop appurtenances to any one building/structure shall not exceed twentypercent (20%) of the total footprint of such building/structure



