


LOCUS MAP (NOT TO SCALE)

WE HEREBY CERTIFY THAT THIS PLAN IS THE RESULT OF AN ACTUAL ON THE GROUND SURVEY PERFORMED ON OR BETWEEN MARCH 12, 2019 AND NOVEMBER 11, 2019. THE ABOVE IS CERTIFIED TO THE BEST OF MY PROFESSIONAL KNOWLEDGE, INFORMATION AND BELIEF.


ALLEN & MAJOR ASSOCIATES, INC.

PROFESSIONAL LAND SURVEYOR FOR ALLEN & MAJOR ASSOCIATES, INC.

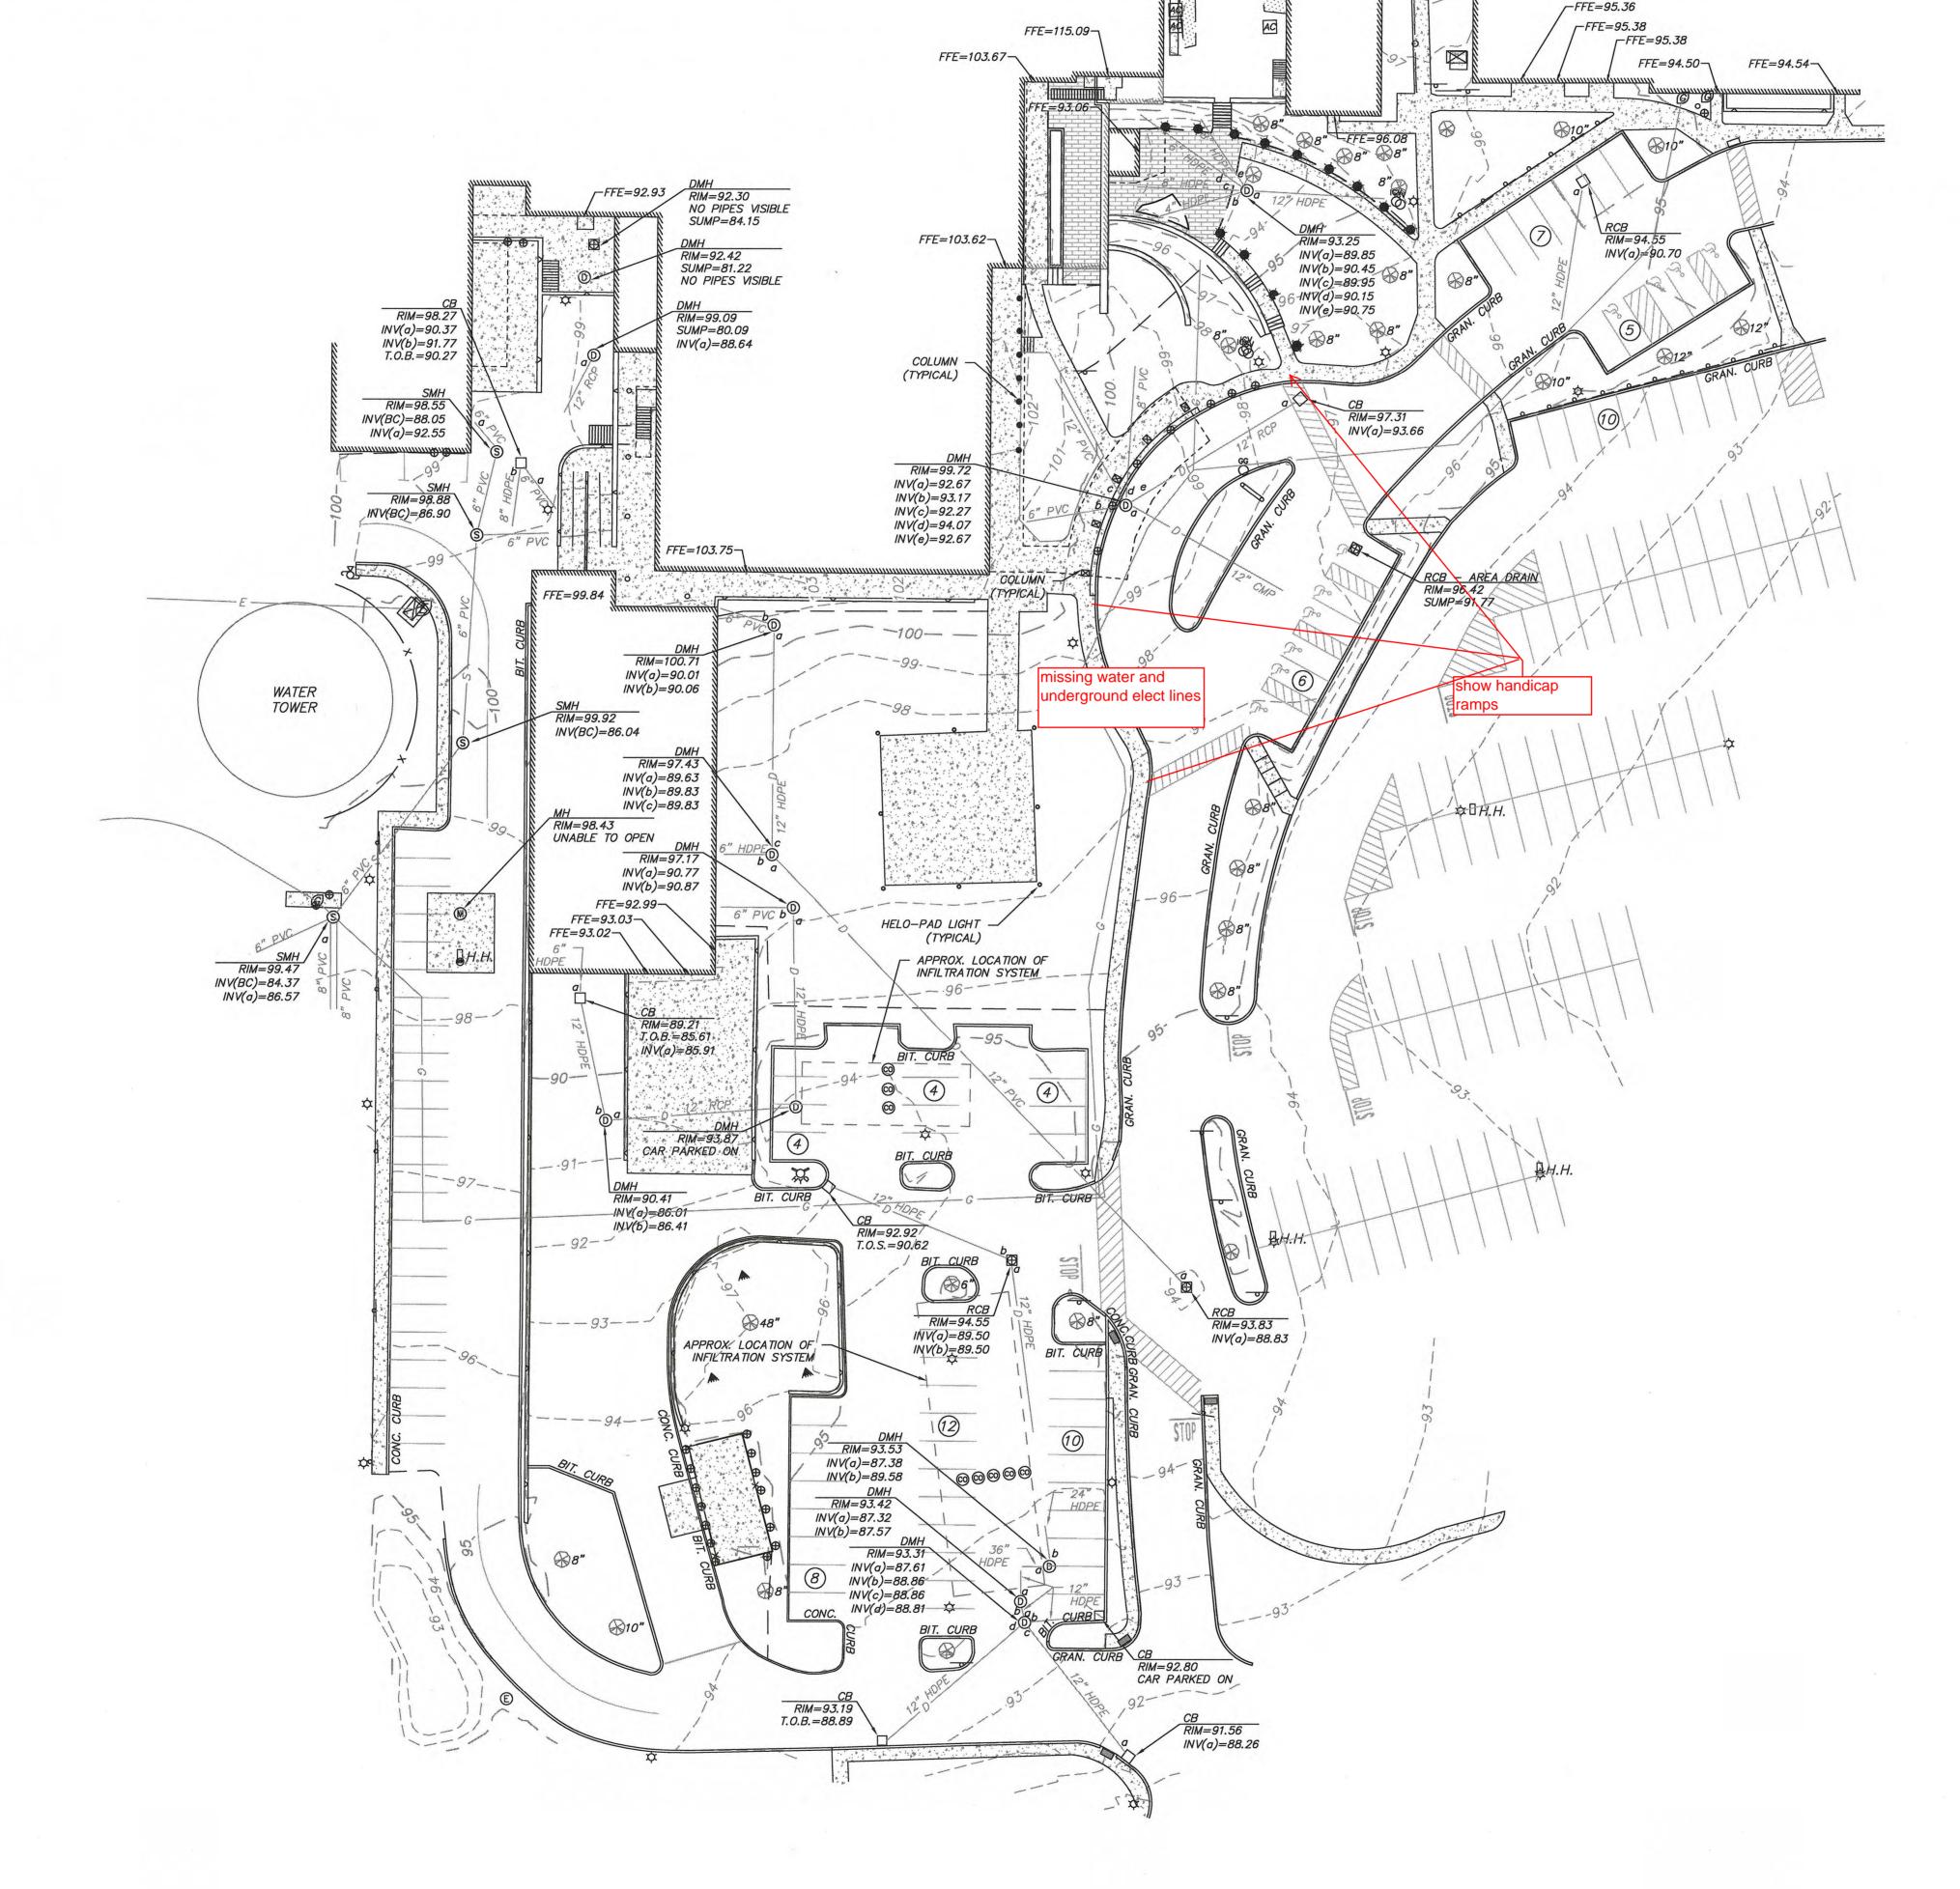

FFE=103.88-\

FFE=94.71-

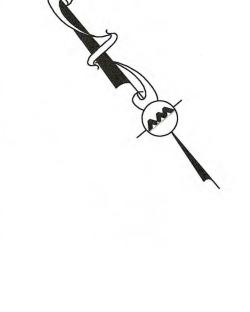

Beth Israel Lahey Health

Anna Jaques Hospital

Anna Jaques Hospital

OR Building Expansion

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9 Billings Road

North Quincy, MA 02171

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R.W. Sullivan Engineering

LANDSCAPE ARCHITECT

Allen & Major Associates, Inc.

100 Commerce Way, Suite 5

STRUCTURAL ENGINEER

Schlick Engineering, LLC.

Woburn, MA 01801

Tel. 781.935.6889

10 Main Street

FORMAT. CLIENT/CLIENT'S REPRESENTATIVE OR CONSULTANT MAY BE PROVIDED COPIES OF DRAWINGS

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DIGITAL INFORMATION MAY BE MODIFIED

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A&M project number:

AND SPECIAL PERMIT

ISSUED FOR LOCAL PERMITTING 11/25/19

ISSUED FOR SITE PLAN REVIEW 01-08-20

Lakeville, MA 02347

Tel. 774.419.3796

529 Main St. Suite 203

Boston, MA 02129

Tel. 617.523.8227

LAND SURVEY,

ASSOCIATES, INC. & CIVIL ENGINEER

Consultants

LEGEND DRAIN MANHOLE (DMH) SEWER MANHOLE (SMH) ELECTRIC MANHOLE (EMH) MISC. MANHOLE (MH) CATCH BASIN (CB) ROUND CATCH BASIN (RCB) **BOLLARD** LIGHT **FLOODLIGHT** PEDESTRIAN LIGHT TREE AREA DRAIN SIGN SIGN 0 TRANSFORMER $\Box H.H.$ HAND HOLE AIR CONDITIONER CABLE BOX TELEPHONE BOX ELECTRIC BOX GAS METER ELECTRIC METER HANDICAPPED PARKING SPACE IRRIGATION CONTROL VALVE PARKING SPACE COUNT SPOT GRADE ×110.6 CONCRETE LANDSCAPED AREA (LSA) BRICK/PAVER BUILDING BUILDING OVERHANG 1' CONTOUR --- 93 --- ---5' CONTOUR ___ 95 ___ PROPERTY LINE CONCRETE RETAINING WALL EDGE OF PAVEMENT EDGE OF BRICK _____ **CURB** CHAIN LINK FENCE _____ x ____ STOCKADE FENCE _____ METAL RAILING SEWER LINE DRAIN LINE GAS LINE ELECTRIC LINE FINISHED FLOOR ELEVATION FFE BITUMINOUS CONCRETE CONC. GRANITE GRAN. BOTTOM CENTER REINFORCED CONCRETE PIPE POLYVINYL CHLORIDE PIPE CORRUGATED METAL PIPE HIGH DENSITY POLYETHYLENE PIPE HDPE

NOTES

- 1. NORTH ARROW IS BASED ON MASSACHUSETTS GRID
- 2. VERTICAL DATUM IS NAVD 88.
- 3. CONTOUR INTERVAL IS ONE FOOT (1').

GRAPHIC SCALE (IN FEET)

COORDINATE SYSTEM (MAINLAND ZONE) (NAD 83).

1 inch = 30 ft.

EXISTING

CONDITIONS

1" = 30'

190042 JACA Project Number

DIG SAFE BEFORE YOU DIG CALL 811 OR 1-888-DIG-SAFE 1-888-344-7233


UTILITY STATEMENT

THE UTILITIES SHOWN HAVE BEEN LOCATED FROM FIELD SURVEY INFORMATION AND EXISTING DRAWINGS. ALLEN & MAJOR ASSOCIATES, INC. (A&M) MAKES NO GUARANTEE THAT THE UTILITIES SHOWN HEREON COMPRISE ALL SUCH UTILITIES IN THE AREA, EITHER IN SERVICE OR ABANDONED. A&M FURTHER DOES NOT WARRANT THAT THE UTILITIES SHOWN ARE IN THE EXACT LOCATION INDICATED. A&M HAS

NOT PHYSICALLY LOCATED THE UNDERGROUND UTILITIES.

Drawing Number: V-101

Drawing Title

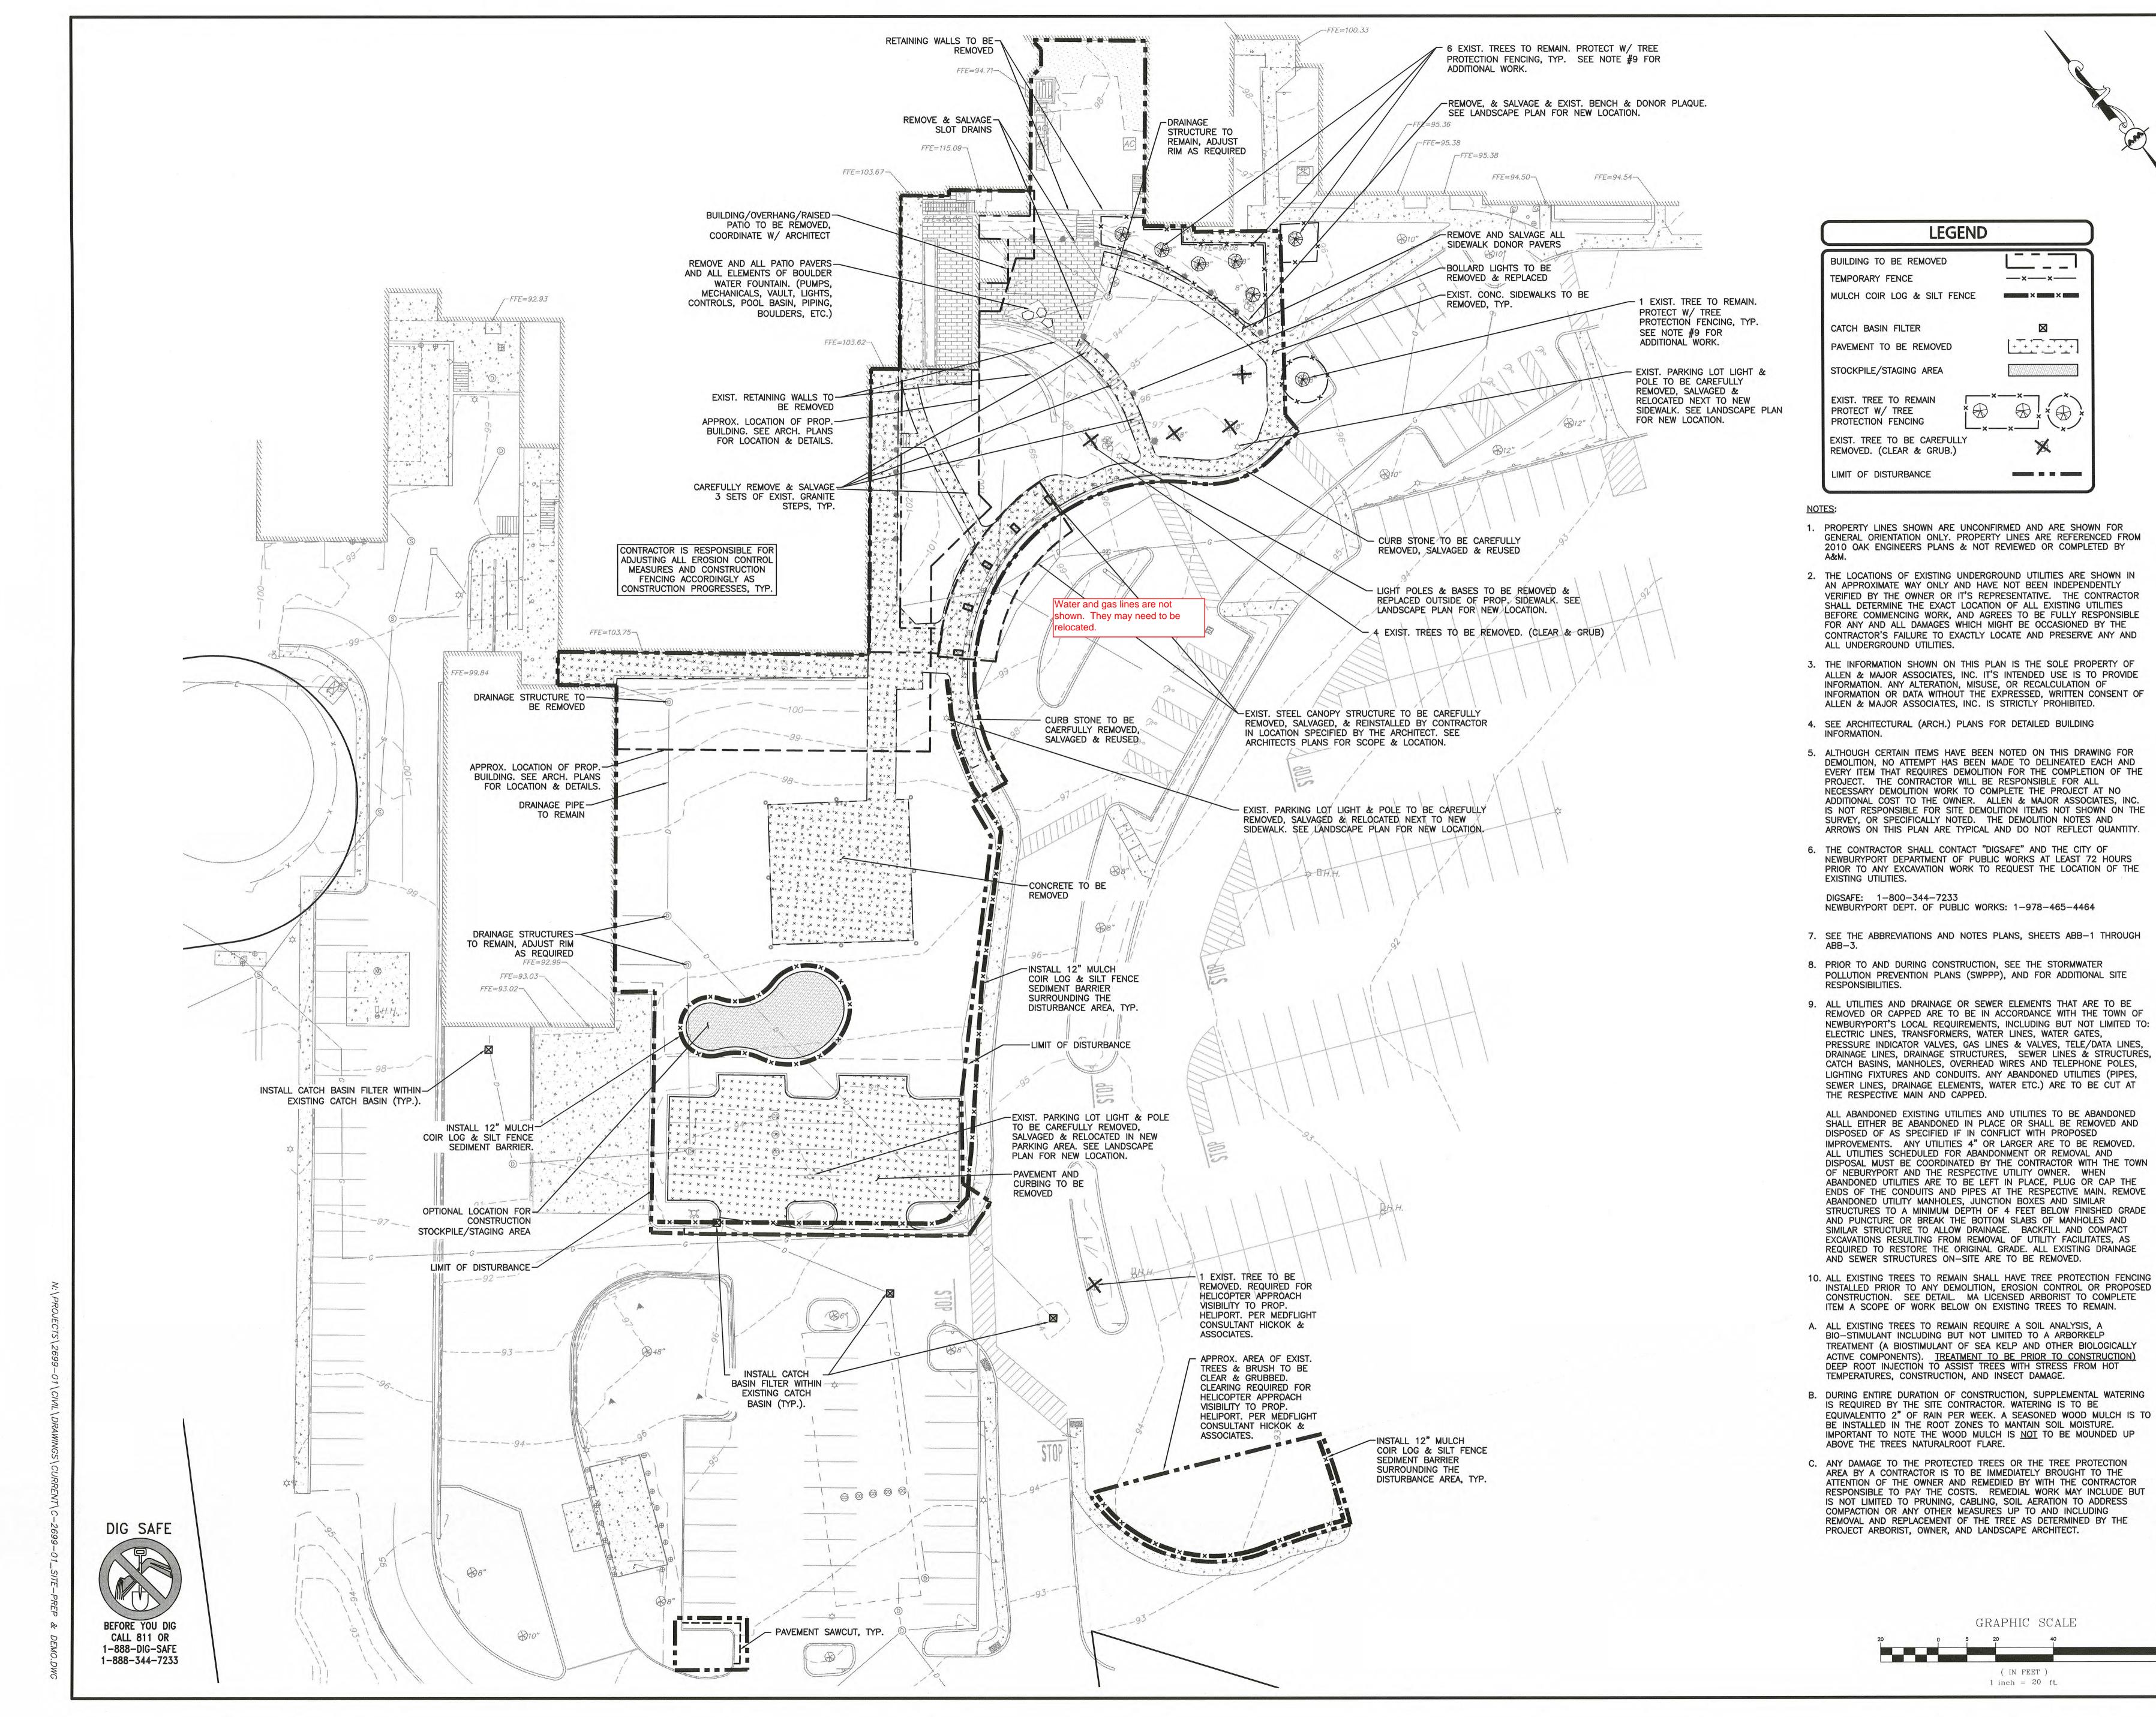

Beth Israel Lahey Health Anna Jaques Hospital

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Consultants

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Property of the Company

MEP/FP ENGINEER R.W. Sullivan Engineering 529 Main St. Suite 203 Boston, MA 02129

Tel. 617.523.8227 LAND SURVEY,

> LANDSCAPE ARCHITECT & CIVIL ENGINEER Allen & Major Associates, Inc 100 Commerce Way, Suite 5 Woburn, MA 01801

STRUCTURAL ENGINEER Schlick Engineering, LLC.

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ISSUED FOR LOCAL PERMITTING 11-25-19 ISSUED FOR SITE PLAN REVIEW 01-08-20 AND SPECIAL PERMIT

Revision Stamp


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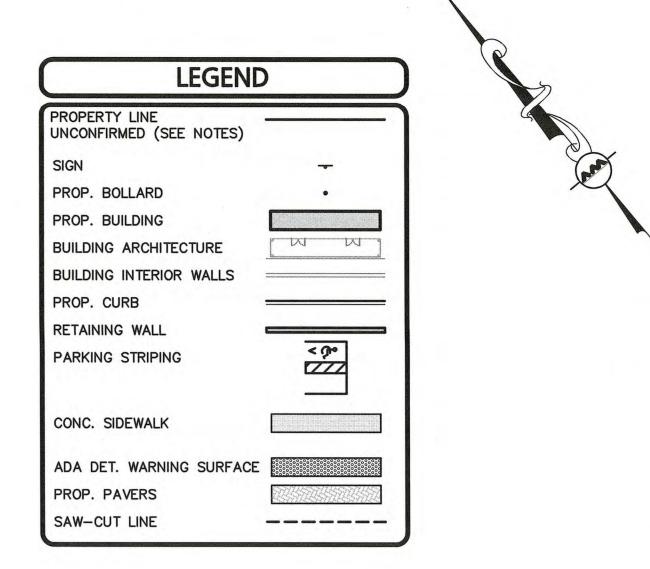
Drawing Title

SITE PREPARATION AND DEMOLITION PLAN

1" = 20' Drawing Number:

190042 JACA Project Number



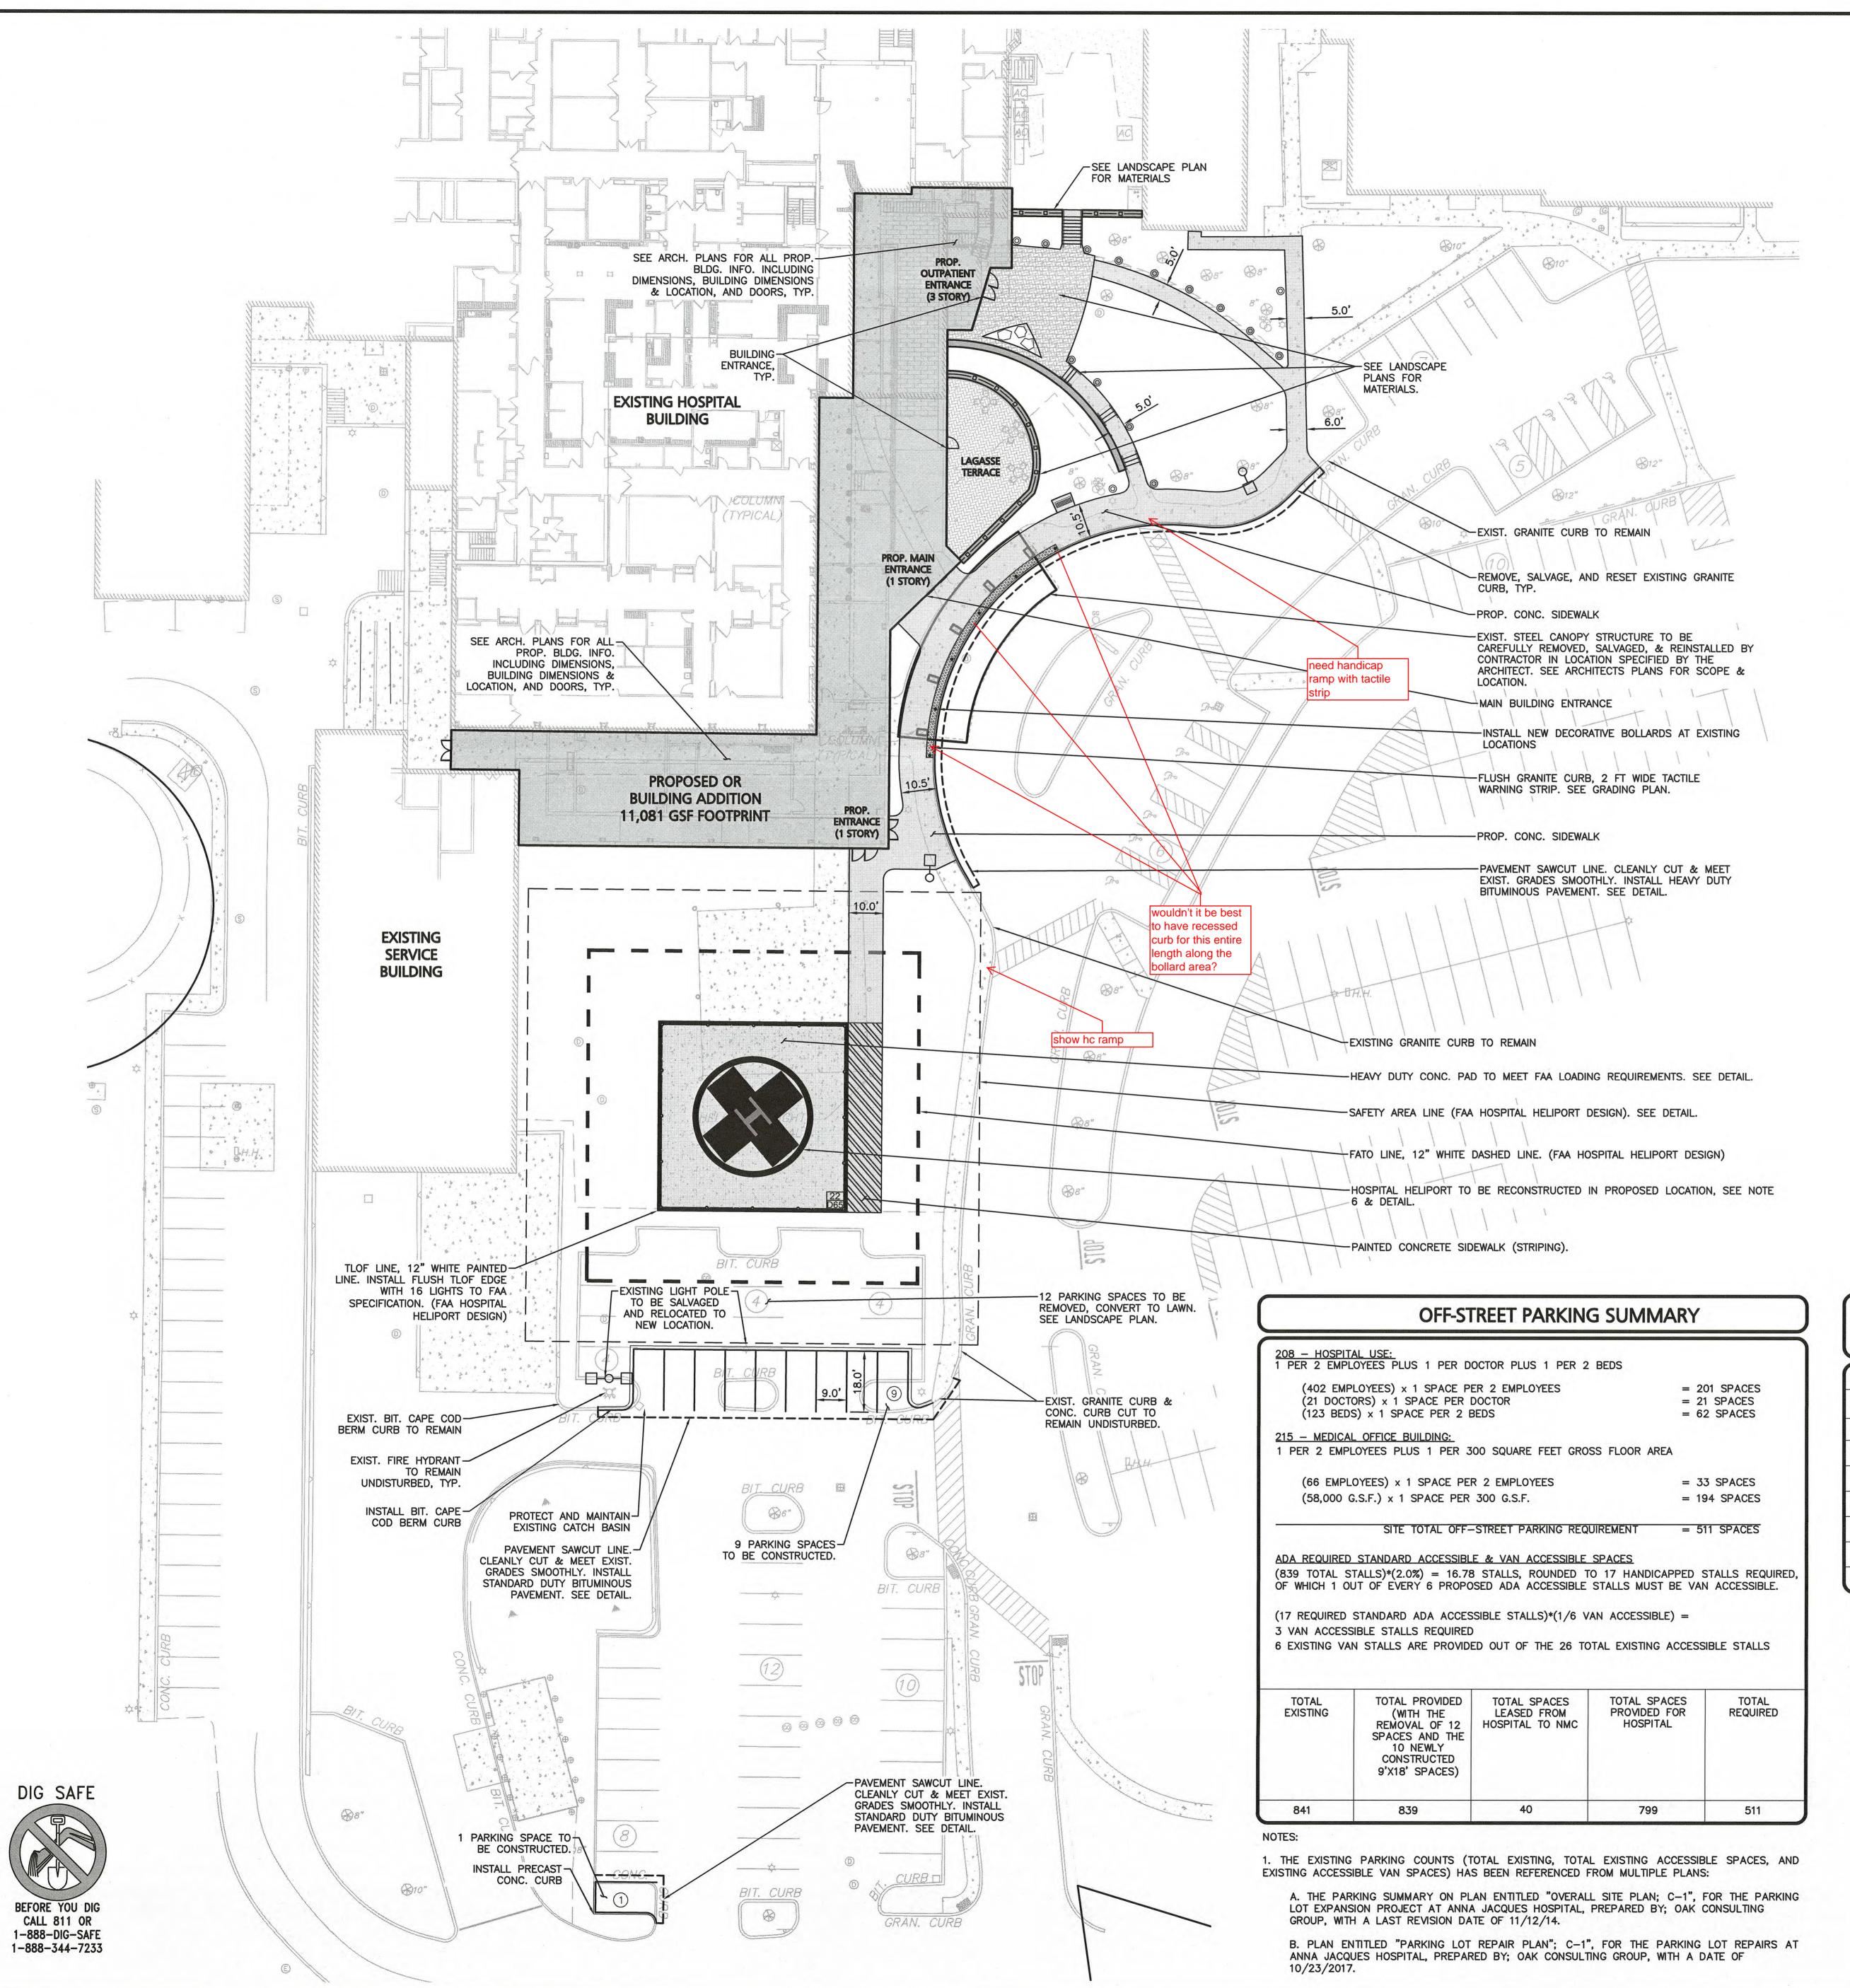

NOTES:


- 1. PROPERTY LINES SHOWN ARE UNCONFIRMED AND ARE SHOWN FOR GENERAL ORIENTATION ONLY. PROPERTY LINES ARE REFERENCED FROM 2010 OAK ENGINEERS PLANS & NOT REVIEWED OR COMPLETED BY A&M.
- 2. THE LOCATIONS OF EXISTING UNDERGROUND UTILITIES ARE SHOWN IN AN APPROXIMATE WAY ONLY AND HAVE NOT BEEN INDEPENDENTLY VERIFIED BY THE OWNER OR IT'S REPRESENTATIVE. THE CONTRACTOR SHALL DETERMINE THE EXACT LOCATION OF ALL EXISTING UTILITIES BEFORE COMMENCING WORK, AND AGREES TO BE FULLY RESPONSIBLE FOR ANY AND ALL DAMAGES WHICH MIGHT BE OCCASIONED BY THE CONTRACTOR'S FAILURE TO EXACTLY LOCATE AND PRESERVE ANY AND ALL UNDERGROUND UTILITIES.
- 3. THE INFORMATION SHOWN ON THIS PLAN IS THE SOLE PROPERTY OF ALLEN & MAJOR ASSOCIATES, INC. IT'S INTENDED USE IS TO PROVIDE INFORMATION. ANY ALTERATION, MISUSE, OR RECALCULATION OF INFORMATION OR DATA WITHOUT THE EXPRESSED, WRITTEN CONSENT OF ALLEN & MAJOR ASSOCIATES, INC. IS STRICTLY PROHIBITED.
- 4. SEE ARCHITECTURAL (ARCH.) PLANS FOR DETAILED BUILDING INFORMATION.
- 5. THE CONTRACTOR SHALL CONTACT "DIGSAFE" AND THE CITY OF NEWBURYPORT DEPARTMENT OF PUBLIC WORKS AT LEAST 72 HOURS PRIOR TO ANY EXCAVATION WORK TO REQUEST THE LOCATION OF THE EXISTING UTILITIES.
- DIGSAFE: 1-800-344-7233 NEWBURYPORT DEPT. OF PUBLIC WORKS: 1-978-465-4464
- 6. HOSPITAL HELIPORT DESIGN BASED UPON FAA DESIGN REGULATIONS (AC 150/5390-2C, CHAPTER 4 HOSPITAL HELIPORTS). THE DESIGN HAS BEEN BASED UPON THE COAST GUARD'S SIK MH-60 JAYHAWK AS THEY WILL BE UTILIZING THE HELIPORT AND THIS IS A LARGER HELICOPTER THAN THE MEDFLIGHT SIK S76. WITHIN THE FAA REGULATIONS THE SIK UH-60L BLACKHAWK DIMENSIONS WERE UTILIZED AS THEY ARE SIMILAR TO THE SIK MH-60 JAYHAWK. SEE
- 7. BUILDING FOOTPRINT PROVIDED TO ALLEN & MAJOR ASSOCIATES FROM CLIENT JACA ARCHITECTS ON NOVEMBER 14, 2019. SEE ARCHITECTURAL PLANS BY JACA ARCHITECTS FOR BUILDING LOCATION, LAYOUT, UTILITY LOCATIONS, DOOR LOCATIONS AND ALL ARCHITECTURAL DETAILS.

LAND USAGE TABLE - GENERAL ACUTE CARE MEDICAL (M-1) USE: 208 - HOSPITAL / 215 - MEDICAL OFFICE BUILDING

ITEM	EXISTING 1	PROPOSED 1,3,4	REQUIRED/ALLOWED
LOT AREA (S.F.)	10.56 AC. (459,913 S.F.)	10.56 AC. ¹ (459,913 S.F.)	4.60 AC. (200,000 S.F.)
FRONTAGE (FEET)	1,451'	1,451'	200'
FRONT YARD SETBACK (FEET)	20'	20'	20'
SIDE YARD SETBACK (FEET)	20'	20'	20'
REAR YARD SETBACK (FEET)	20'	20'	20'
MAX. BUILDING HEIGHT (FEET)	39.4'	36.5'	40'
LOT COVERAGE (%)2	20% (91,983 S.F.)	22% (101,323 S.F.)	50% (229,956 S.F.)
OPEN SPACE (%)	N/A	N/A	N/A

NOTES:

- 1. ALL EXISTING DIMENSIONAL CALCULATIONS & PROPOSED FRONT YARD, SIDE YARD, REAR YARD SETBACKS, HAVE BEEN REFERENCED FROM THE PARKING SUMMARY ON PLAN TITLED "OVERALL SITE PLAN", FOR THE EXPANSION PROJECT AT ANNA JAQUES HOSPITAL, PREPARED BY; OAK ENGINEERS, DATED; 9/8/2010. THE PROPOSED PROJECT DOES NOT CHANGE THE FRONT YARD, SIDE YARD, & REAR YARD SETBACKS AS THE PROPOSED BUILDING ADDITION IS LOCATED ON THE INTERIOR OF THE PROPERTY AND FURTHER AWAY FROM THE PROPERTY LINE THAN THE EXISTING BUILDING.
- 2. LOT COVERAGE. THAT PERCENTAGE OF THE LOT AREA WHICH IS DEVOTED TO BUILDING AREA. (SECTION II - DEFINITIONS 25.)
- 3. PROPOSED BUILDING HEIGHT & STORIES IS FROM JACA ARCHITECTS ON DECEMBER 16, 2019.
- 4. PROPOSED BUILDING FOOTPRINT G.S.F. IS FROM JACA ARCHITECTS ON DECEMBER 16, 2019.

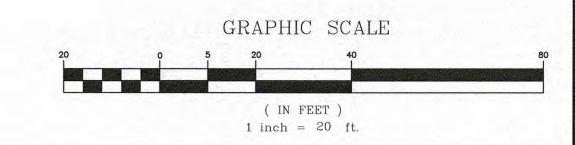

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Allen & Major Associates, Inc. 100 Commerce Way, Suite 5 Woburn, MA 01801 Tel. 781.935.6889

SCHLICK STRUCTURAL ENGINEER Schlick Engineering, LLC. 10 Main Street Lakeville, MA 02347


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NG 11-25-19
12-09-19
W 01-08-20

A&M project number:




Drawing Title

LAYOUT & MATERIALS PLAN

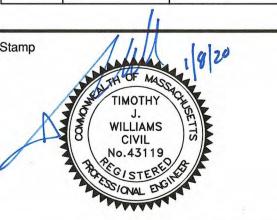Scale: 1'' = 20'

Drawing Number:

JACA Project Number

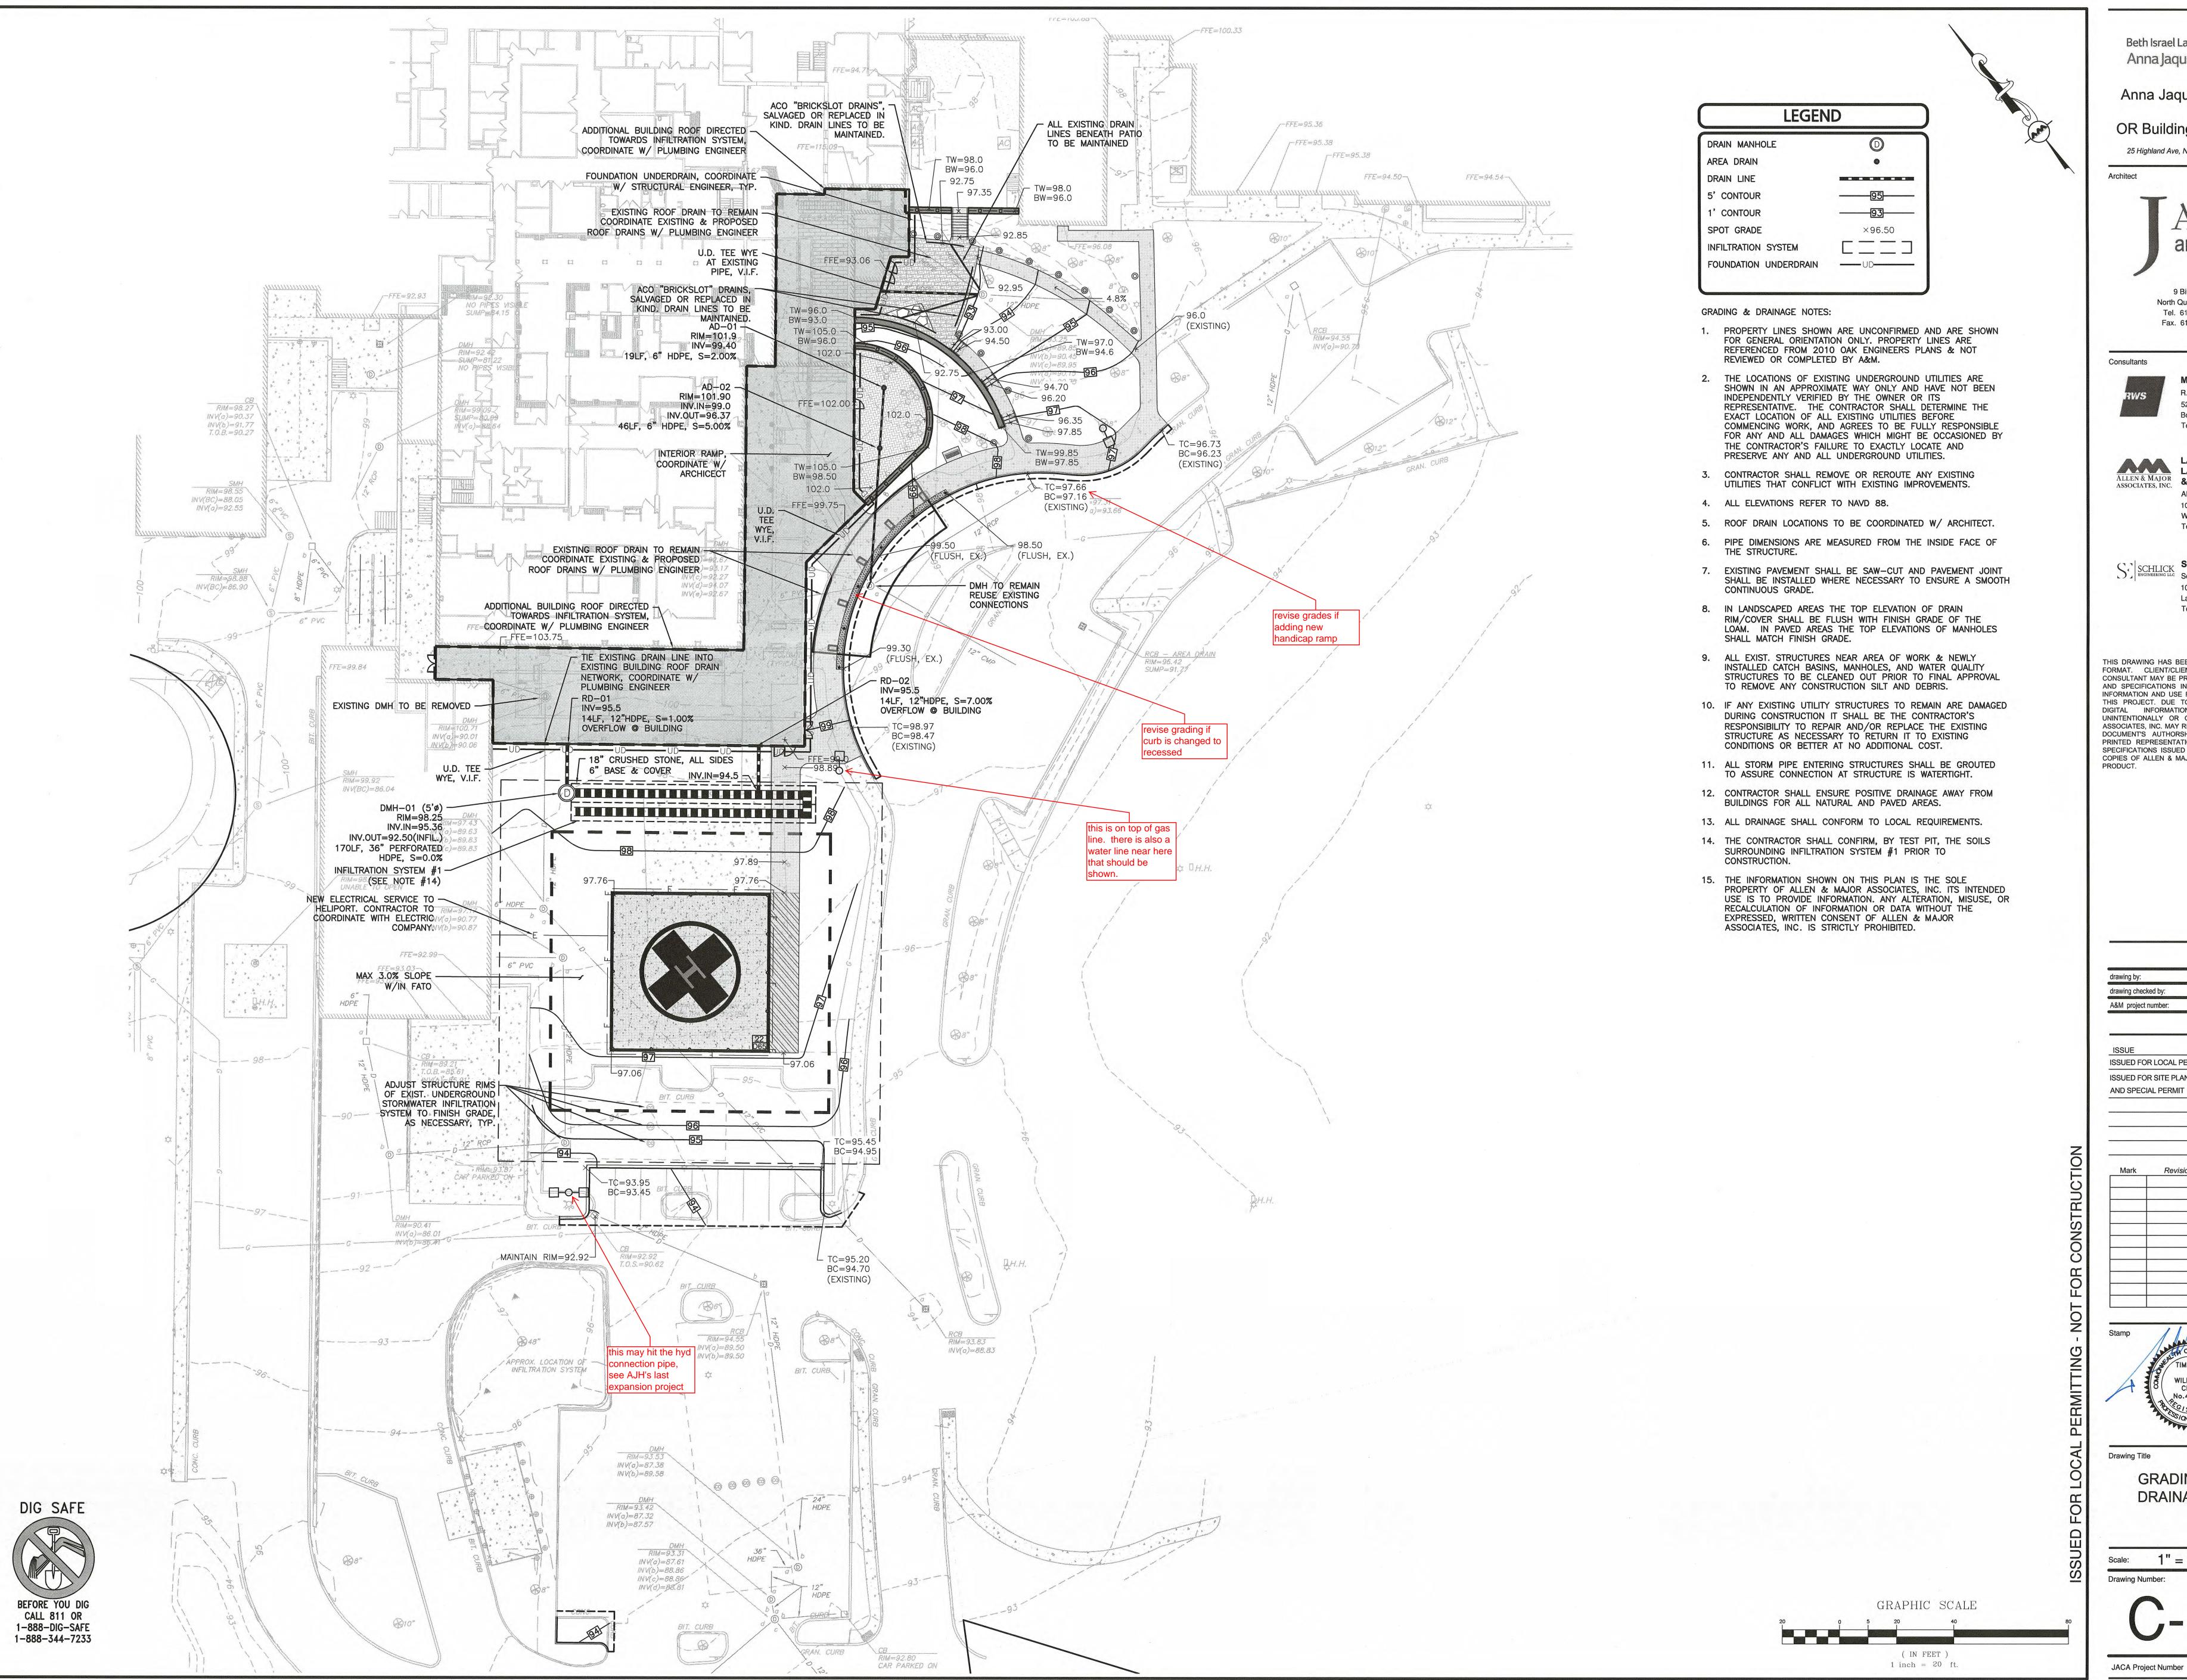

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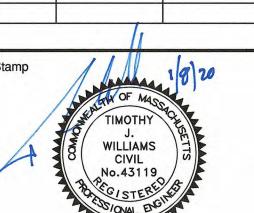
STRUCTURAL ENGINEER SCHLICK Schlick Engineering, LLC. 10 Main Street

Lakeville, MA 02347 Tel. 774.419.3796

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GRADING & DRAINAGE PLAN

Scale: 1'' = 20'Drawing Number:

JACA Project Number

190042

